

BRICK TO MATCH EXISTING: RED VELOUR



BUILDING B - SCJ ENTRY ADDITION - ELEVATION

1/4" = 1'-0"



EXISTING VIEW LOOKING AT ADDITION LOCATION.


SACRED HEART SEMINARY & SCHOOL OF THEOLOGY

NEW RESIDENCES & BUILDING B RENOVATIONS

7335 S. Hwy 100, Franklin, WI 53132

DATE OF ISSUE:	10/5/17
REVISIONS:	
PROJECT #	17022
SITE PLAN AME	NDMENT

BUILDING ELEVATIONS

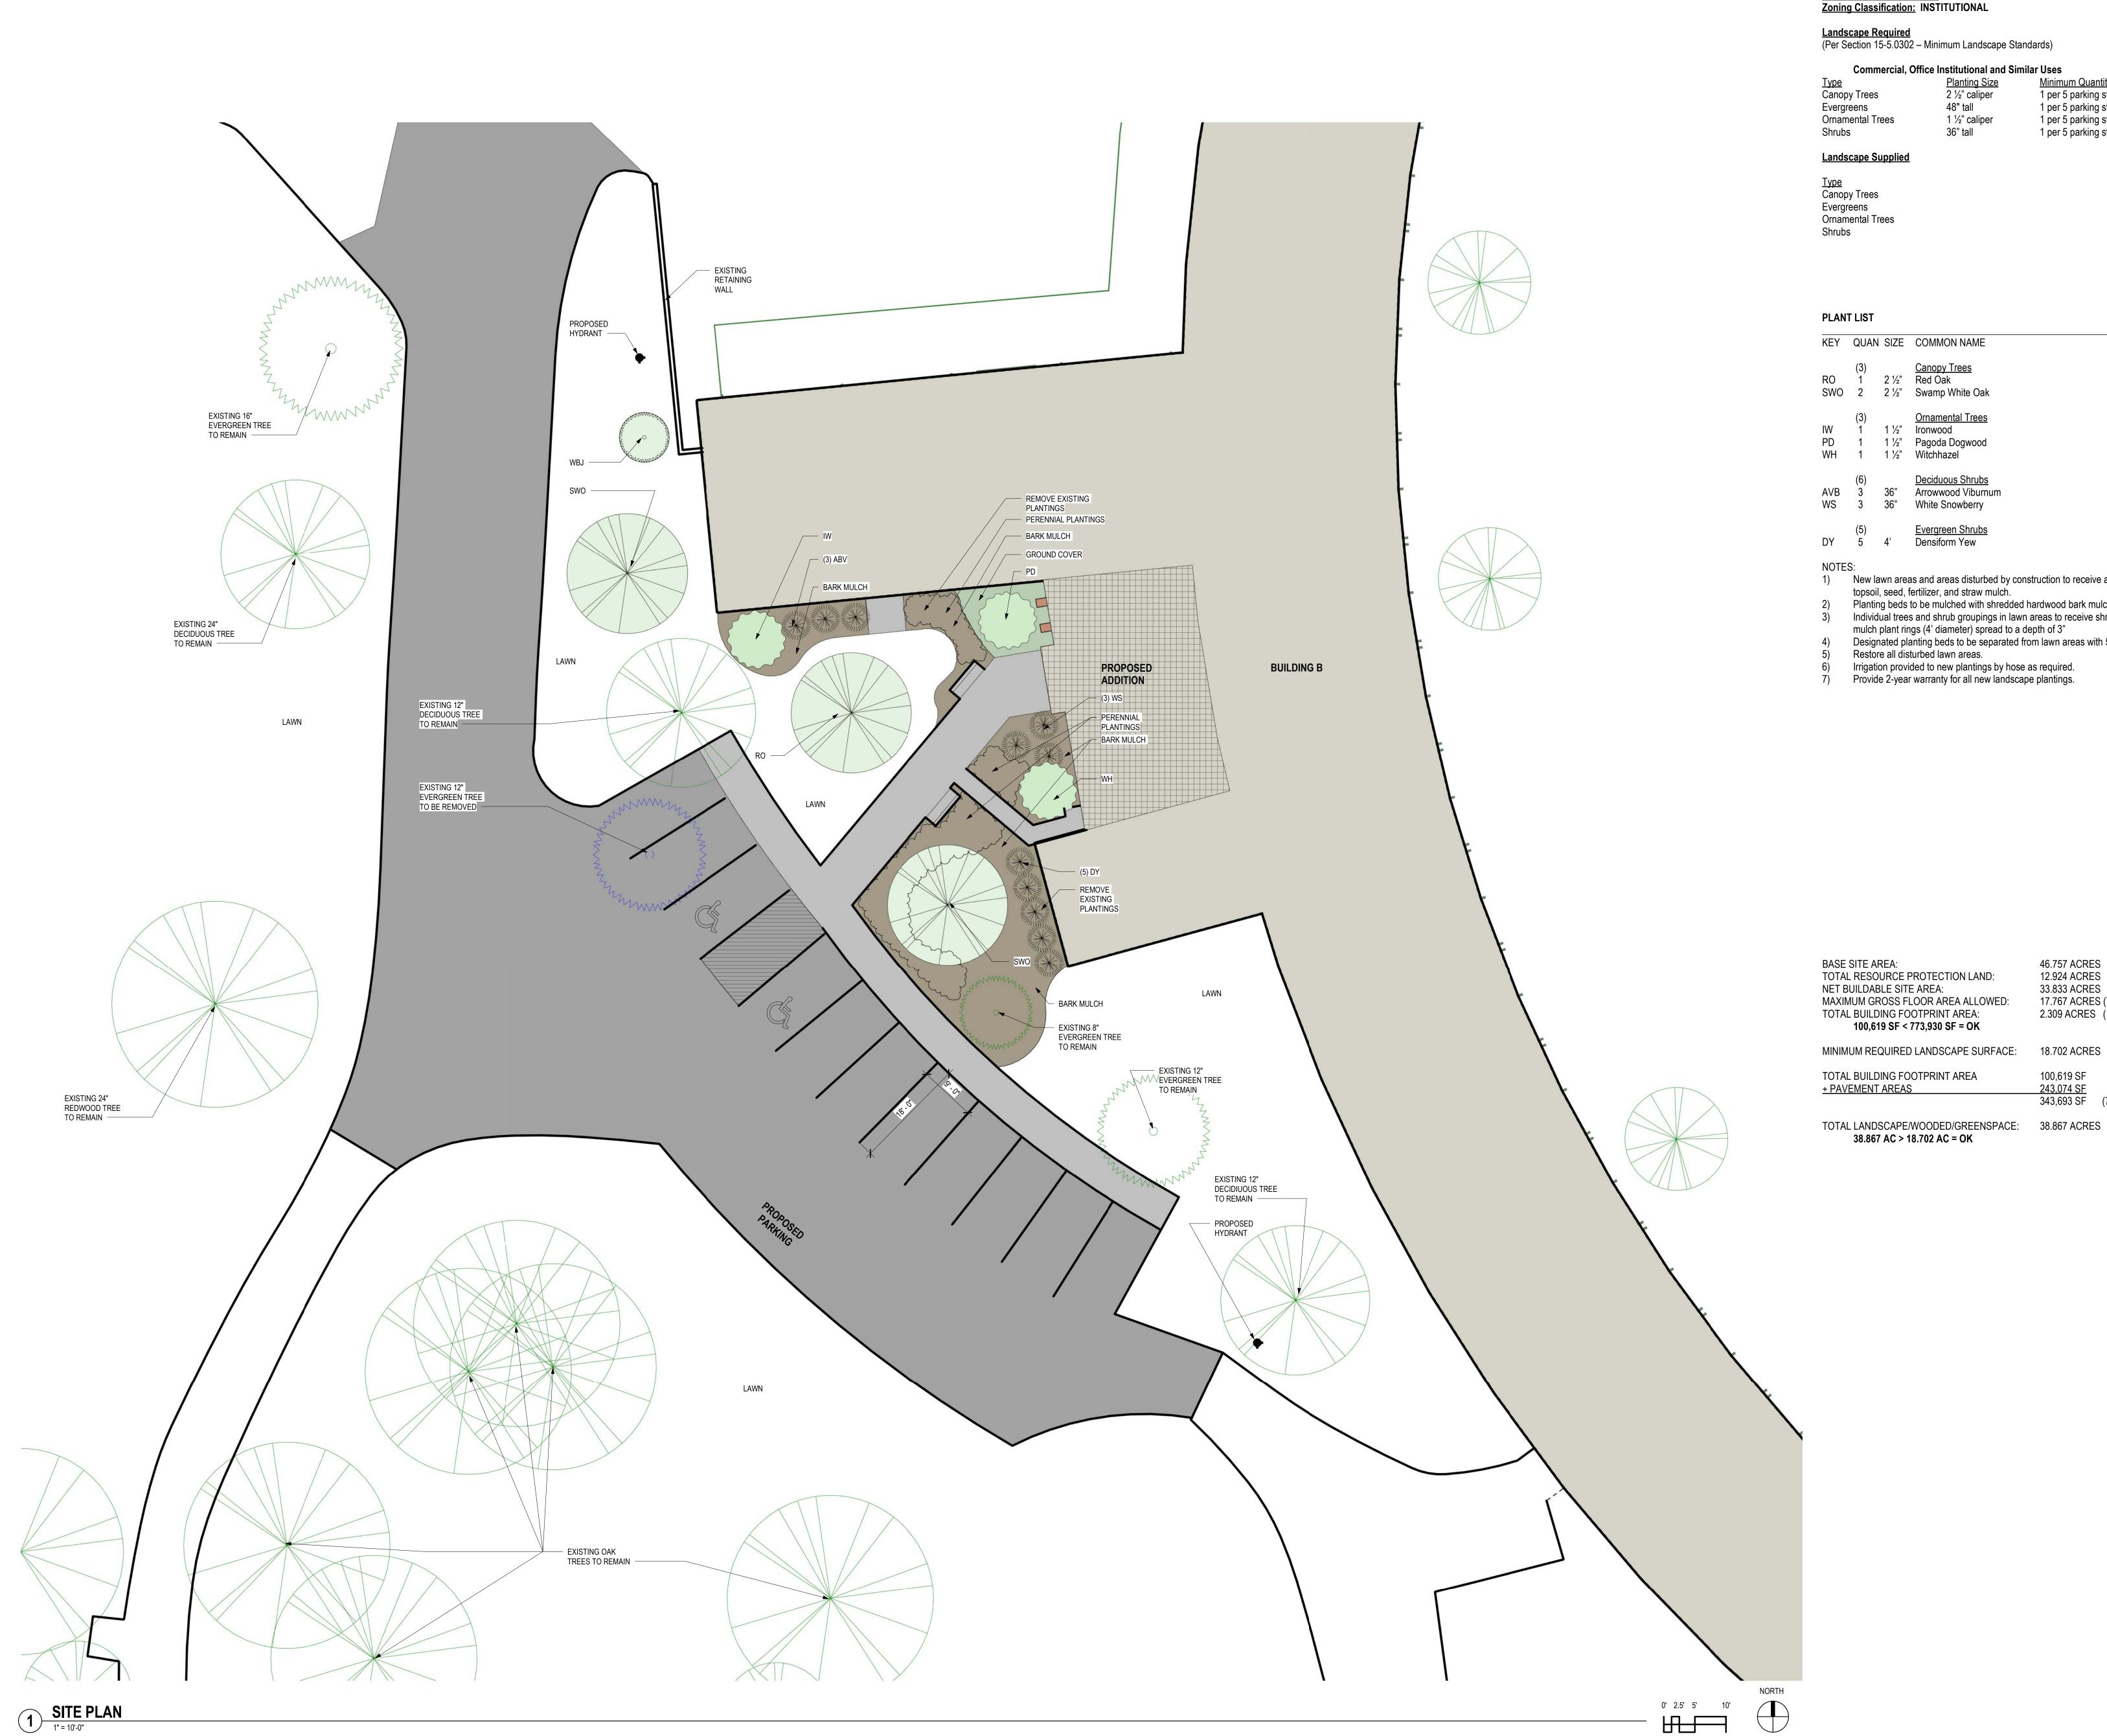

LANDSCAPE WORKSHEET

Zoning Classification: INSTITUTIONAL

<u>Landscape Required</u> (Per Section 15-5.0302 – Minimum Landscape Standards)

Commercial, Office Institutional and Similar Uses <u>Type</u> Canopy Trees 2 ½" caliper 1 per 5 parking stalls 48" tall 1 per 5 parking stalls Evergreens 1 per 5 parking stalls Ornamental Trees 1 ½" caliper 1 per 5 parking stalls Shrubs

Landscape Supplied

<u>Type</u> Canopy Trees <u>Total</u> 3 (NEW) 4 (EXISTING) Evergreens Ornamental Trees 3 (+1 EXISTING) Shrubs

DIMENSIONI

Madison Design Group architecture · engineering · interior design

6515 Grand Teton Plaza, Suite 120 Madison, Wisconsin 53719 p608.829.4444 f608.829.4445

dimensionivmadison.com

PAUL SKIDMORE LANDSCAPE ARCHITECT LLC 13 RED MAPLE TRAIL; MADISON, WI 53717 P: (608) 826-0032 E: paulskidmore@tds.net

PLANT LIST

KEY	QUAN	SIZE	COMMON NAME	ROOT
RO SWO	(3) 1 2	2 ½" 2 ½"	Canopy Trees Red Oak Swamp White Oak	BB BB
IW PD WH	(3) 1 1 1	1 ½" 1 ½" 1 ½"	Ornamental Trees Ironwood Pagoda Dogwood Witchhazel	BB BB BB
AVB WS	(6) 3 3	36" 36"	<u>Deciduous Shrubs</u> Arrowwood Viburnum White Snowberry	Pot Pot
DY	(5) 5	4'	Evergreen Shrubs Densiform Yew	BB

1) New lawn areas and areas disturbed by construction to receive a minimum of 4" of topsoil, seed, fertilizer, and straw mulch.

Planting beds to be mulched with shredded hardwood bark mulch. Individual trees and shrub groupings in lawn areas to receive shredded hardwood bark

mulch plant rings (4' diameter) spread to a depth of 3" Designated planting beds to be separated from lawn areas with 5" black vinyl edge. Restore all disturbed lawn areas.

46.757 ACRES 12.924 ACRES

33.833 ACRES

18.702 ACRES

100,619 SF

17.767 ACRES (773,930 SF)

2.309 ACRES (100,619 SF)

243,074 SF 343,693 SF (7.89 ACRES)

Irrigation provided to new plantings by hose as required. Provide 2-year warranty for all new landscape plantings.

100,619 SF < 773,930 SF = OK

38.867 AC > 18.702 AC = OK

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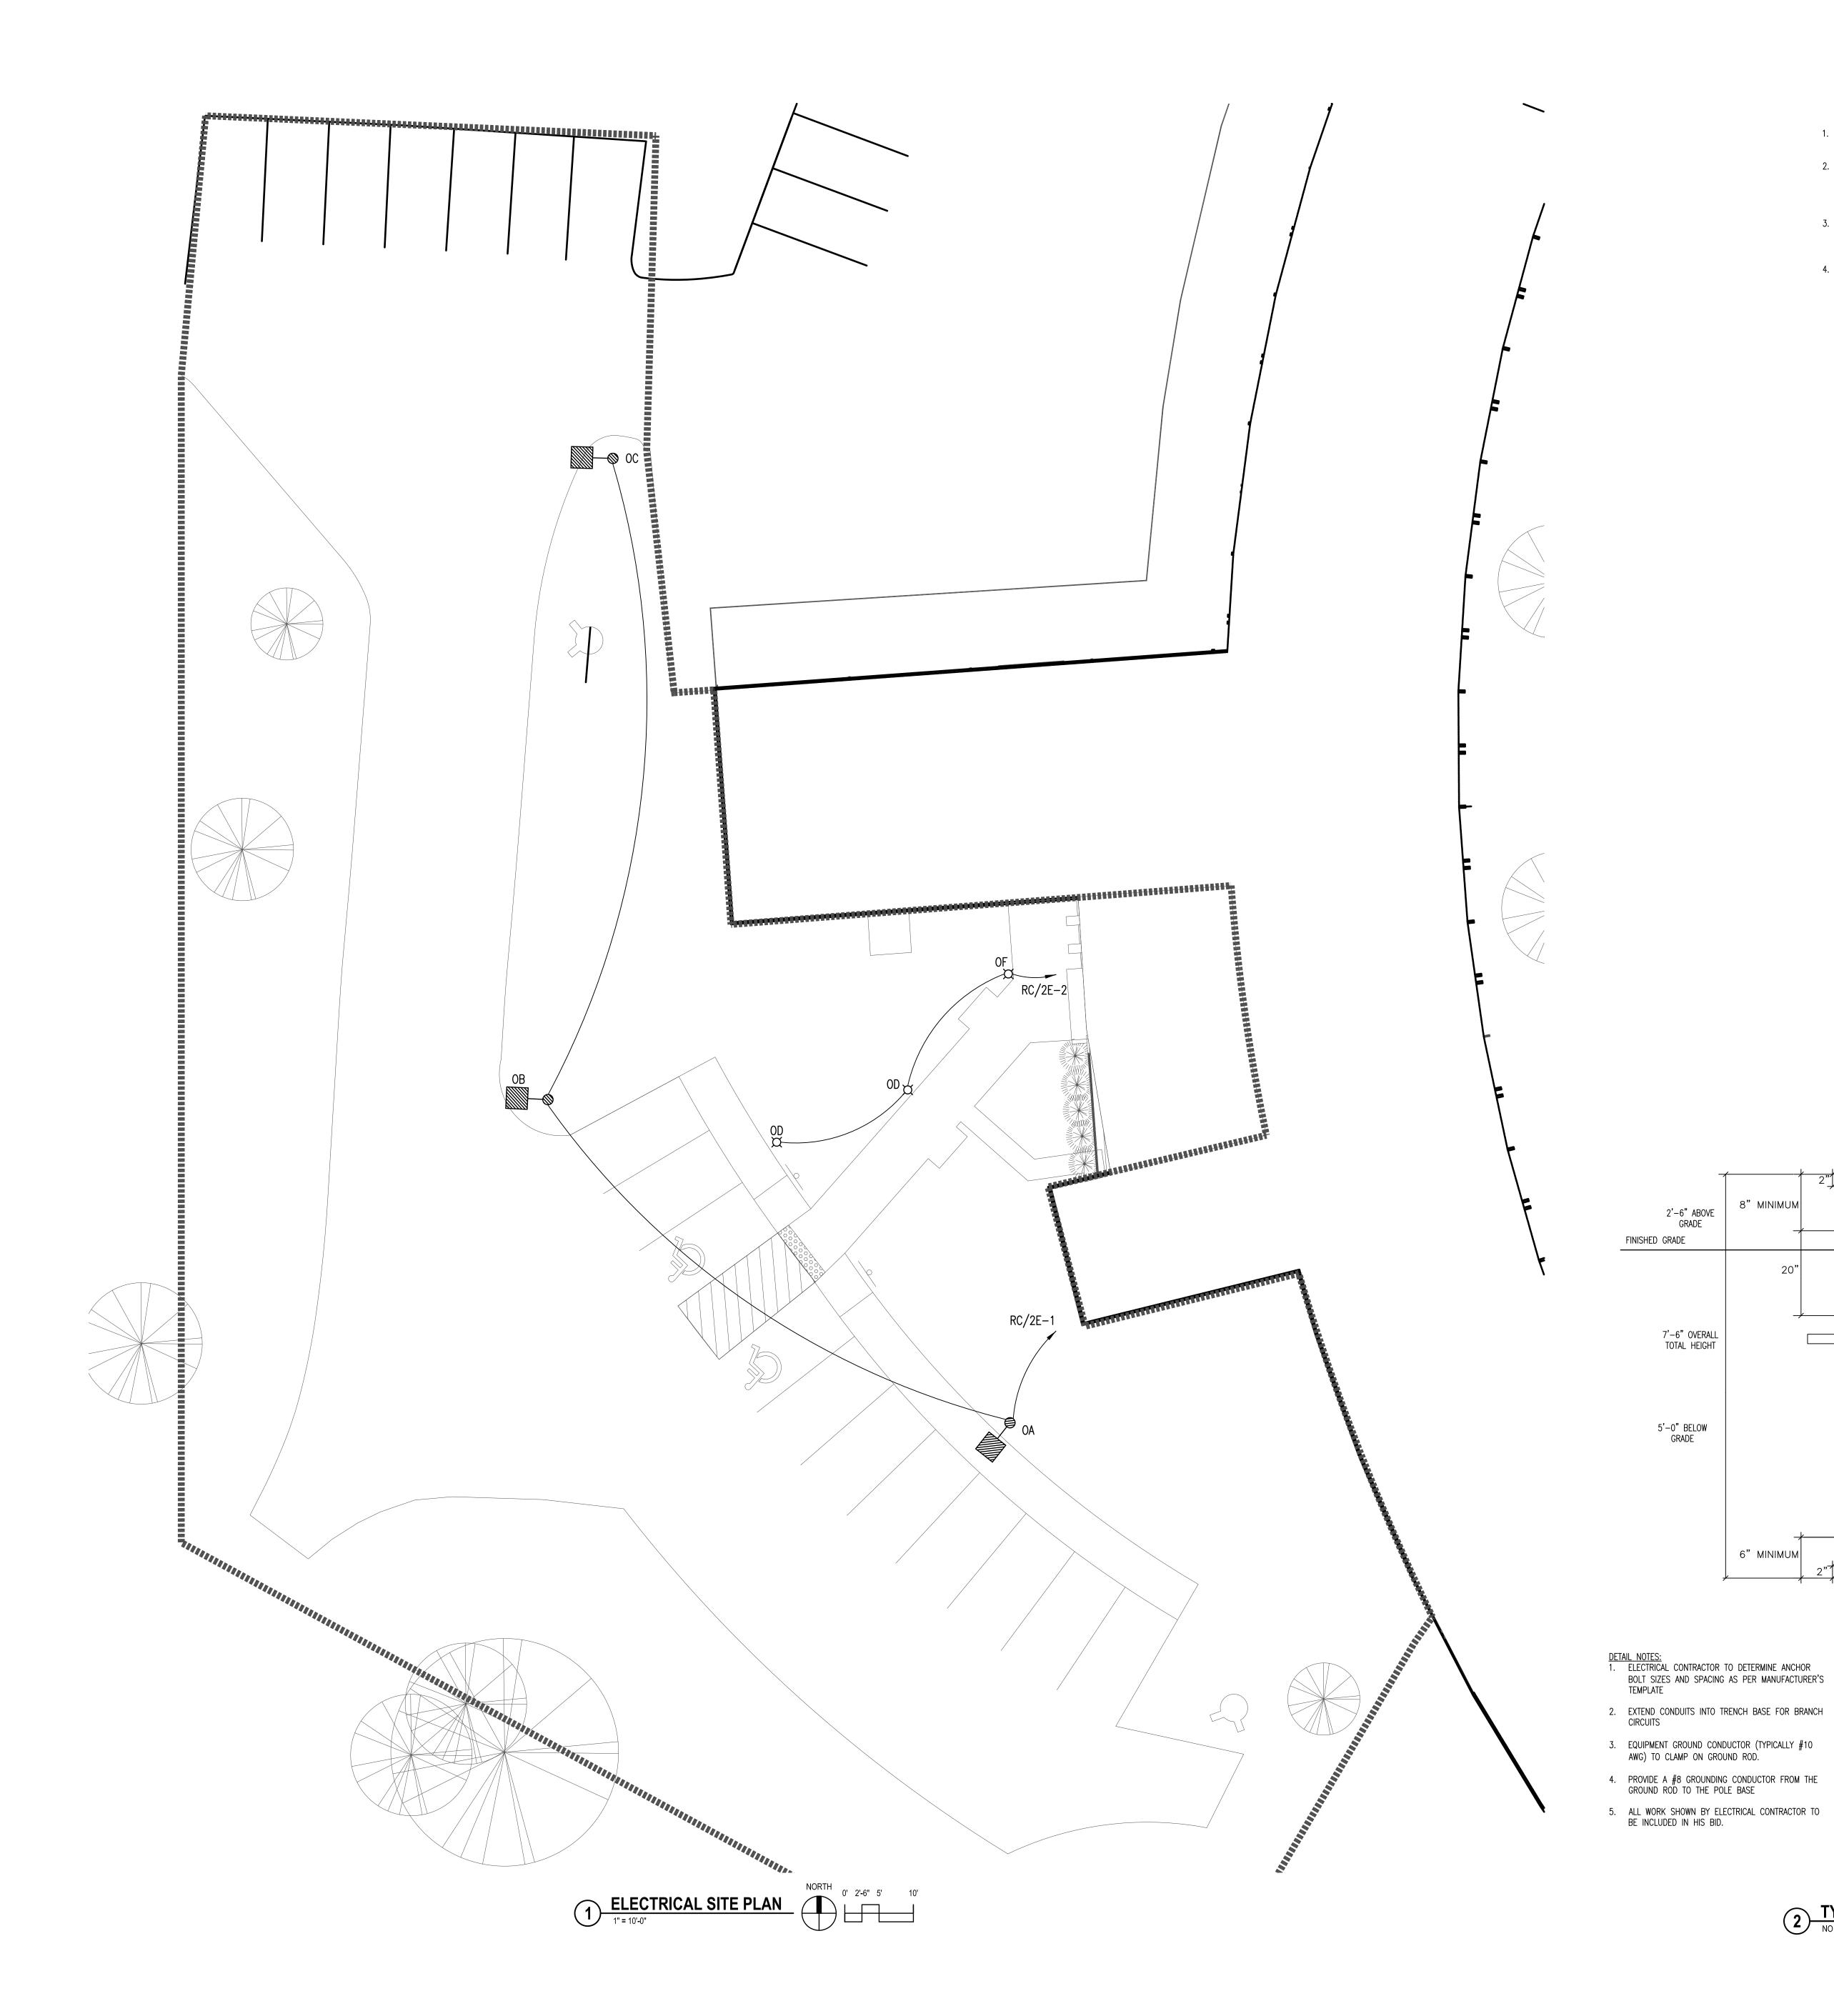
DATE OF ISSUE: 10/05/17 **REVISIONS:**

> 17022 PROJECT#

SITE PLAN AMENDMENT

LANDSCAPE PLAN

LS1.00



GENERAL NOTES - SITE PLAN

BACKFILL REMAINDER WITH CLEAN GRANULAR FILL.

- CONTRACTOR SHALL VISIT THE JOB SITE AND FAMILIARIZE HIMSELF WITH EXISTING CONDITIONS PRIOR TO SUBMITTING BID.
- 2. ALL EXTERIOR LIGHT BRANCH CIRCUIT WIRING (INCLUDING ANY SITE MONUMENT SIGNS) SHALL BE AS INDICATED IN 1" SCHEDULE 40 HWPVC 42" BELOW FINISHED GRADE. BACKFILL FIRST 18" WITH TAMPED SAND (TAMPED EVERY 6") AND MARK WITH PLASTIC RED WARNING TAPE,
- 3. ALL CONDUITS ENTERING BUILDING (FOR POWER OR LOW-VOLTAGE) SHALL BE SEALED TO PREVENT WATER AND DIRT ENTRY AS NEEDED. CONDUITS 3" AND LARGER SHALL USE "LINK-SEALS".
- 4. FINISH ON EXTERIOR SITE LIGHTING: POLES, LUMINAIRE, AND POLE BASE COVER TO MATCH.

GROUNDING TYPE BUSHING

LOCK WASHER (TYPICAL)

APPLY LUBRICANT SUCH AS "ANTI-SEIZE" TO ALL BASE BOLTS

FORM ALL EXPOSED CONCRETE.
PROVIDE A 3/4" RADIUS BULLNOSE ALL
AROUND

HEAVY WALL SCHEDULE 80 PVC CONDUIT AT 36" BELOW FINISHED GRADE.

5/8" DIAMETER X 10-0" COPPER CLAD GROUND ROD REQUIRED AT EACH POLE BASE

— BOLT CIRCUIT AS REQUIRED BY POLE MANUFACTURER (SEE NOTE 1)

5/8" x 10'-0" COPPER GROUND ROD

ANCHOR BOLTS SHALL BE ORIENTED PARALLEL TO THE CURB LINE

CONDUCTOR/CONDUIT

— STUB CONDUIT UP WITH BASE DIAMETER

— 4" L-BEND (TYPICAL)

FINISHED GRADE

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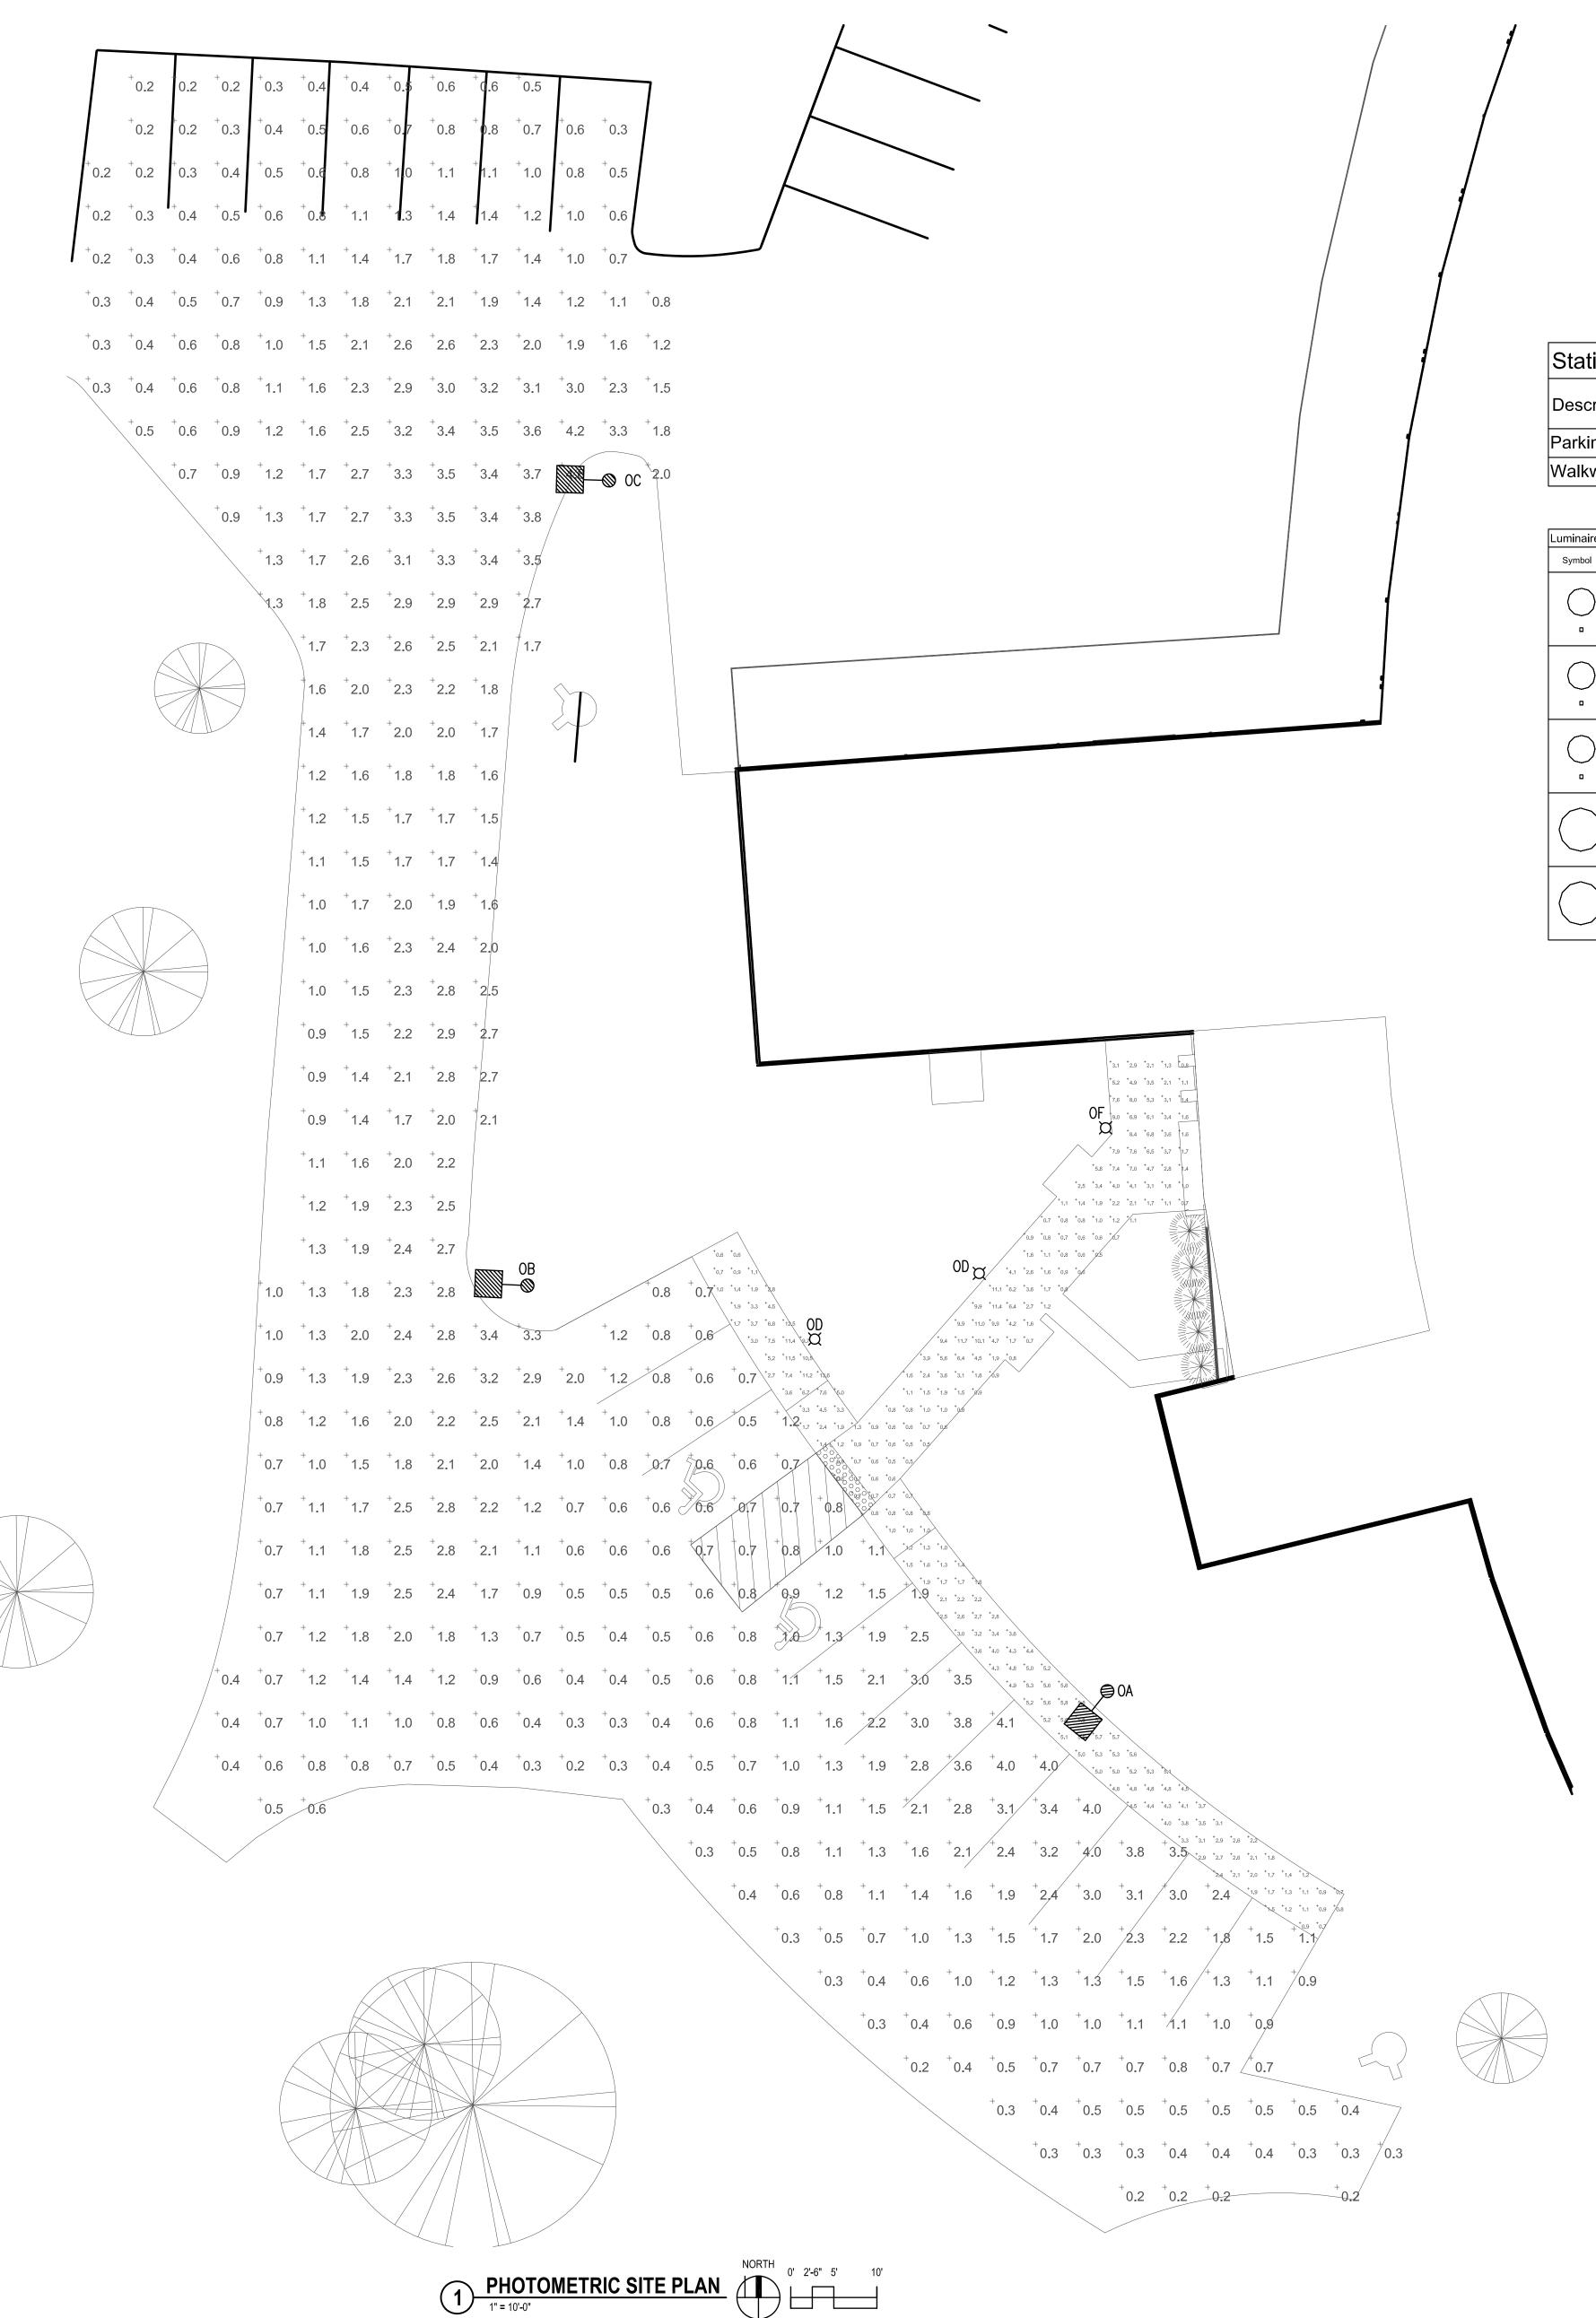
PROJECT #

SITE PLAN AMENDMENT

ELECTRICAL SITE PLAN

2 TYPICAL CONCRETE POLE BASE DETAIL
NO SCALE

8" MINIMUM



GENERAL NOTES - PHOTOMETRIC PLAN

- 1. SIMULATIONS WERE CONDUCTED USING VISUAL 2012 LIGHTING ANALYST SOFTWARE.
- 2. A 0.85 LIGHT LOSS FACTOR WAS USED IN PHOTOMETRIC SIMULATIONS FOR THE LED LUMINAIRES THAT ARE PROPOSED FOR INSTALLATION.
- 3. ALL ILLUMINATION VALUES INDICATED ON THIS PLAN ARE LOCATED AT GRADE.
- 4. REFER TO THE BID SET DOCUMENTS FOR A COMPLETE LIST OF ALL LUMINAIRES USED FOR THESE PHOTOMETRIC PLANS.
- 5. GRADE IS ASSUMED FLAT.
- 6. ALL POLE MOUNTED AREA LIGHTS (TYPES OA, OB, & OC) ARE MOUNTED AT A HEIGHT OF 20'-0" ABOVE GRADE.

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Statistics						
Description	Symbol	Avg	Max	Min	Max/Min	Avg/Min
Parking Area	+	1.4 fc	4.8 fc	0.2 fc	24.0:1	7.0:1
Walkway	+	3.3 fc	13.6 fc	0.5 fc	27.2:1	6.6:1

Luminaire So	chedule										
Symbol	Label	Quantity	Manufacturer	Catalog Number	Description	Lamp	Number Lamps	Filename	Lumens Per Lamp	Light Loss Factor	Wattage
	OA	1	Cyclone Lighting	CY55P1A-FGC-3-100W-4K	CYCLONE LIGHTING BELL SHAPED PENDANT LED FIXTURE WITH INDIVIDUAL LED LENS OPTICS AND CLEAR FLAT LENS	50 White LEDs	1	DOMIA-CY55P1A-FGC-3- 100W-4K (K617Cm).IES	11903.06	0.85	112
	ОВ	1	Cyclone Lighting	CY55P1A-FGC-3M-100W-4K	CYCLONE LIGHTING BELL SHAPED PENDANT LED FIXTURE WITH INDIVIDUAL LED LENS OPTICS AND CLEAR FLAT LENS	50 White LEDs	1	DOMIA-CY55P1A-FGC-3M- -100W-4K (K618Cm).IES	10629.18	0.85	112
	OC	1	Cyclone Lighting	CY55P1A-FGC-4-100W-4K	CYCLONE LIGHTING BELL SHAPED PENDANT LED FIXTURE WITH INDIVIDUAL LED LENS OPTICS AND CLEAR FLAT LENS	50 White LEDs	1	DOMIA-CY55P1A-FGC-4- 100W-4K (K619Cm).IES	11699.36	0.85	112
	OD	2	Cree Inc	PWY-EDG-3M-xx-02-E-UL-350- 40K / BXBPx318E-UH7	Cree Edge Pathway Luminaire, Type III Medium, 18 LEDs, 120-277V, 350mA, 4000K	Eighteen type XP-G2 LEDs	1	PWY-EDG-3M-xx-02-E-UL- -350-40K_PL05698- 001.IES	1469.611	0.85	21.2
	OF	1	Cree Inc	PWY-EDG-5M-xx-02-E-UL-350- 40K / BXBPx518E-UH7	Cree Edge Pathway Luminaire, Type V Medium, 18 LEDs, 120-277V, 350mA, 4000K	Eighteen type XP-G2 LEDs	1	PWY-EDG-5M-xx-02-E-UL- -350-40K_PL05798- 001A.IES	1779.355	0.85	21.3

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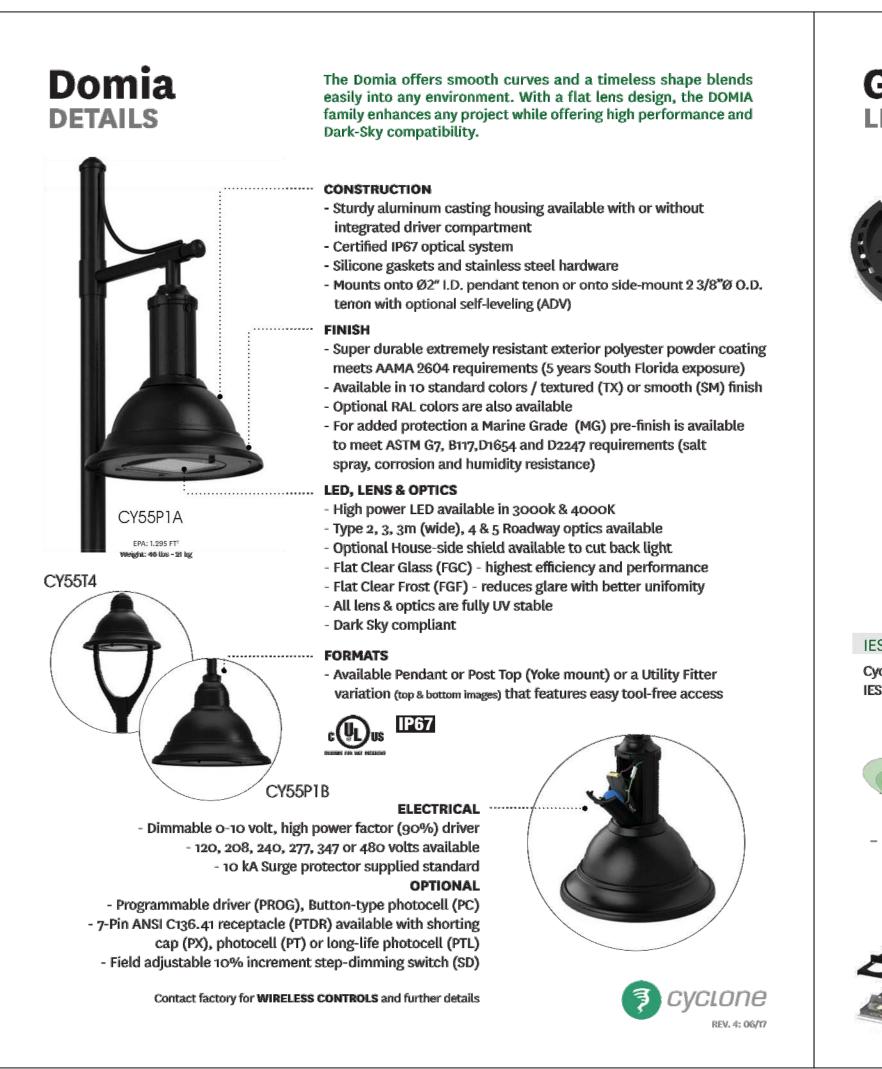
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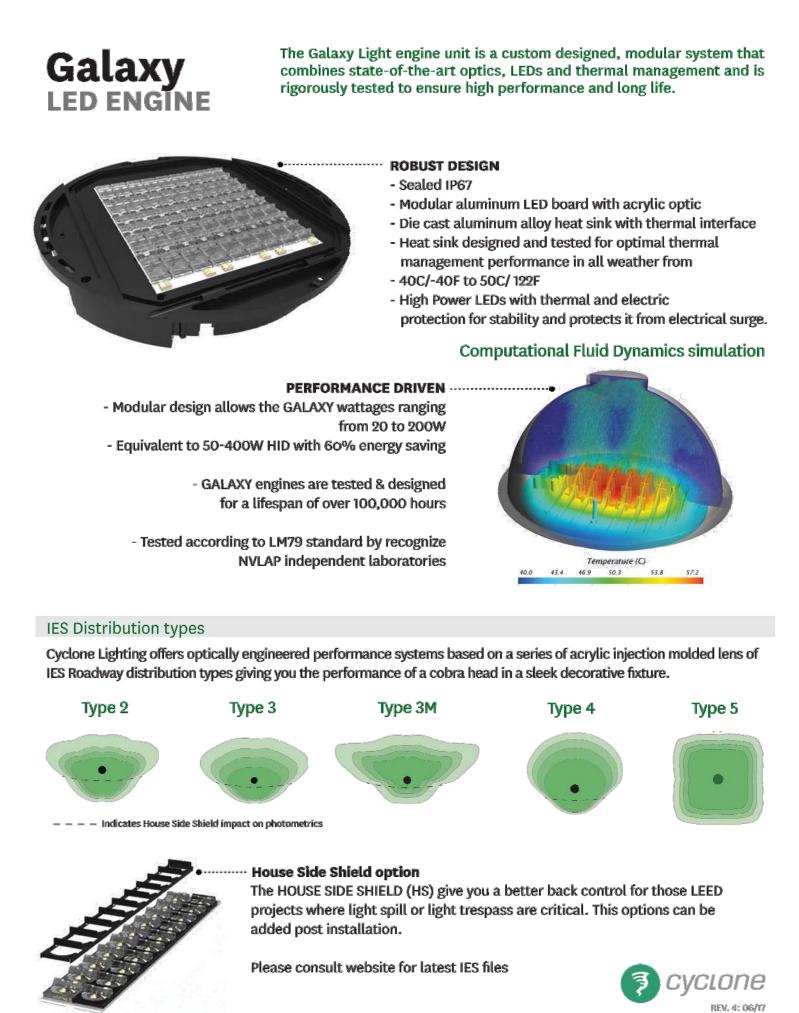
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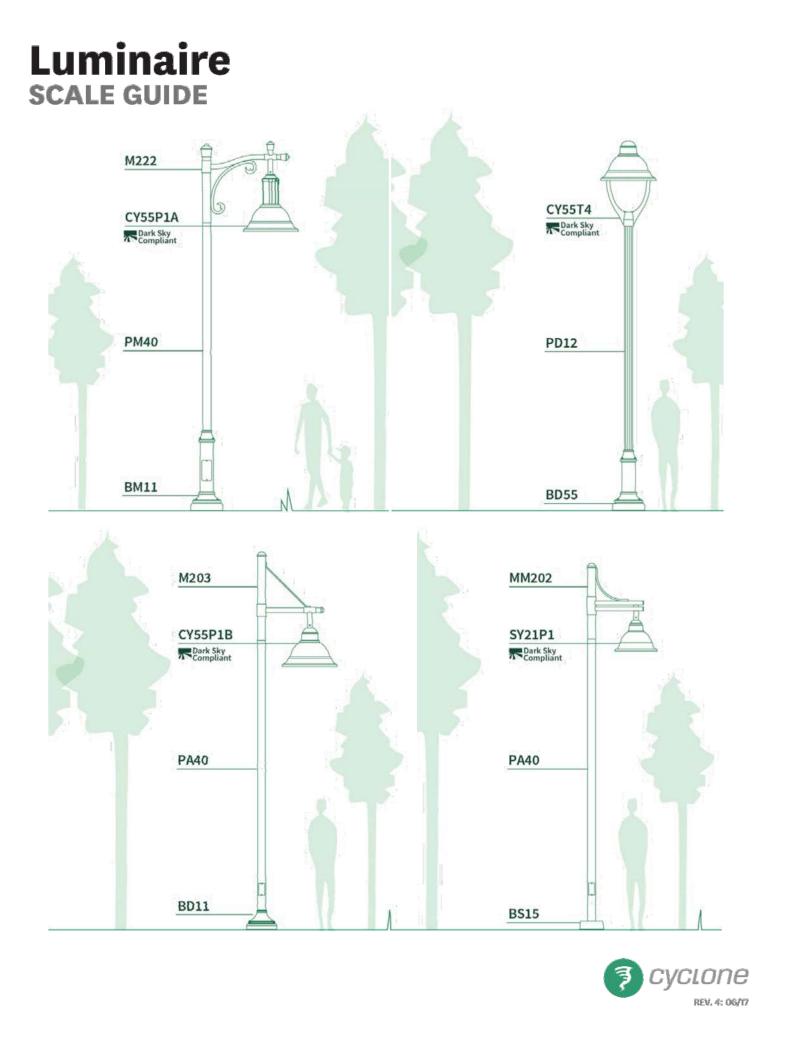
0.1507 # 1700


SITE PLAN AMENDMENT

PHOTOMETRIC SITE PLAN









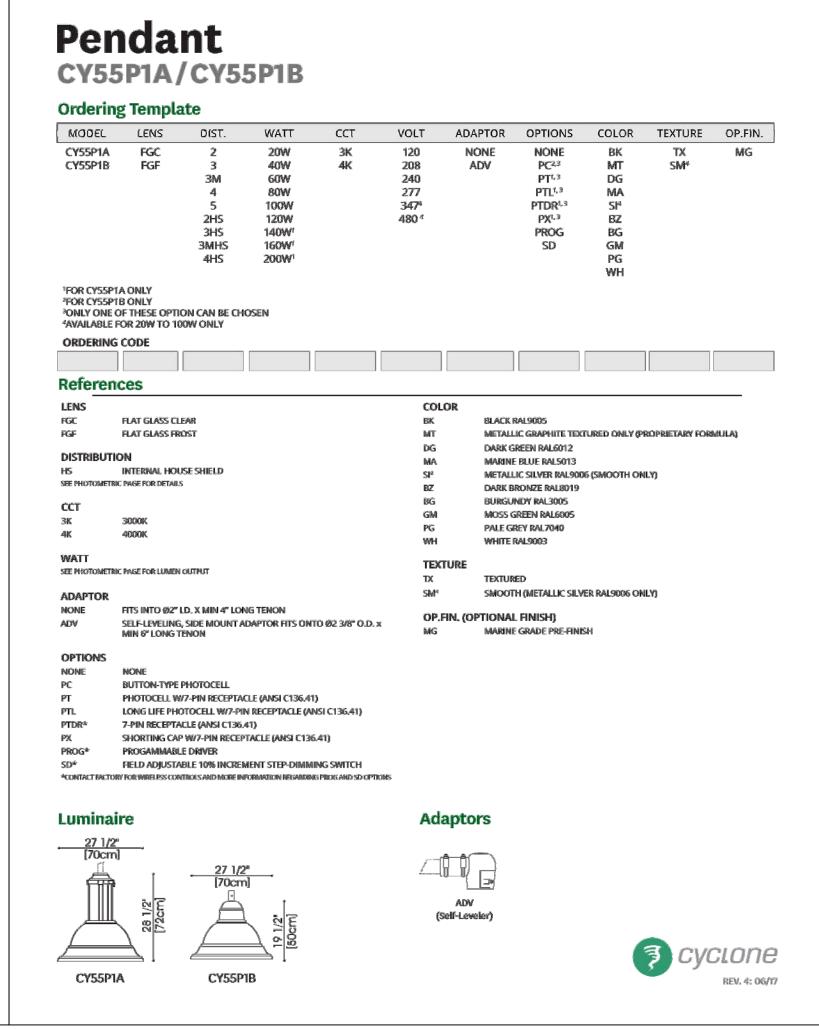





LIGHTING CUT SHEET - "DOMIA" POLE MOUNTED AREA LIGHT - FIXTURE TYPES "OA", "OB", AND "OC"

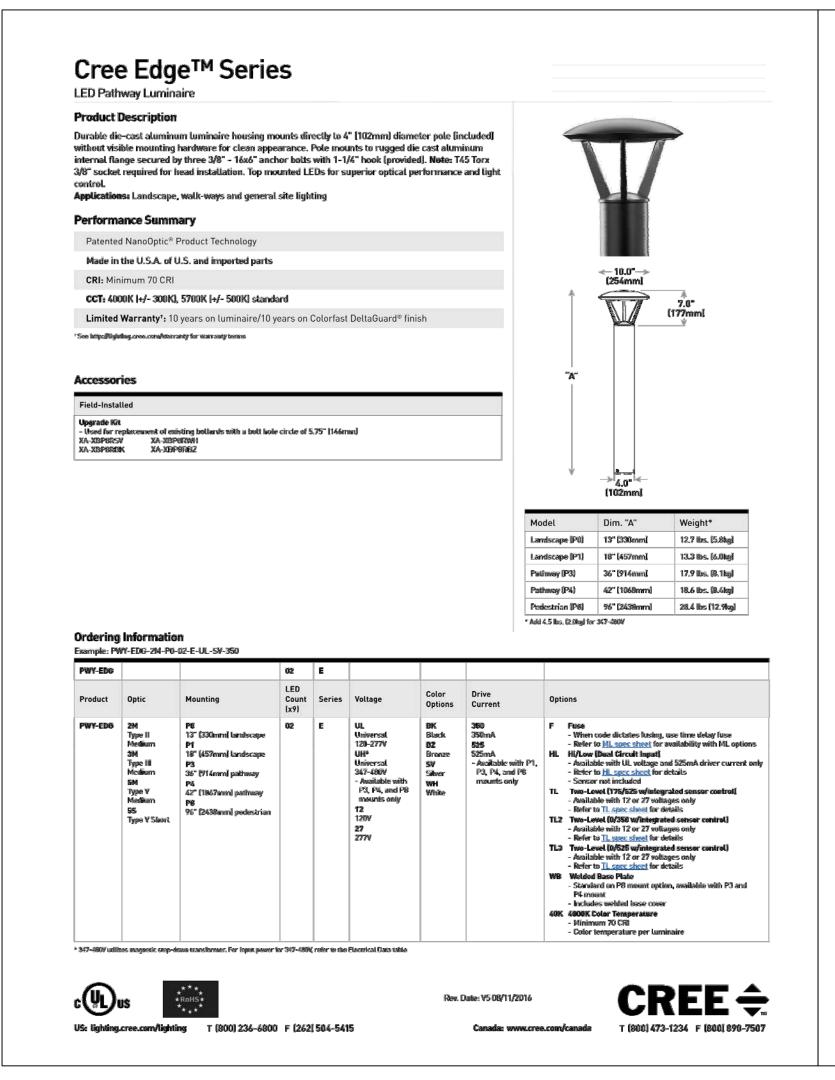

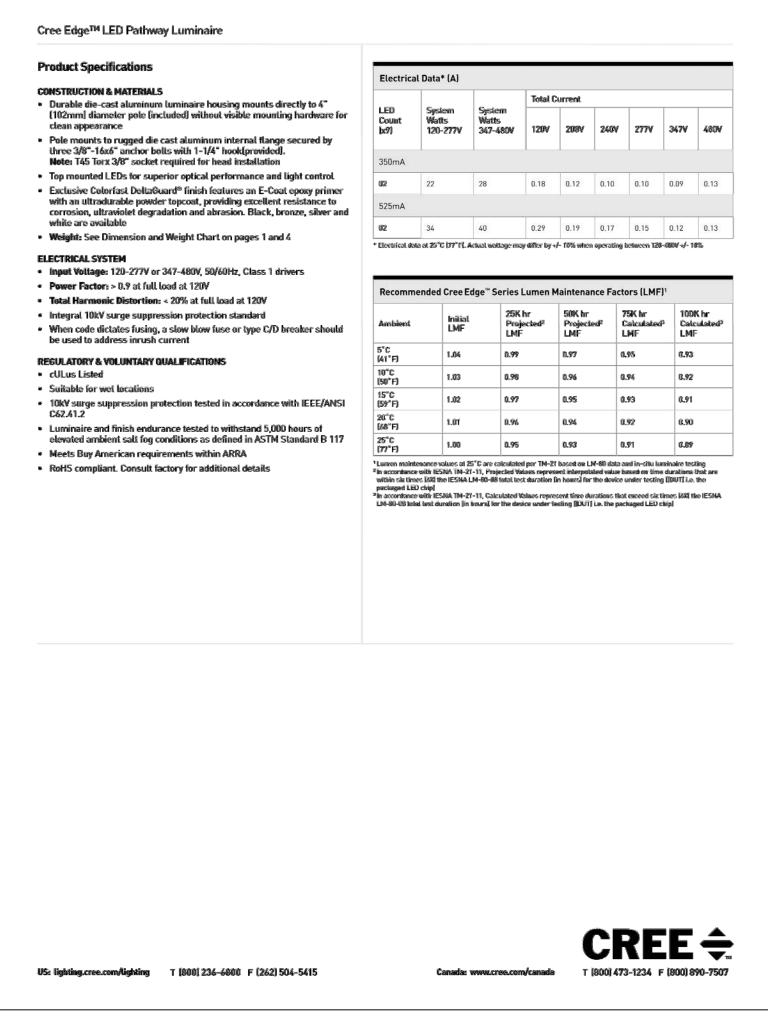

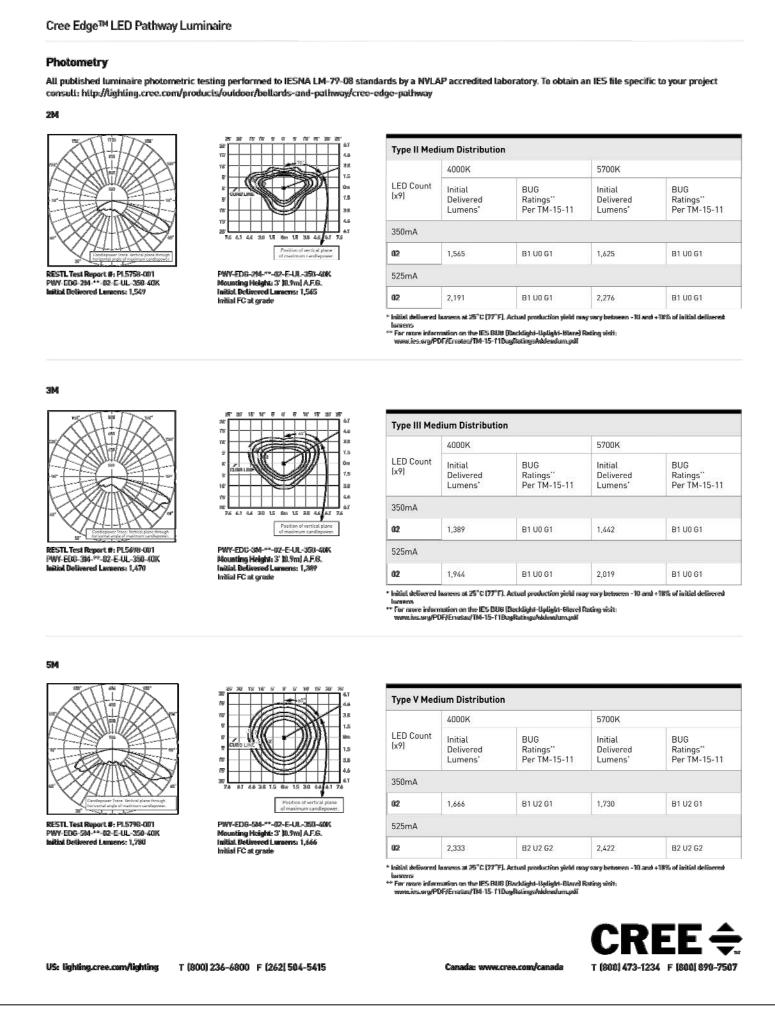

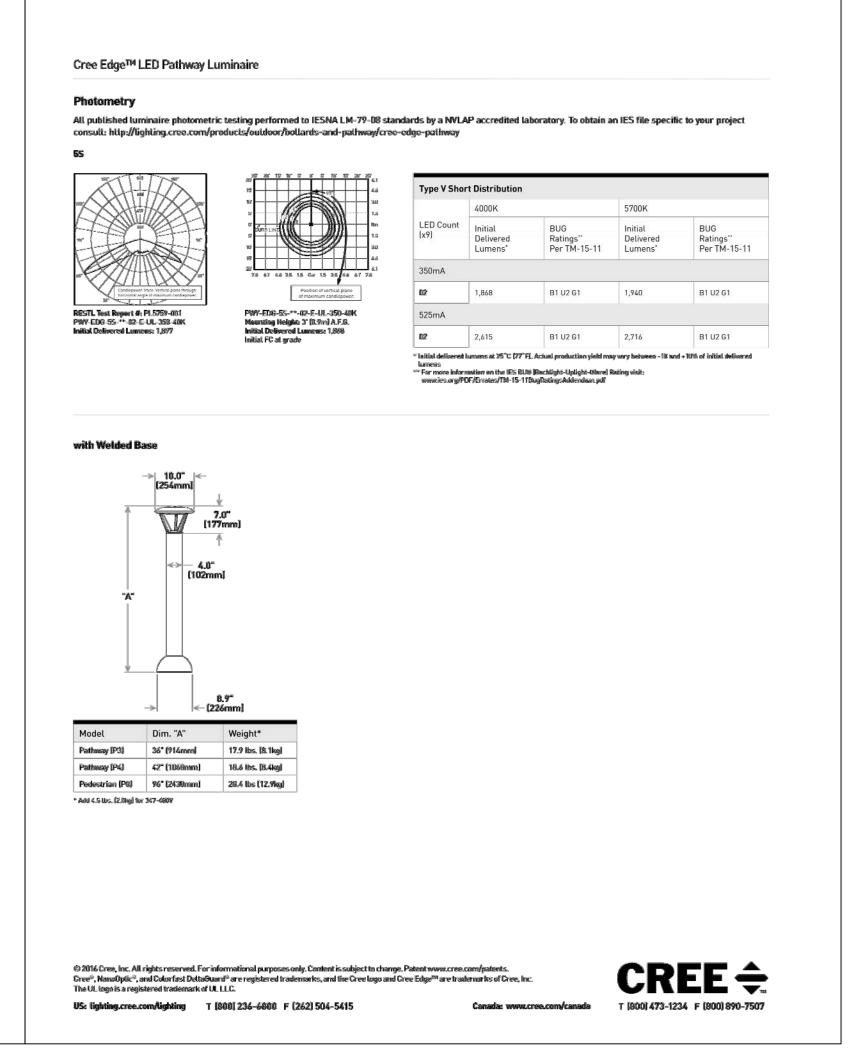

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NEW RESIDENCES & BUILDING B RENOVATIONS
7335 S. Hwy 100, Franklin, WI 53132
DATE OF ISSUE: 10/05/17 REVISIONS:
PROJECT # 17022
SITE PLAN AMENDMENT

1 LIGHTING CUT SHEET - CREE "EDGE" BOLLARD - FIXTURE TYPES "OD" AND "OF"

PARKING LOT AND DRIVE RECONSTRUCTION

Milwaukee, WI 53202 Ph. 414-744-6962 INSPEC © 2015

PRIESTS OF THE SACRED HEART 7373 SOUTH LOVERS LANE ROAD FRANKLIN, WISCONSIN 53132



PARTICIPANTS

OWNER:

PRIESTS OF THE SACRED HEART 7373 SOUTH LOVERS LANE ROAD FRANKLIN, WISCONSIN 53132

CONTRACTOR:

SUBURBAN ASPHALT COMPANY, INC. 11251 WEST FOREST HOME AVE. FRANKLIN, WISCONSIN 53132

(414) 425-5353 (414) 425-6691 - FAX

PROJECT MANAGER
TERRY BUSS, JR.
tbj@suburbanasphalt.com

CIVIL ENGINEER:

INSPEC, INC.
ENGINEERS/ARCHITECTS
126 NORTH JEFFERSON ST
SUITE 120
MILWAUKEE, WI 53202
(414) 744-6962
(414) 744-6981 - FAX

PROJECT ENGINEER
DAN ROEHRDANZ, P.E.
droehrdanz@inspec.com

LAND SURVEYOR:

CONTINENTAL SURVEYING SERVICES, LLC 2059 HWY 175 SUITE A RICHFIELD, WI 53076 (920) 389-9200

REGISTERED LAND SURVEYOR RICK HILLMAN, RLS rickh@csssurveys.com

LIST OF DRAWINGS

- C1 TITLE SHEET, PARTICIPANTS, LIST OF DRAWINGS, SUMMARY OF WORK, AND GENERAL PROJECT NOTES
- C2 TOPOGRAPHIC SURVEY
- C3 REMOVAL AND EROSION CONTROL PLAN
- C4 NEW CONDITIONS SITE PLAN
- C5 NEW CONDITIONS GRADING AND PLUMBING PLAN
- C6 DETAILS
- C7 DETAILS
- C8 EXISTING CONDITIONS WATERSHED INFORMATION FOR PERMIT APPROVALS ONLY
- C9 NEW CONDITIONS WATERSHED INFORMATION FOR PERMIT APPROVALS ONLY

SUMMARY OF WORK

1. BASE BID - ALL WORK SHOWN

GENERAL PROJECT NOTES

- 1. VERIFY MEASUREMENTS AND CONDITIONS ON THE PROJECT.
- 2. REVIEW SPECIFICATIONS FOR INSTRUCTIONS NOT SHOWN ON DRAWINGS.
- 3. EXISTING AND NEW MATERIALS COMMON TO SEVERAL DETAILS MAY BE NOTED ON ONLY ONE.
- 4. CONTRACTOR SHALL BE RESPONSIBLE FOR MAINTAINING SAFE WORKING CONDITIONS ON AREAS FOR EMPLOYEES AND OTHER PERSONS AT THE SITE.

LEGEND:

EXISTING CONSTRUCTION
NEW CONSTRUCTION
NEW DRAINAGE SWALE
EXISTING BUILDING
SILT FENCING
EXISTING CONTOUR LINE
NEW CONTOUR LINE
GRADING LIMIT
PROPERTY LINE
NEW SPOT ELEVATION - TOP OF NEW PAVEMENT OR FINISHED GRADE
EXISTING SPOT ELEVATION
GRADING AND RESTORATION
GRADING AND RESTORATION EXISTING STORM SEWER
EXISTING STORM SEWER
EXISTING STORM SEWER NEW STORM SEWER
EXISTING STORM SEWER NEW STORM SEWER EXISTING ELECTRIC LINE
EXISTING STORM SEWER NEW STORM SEWER EXISTING ELECTRIC LINE EXISTING SANITARY SEWER
EXISTING STORM SEWER NEW STORM SEWER EXISTING ELECTRIC LINE EXISTING SANITARY SEWER EXISTING GAS LINE
EXISTING STORM SEWER NEW STORM SEWER EXISTING ELECTRIC LINE EXISTING SANITARY SEWER EXISTING GAS LINE EXISTING TELEPHONE LINE

	DATE:	No.
PERMIT SET	06-27-15	
PERMIT REVISIONS	07-18-15	

Client:

SUBURBAN ASPHALT COMPANY, INC. for

PRIESTS OF THE SACRED HEART

Project title:

PARKING LOT AND DRIVE RECONSTRUCTION

7373 SOUTH LOVERS LANE ROAD FRANKLIN, WISCONSIN 53132


Sheet content:

TITLE SHEET, GENERAL PROJECT INFORMATION, AND LEGEND

DATE:	07/18/15
CLIENT PROJECT No.:	
INSPEC PROJECT No.:	301471
PROJECT MGR:	DR
DRAWN BY:	DR
CHECKED BY:	

Sheet No

C1 of 9

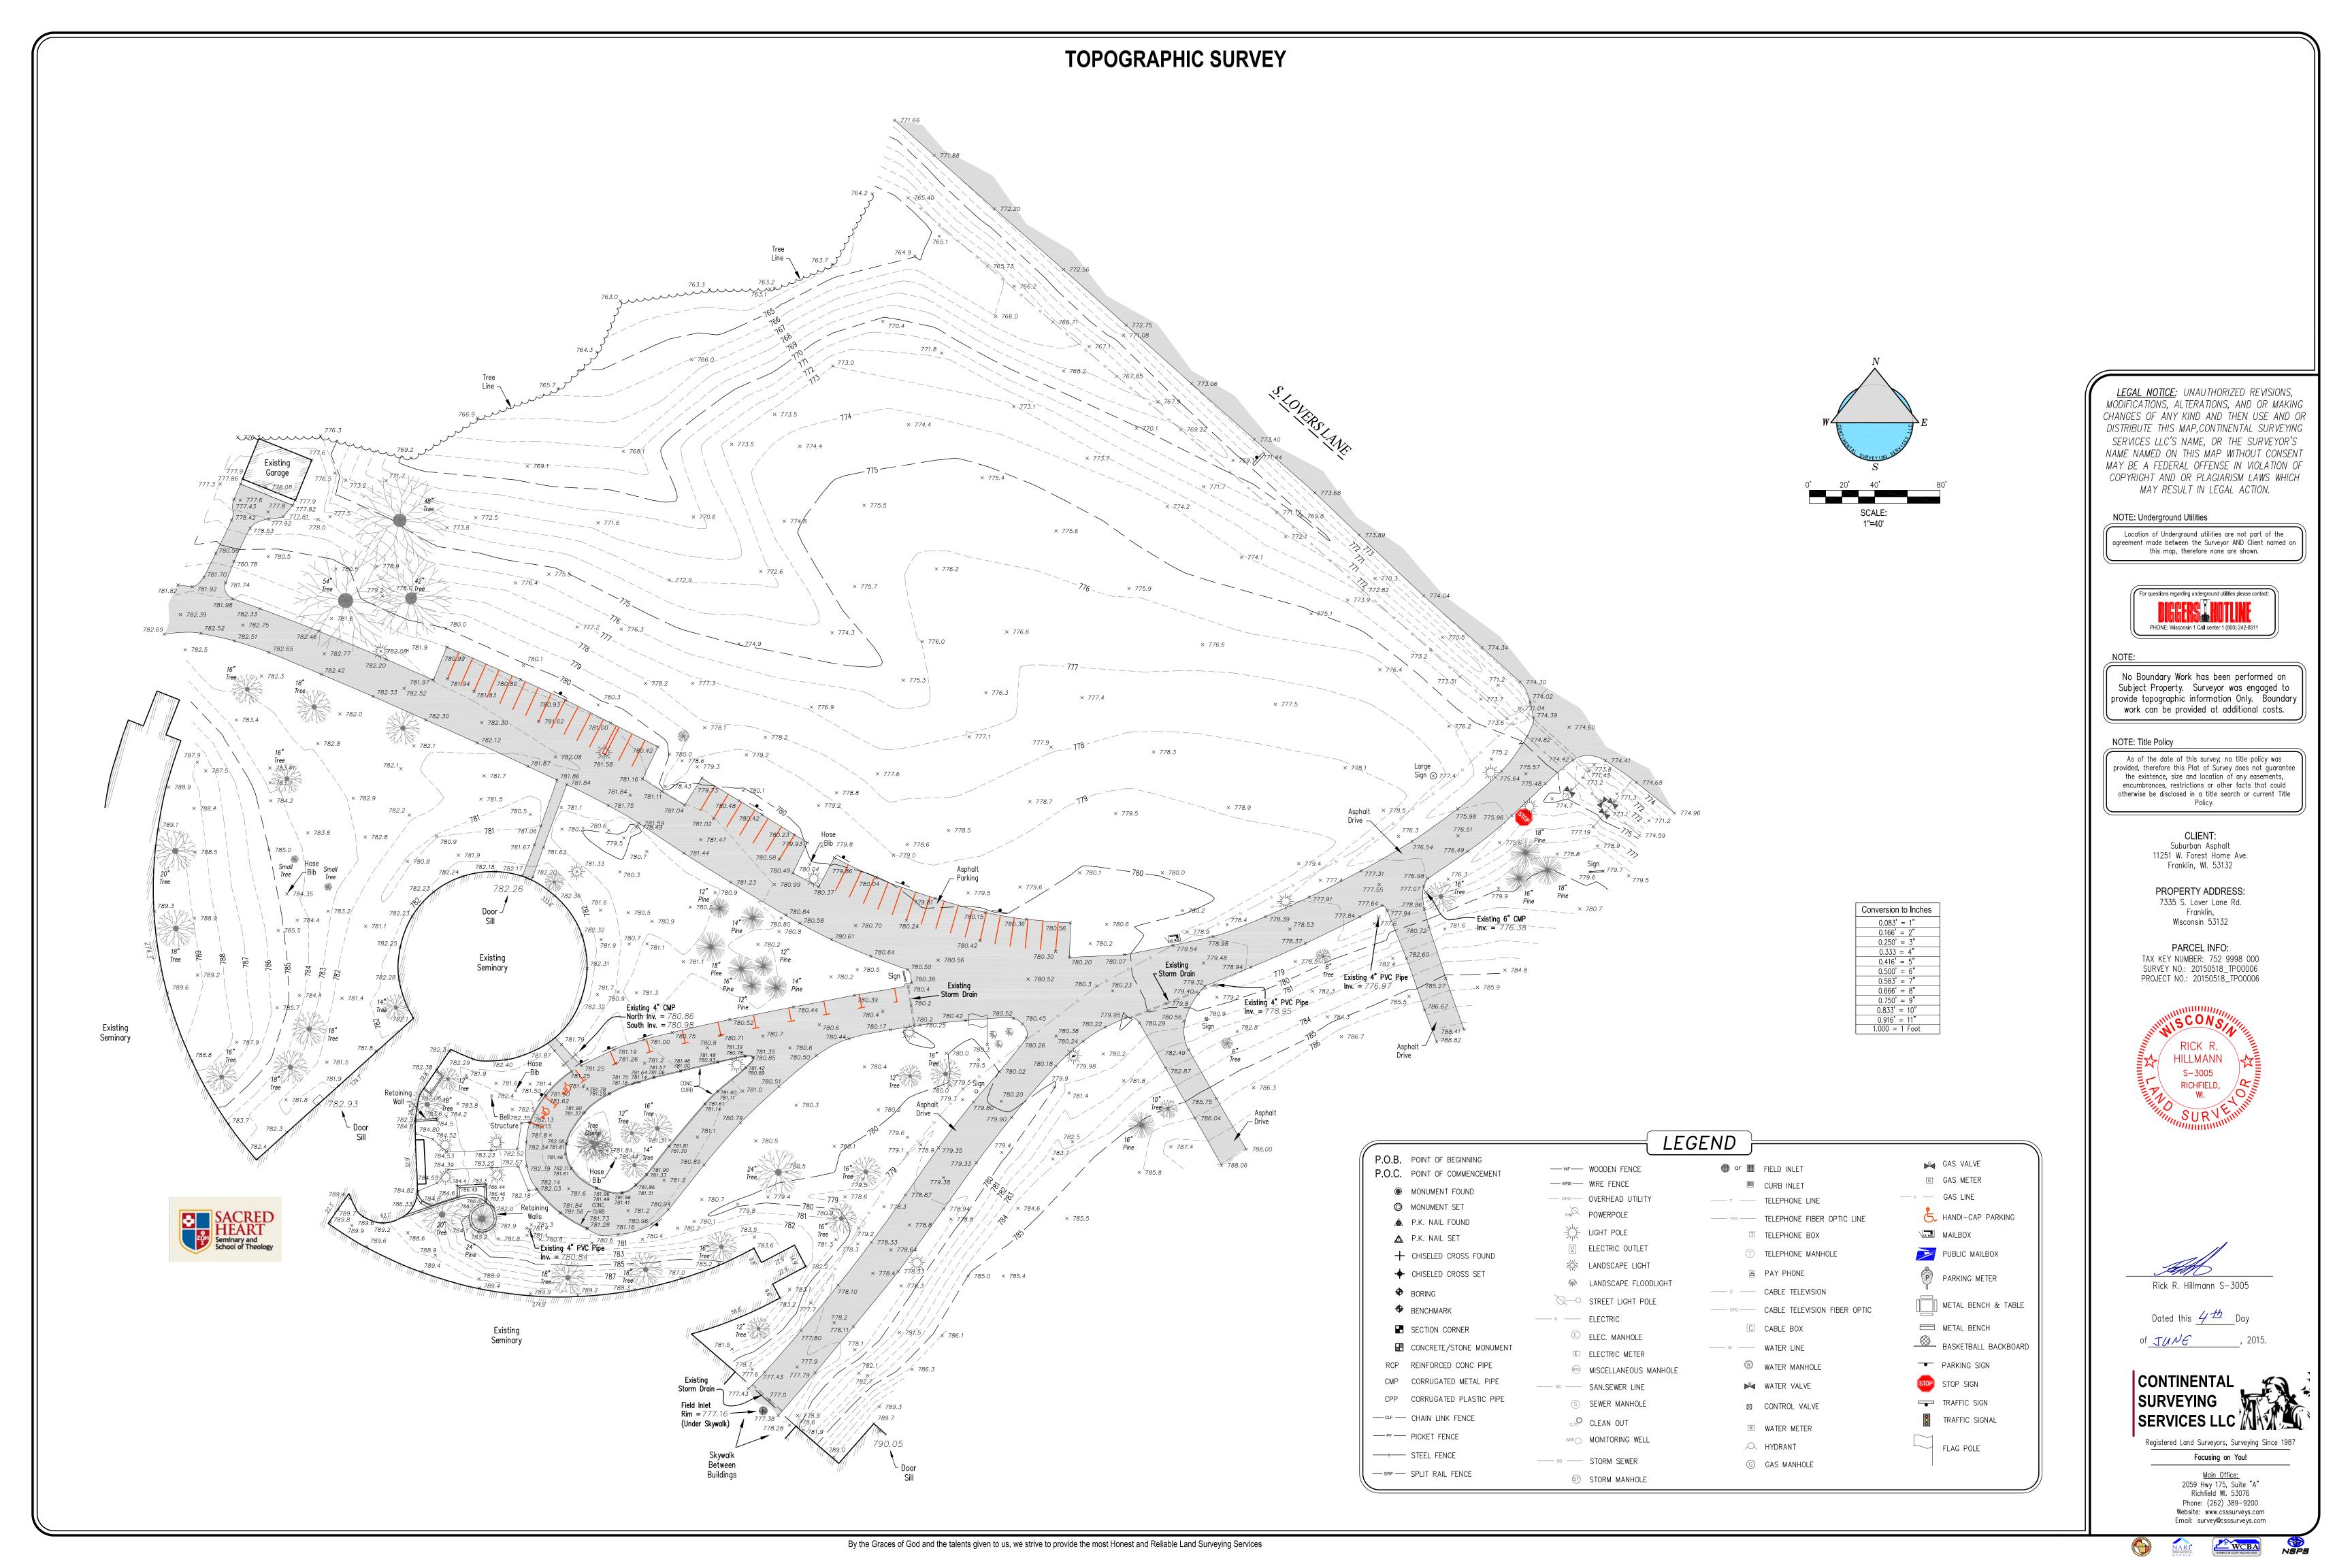



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SUBURBAN ASPHALT

SACRED HEART

PARKING LOT AND

7373 SOUTH LOVERS LANE ROAD FRANKLIN, WISCONSIN 53132

REMOVAL AND EROSION CONTROL PLAN

DATE: 07/18/15 CLIENT PROJECT No.: INSPEC PROJECT No.: PROJECT MGR: DRAWN BY: CHECKED BY:

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4 REMOVE TREE AND STUMP. REMOVE LIGHT POLE BASE AND/OR FLOOD LIGHT BASE AND BACKFILL WITH STONE CHIPS. OWNER WILL REMOVE LIGHT POLES AND UNDERGROUND WIRES. REMOVE FLAG POLE FOOTING AND BACKFILL WITH STONE CHIPS. OWNER WILL RELOCATE FLAG POLE. INSTALL STONE TRACKING PAD, 24' WIDE BY 50' LONG, PRIOR TO CONSTRUCTION. SEE DETAIL 3/C7.

NOTES:

WITHIN PROJECT AREA.

1. REMOVE OBSOLETE HOSE BIBS AND PIPES

PROJECT AREA AND SALVAGE FOR

LOCATIONS WITH OWNER PRIOR TO REINSTALLATION ON NEW POSTS.

2. REMOVE PARKING AND TRAFFIC SIGNS WITHIN

REINSTALLATION ON NEW POSTS. DISCUSS NEW



Storm Drain —

(Under Skywalk)

Field Inlet

REMOVAL AND EROSION CONTROL PLAN

COMPANY, INC.

PRIESTS OF THE

DRIVE RECONSTRUCTION

1"=30'-0"



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PRIESTS OF THE SACRED HEART


PARKING LOT AND DRIVE RECONSTRUCTION

7373 SOUTH LOVERS LANE ROAD FRANKLIN, WISCONSIN 53132

NEW CONDITIONS - SITE PLAN

DATE: 07/18/15 CLIENT PROJECT No.: INSPEC PROJECT No.: PROJECT MGR: DRAWN BY: CHECKED BY:

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NEW CONDITIONS - GRADING PLAN

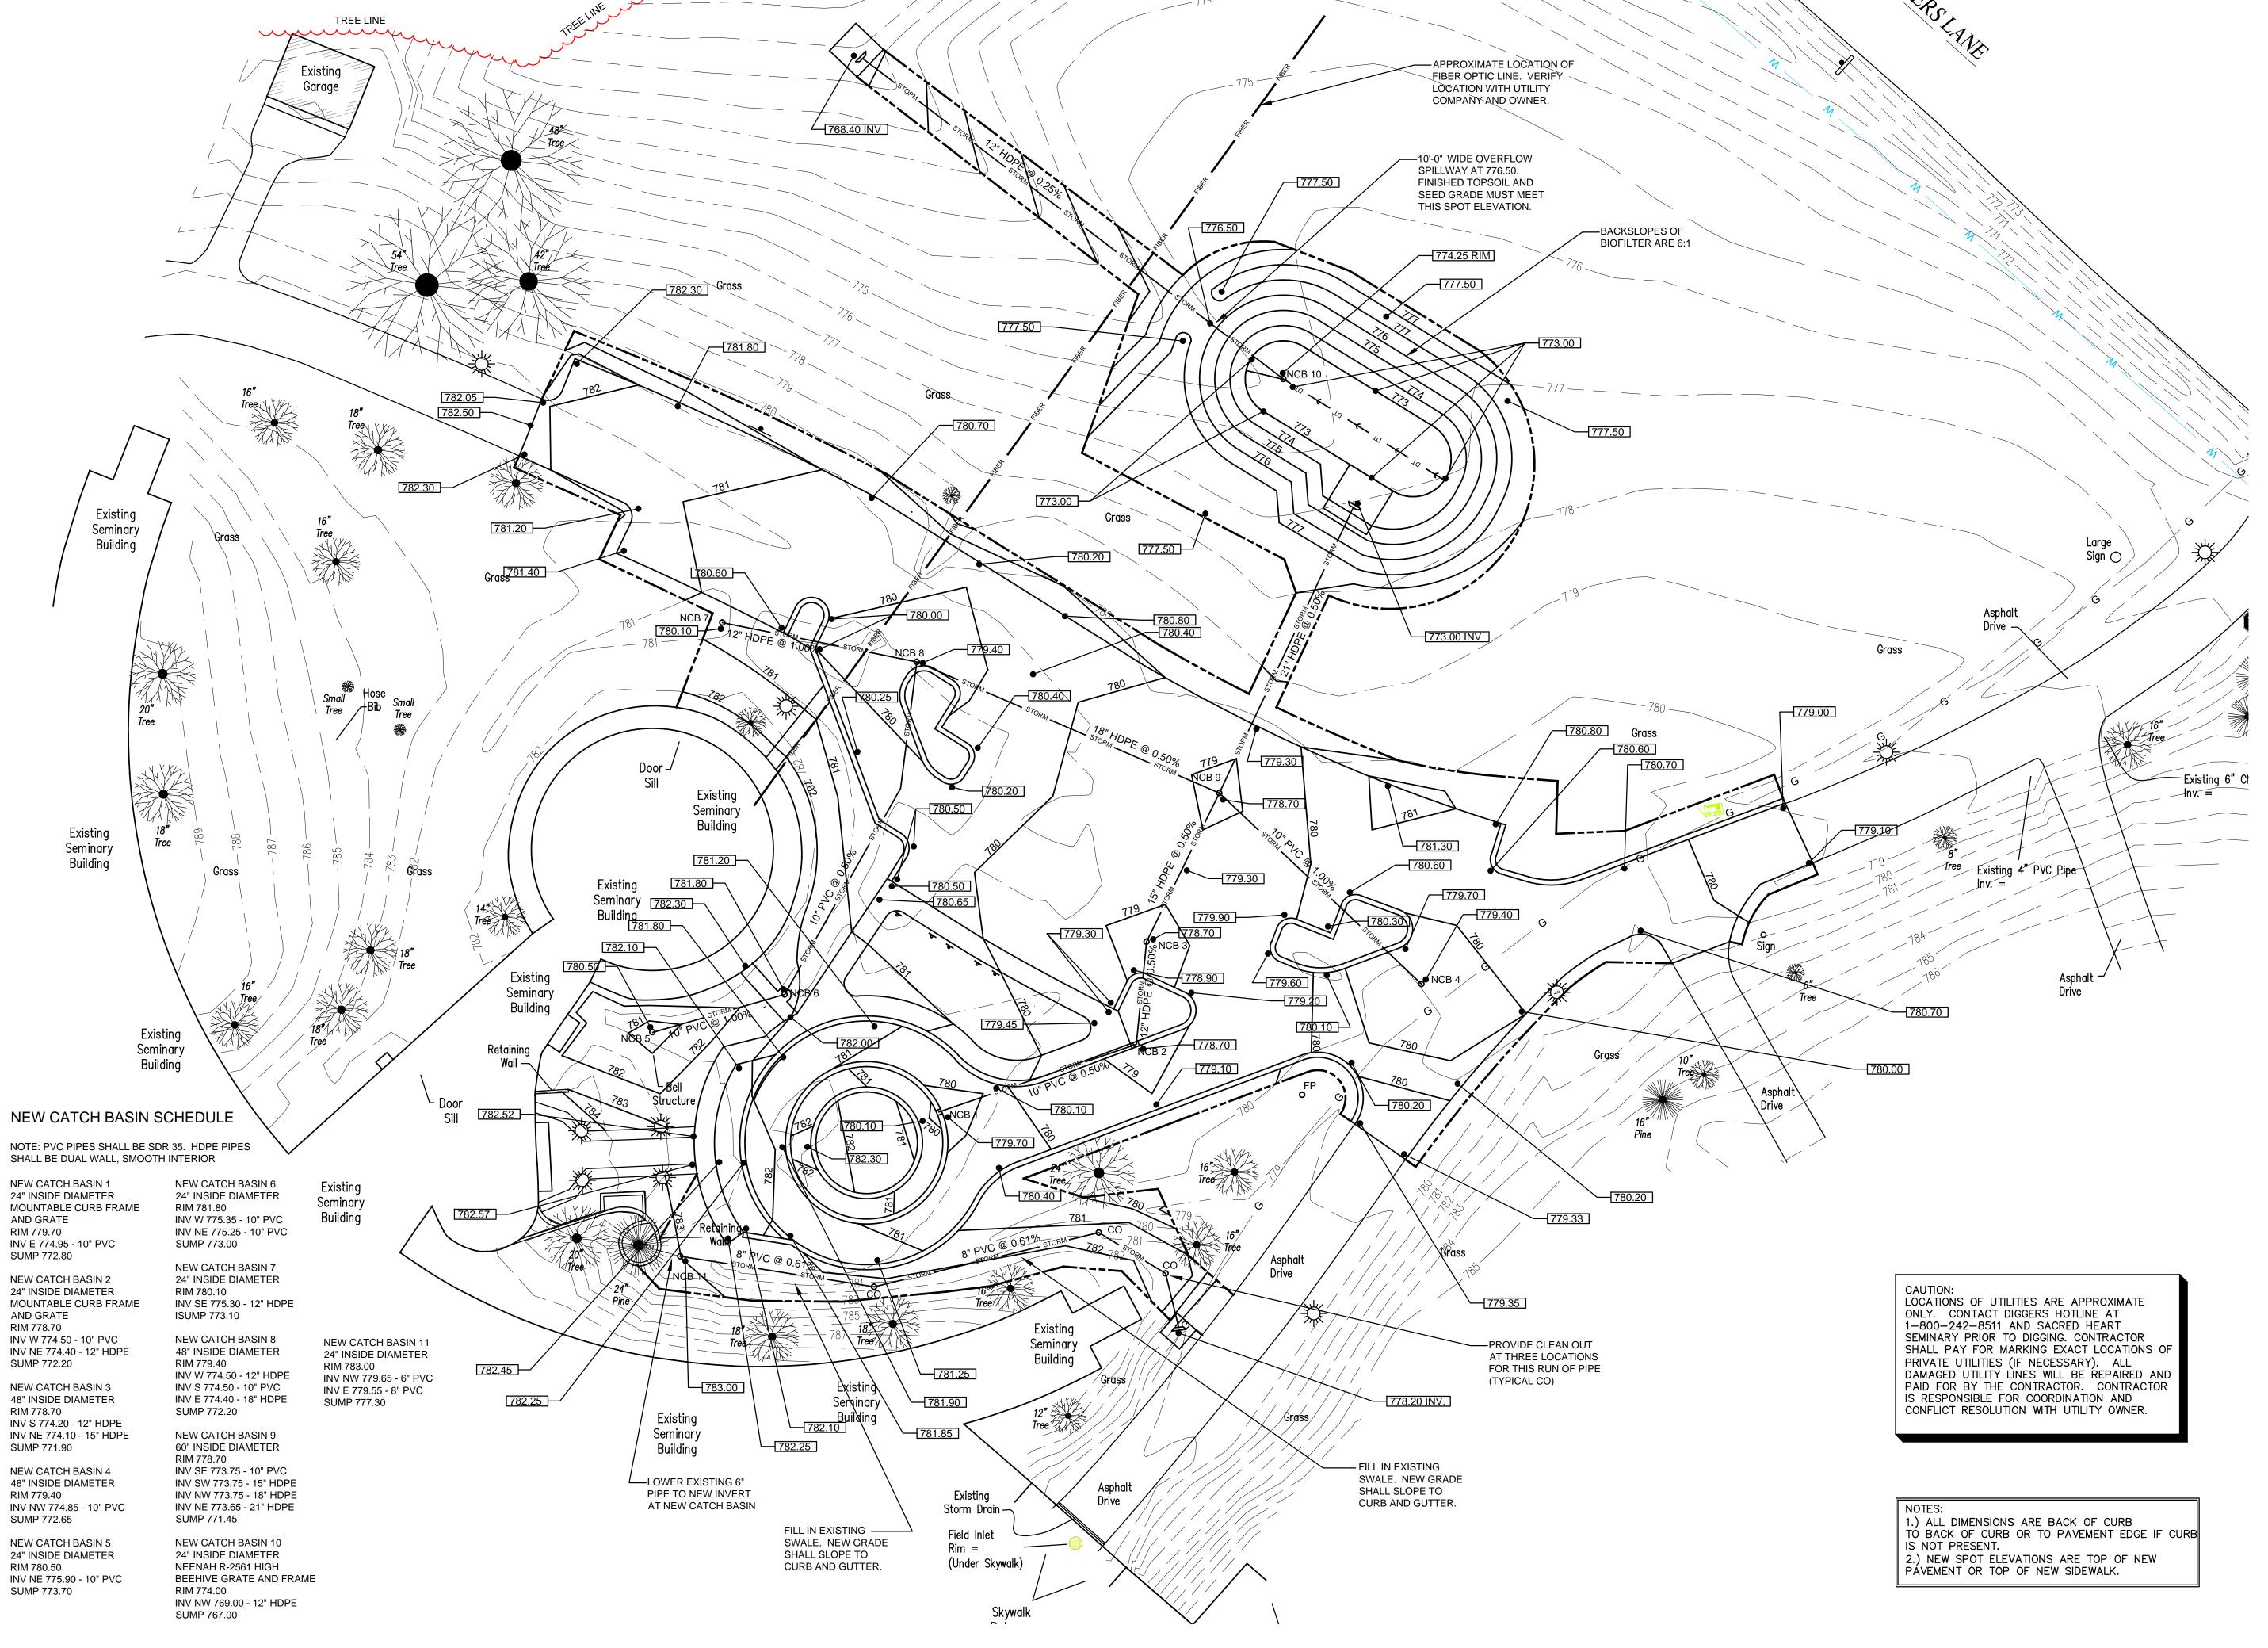1"=30'-0"



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PRIESTS OF THE SACRED HEART

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7373 SOUTH LOVERS LANE ROAD FRANKLIN, WISCONSIN 53132

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NEW CONDITIONS - GRADING

AND PLUMBING PLAN

DATE: 07/18/15
CLIENT PROJECT No.: 301471
PROJECT MGR: DR
DRAWN BY: DR


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NOTES: 1. CONTROL JOINT SPACING SHALL BE A MAXIMUM OF 8'-0" ON CENTER EACH WAY. MATCH EXISTING JOINT LAYOUT WHENEVER POSSIBLE.

2. AT STOOPS PROVIDE EPOXY COATED, SMOOTH, GREASED, DOWELS IN LIEU OF TIE



CONCRETE CONSTRUCTION DETAIL **CONCRETE CONSTRUCTION DETAIL** (3) BEHIND CURB AND GUTTER AND ASPHALT

1. CONTROL JOINT SPACING SHALL BE A MAXIMUM OF 8'-0" ON CENTER EACH WAY.

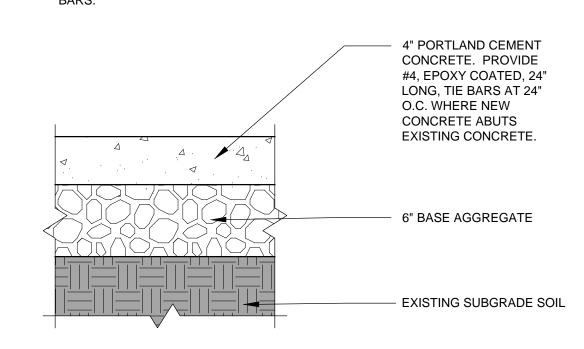2. AT STOOPS PROVIDE EPOXY COATED, SMOOTH, GREASED, DOWELS IN LIEU OF

4" PORTLAND CEMENT

CONCRETE. PROVIDE

#4, EPOXY COATED, 24"

LONG, TIE BARS AT 24"

O.C. WHERE NEW

CONCRETE ABUTS

PAVEMENT)

EXISTING CONCRETE.

BASE AGGREGATE (16" THICK

MATCH EXISTING SUBGRADE OF

ADJACENT ASPHALT PAVEMENT DETAIL

BEHIND CURB AND GUTTER.

10" THICK ALONG ASPHALT

EXISTING SUBGRADE SOIL

NOTES:


MATCH EXISTING JOINT LAYOUT WHENEVER POSSIBLE.

NOTES:

TIE BARS.

NOTES:

1. CONTROL JOINT SPACING SHALL BE A MAXIMUM OF 10'-0" ON CENTER EACH WAY.

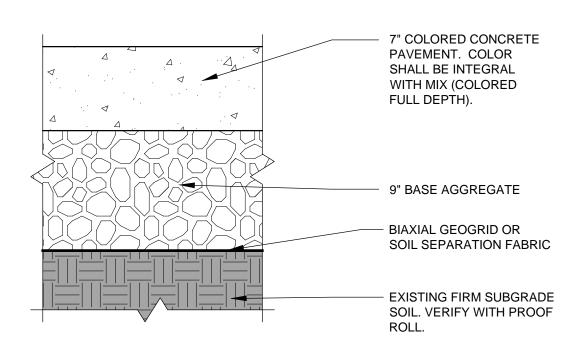


COLORED CONCRETE APRON


DETAIL FOR ROUNDABOUT

PAVEMENT RECONSTRUCTION DETAIL


1. PRIOR TO PLACING CURB AND GUTTER, DISCUSS WITH ENGINEER LOCATIONS FOR REJECT CURB AND GUTTER 2. INSTALL TWO, #4, 24" LONG, EPOXY COATED TIE BARS WHERE NEW CURB AND GUTTER MEETS EXISTING.

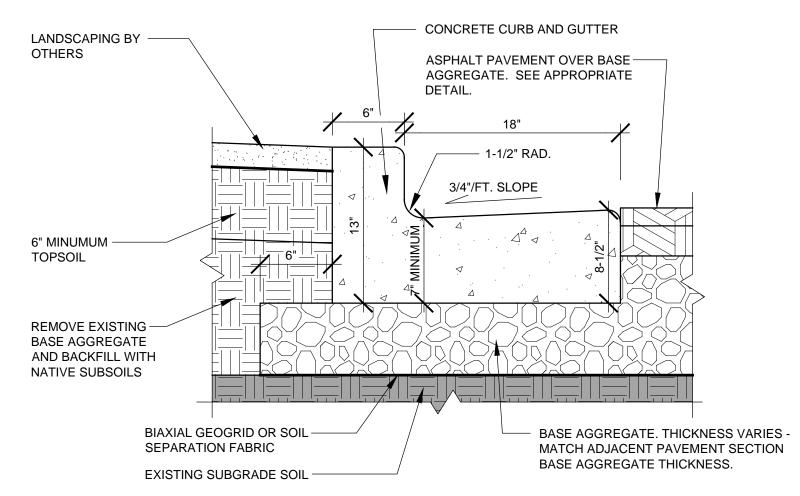

B6-18 CONCRETE CURB AND **GUTTER CONSTRUCTION DETAIL** 1. PRIOR TO PLACING CURB AND GUTTER, DISCUSS WITH ENGINEER LOCATIONS FOR REJECT CURB AND GUTTER 2. INSTALL TWO, #4, 24" LONG, EPOXY COATED TIE BARS WHERE NEW CURB AND GUTTER MEETS EXISTING.

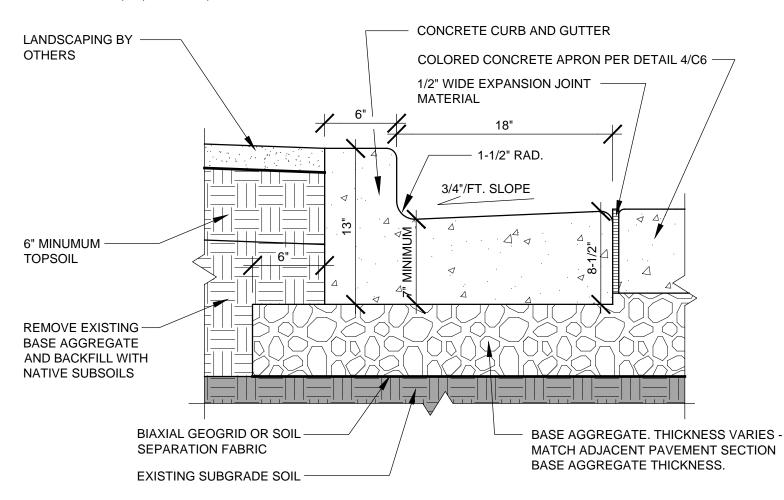

B6-18 CONCRETE CURB AND GUTTER AT 6 INTERIOR ISLAND OF ROUNDABOUT

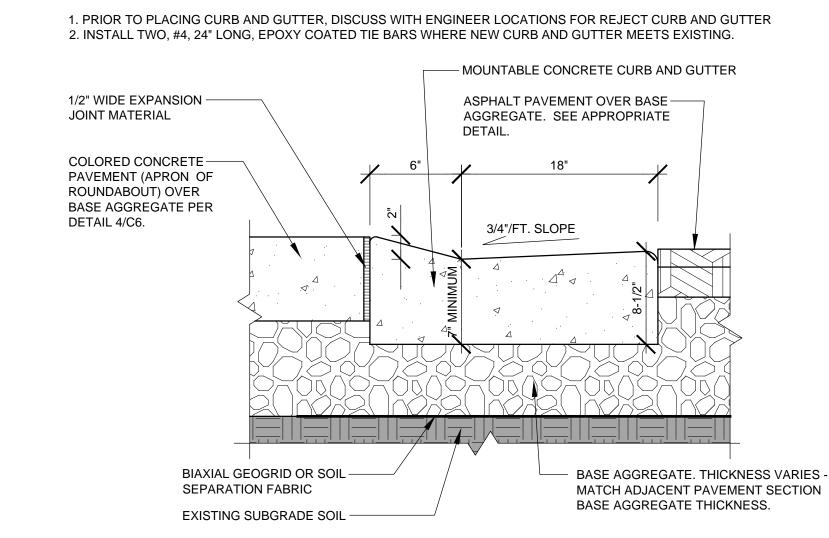


MOUNTABLE CURB AT 7 ROUNDABOUT DETAIL

NOTES: 1. PRIOR TO PLACING CURB AND GUTTER, DISCUSS WITH ENGINEER LOCATIONS FOR REJECT CURB AND GUTTER 2. INSTALL TWO, #4, 24" LONG, EPOXY COATED TIE BARS WHERE NEW CURB AND GUTTER MEETS EXISTING. - MOUNTABLE CONCRETE CURB AND GUTTER 1/2" WIDE EXPANSION -ASPHALT PAVEMENT OVER BASE — JOINT MATERIAL AGGREGATE. SEE APPROPRIATE CONCRETE SIDEWALK — OVER BASE AGGREGATE PER DETAIL 3/C6. 3/4"/FT. SLOPE BIAXIAL GEOGRID OR SOIL BASE AGGREGATE. THICKNESS VARIES -SEPARATION FABRIC MATCH ADJACENT PAVEMENT SECTION BASE AGGREGATE THICKNESS.


EXISTING SUBGRADE SOIL

8 MOUNTABLE CURB AT SIDEWALK DETAIL
C6 NO SCALE

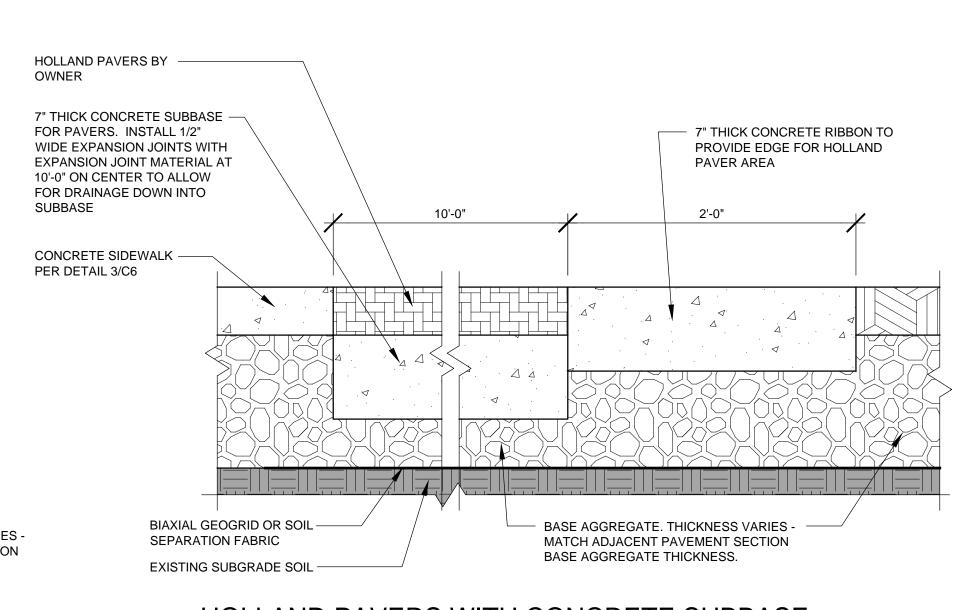


HOLLAND PAVERS WITH CONCRETE SUBBASE

AND CONCRETE RIBBON AT ASPHALT PAVEMENT DETAIL

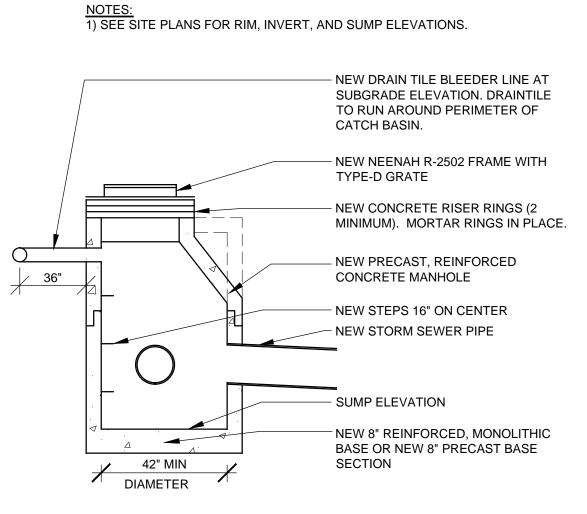

CATCH BASIN DETAIL
NO SCALE

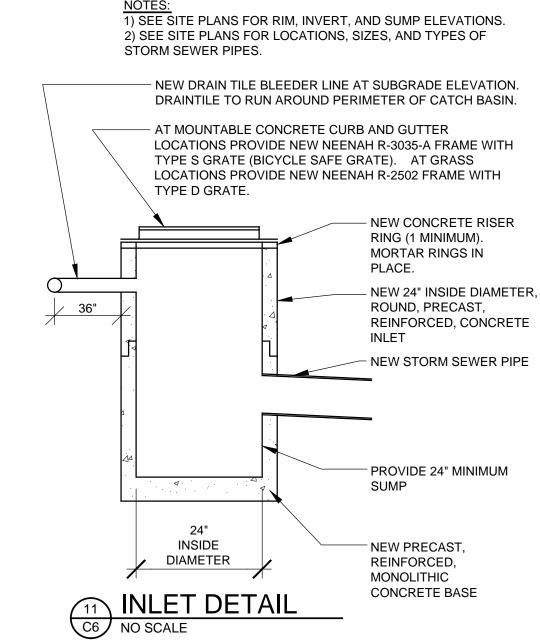

PRIESTS OF THE SACRED HEART

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PARKING LOT AND DRIVE RECONSTRUCTION

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COMPANY, INC.

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DETAILS

DATE: 07/18/15 **CLIENT PROJECT No.:** INSPEC PROJECT No.: PROJECT MGR: DRAWN BY: CHECKED BY:

C6 of 9

1 STORM SEWER FLARED END SECTION DETAIL
C7 NO SCALE


NOTES:

1. INSTALL TRACKING PAD PRIOR TO ANY CONSTRUCTION TRAFFIC LEAVING THE SITE.


2. SURFACE WATER MUST BE PREVENTED FROM PASSING THROUGH THE TRACKING PAD. FLOWS SHALL BE DIVERTED AWAY FROM OR CONVEYED UNDER TRACKING PAD VIA SWALES, CULVERTS,

3. ROCKS LODGED BETWEEN THE TIRES OF DUAL WHEEL VEHICLES SHALL BE REMOVED PRIOR TO LEAVING THE SITE.


4. THIS DETAIL IS BASED ON WISCONSIN DNR TECHNICAL STANDARD 1057 - STONE TRACKING PAD.

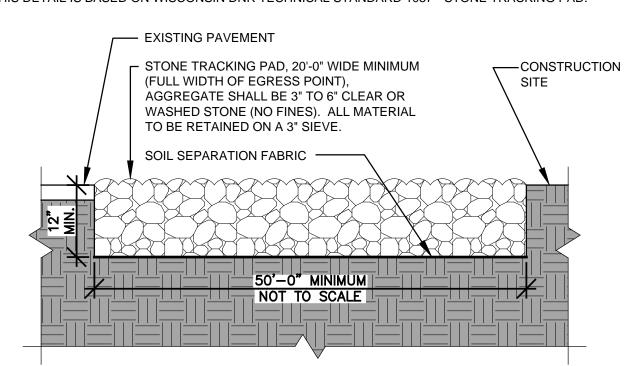

TRACKING PAD DETAIL
NO SCALE

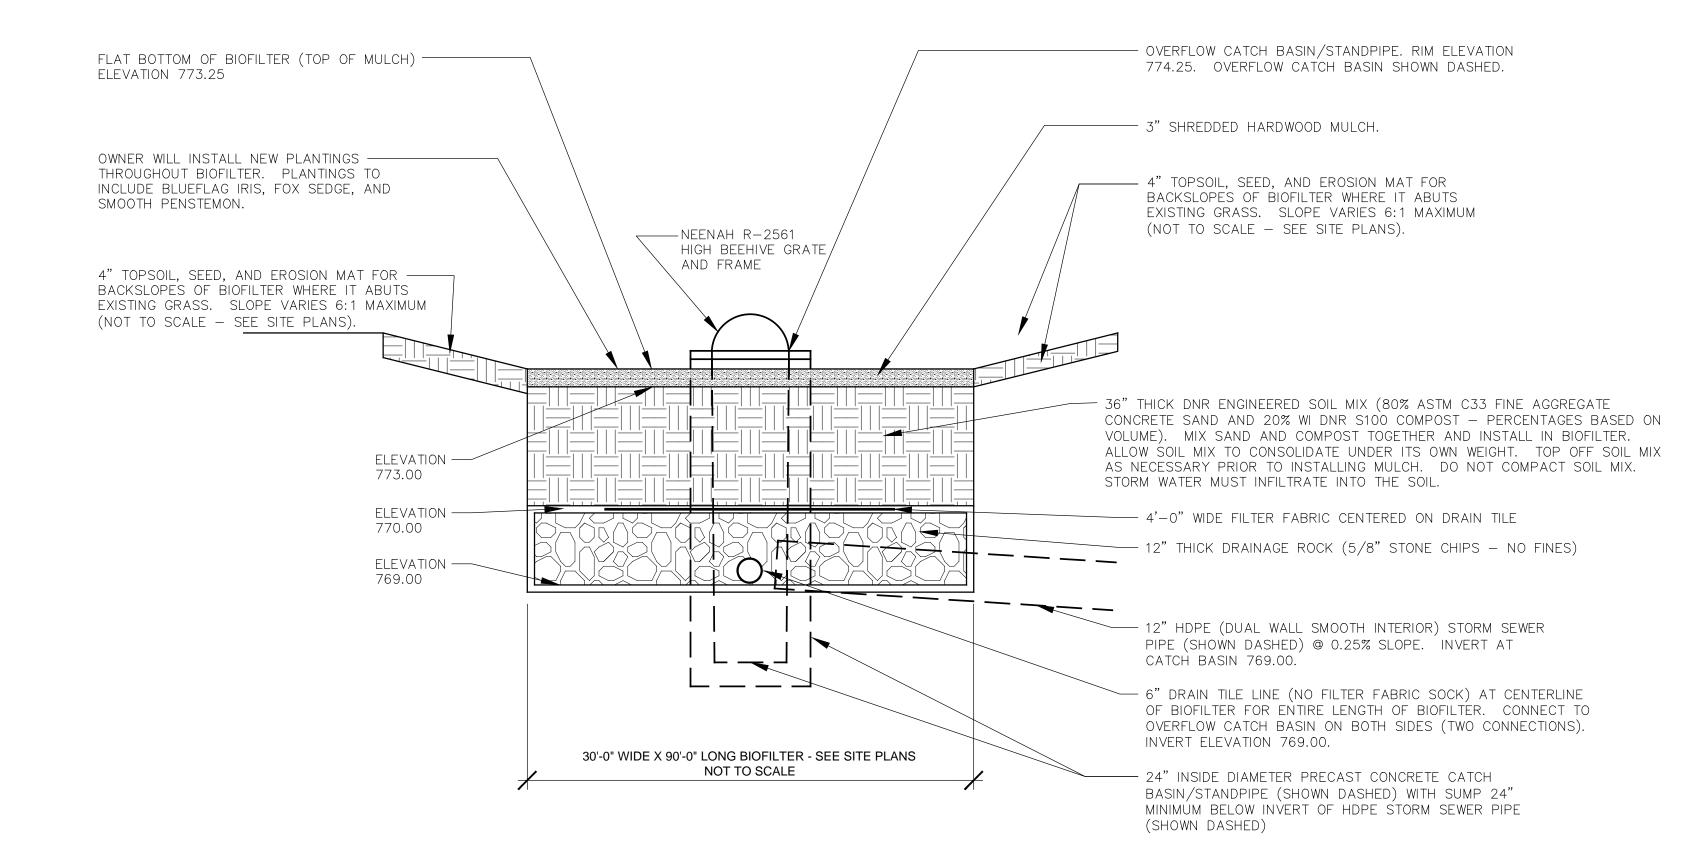



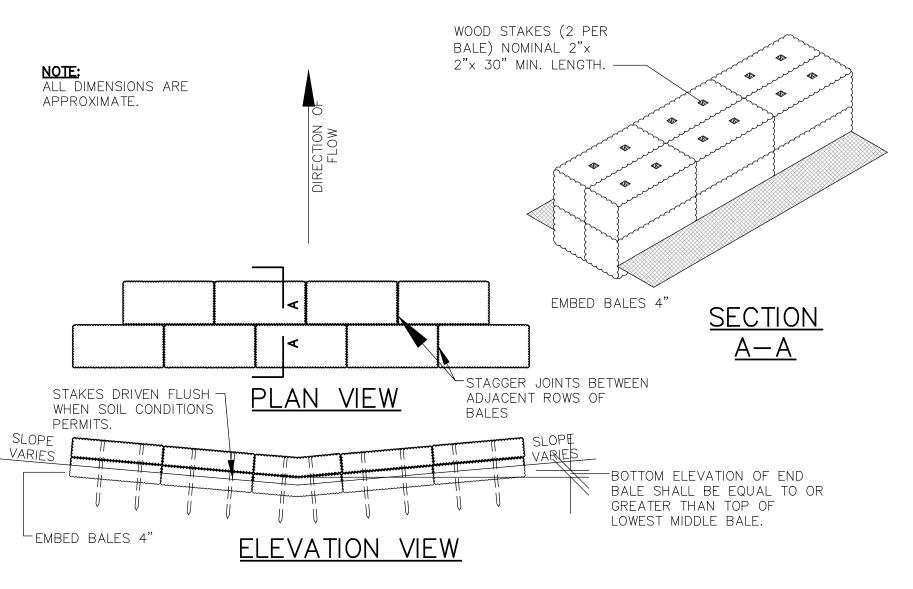


EROSION CONTROL HAY BALE

DITCH CHECK

TO NO SCALE

NOTES:

1. THIS DETAIL BASED ON WISCONSIN DNR TECHNICAL STANDARD 1056 - SILT FENCE. INSTALL SILT FENCE PER WISCONSIN DNR TECHNICAL STANDARD 1056.

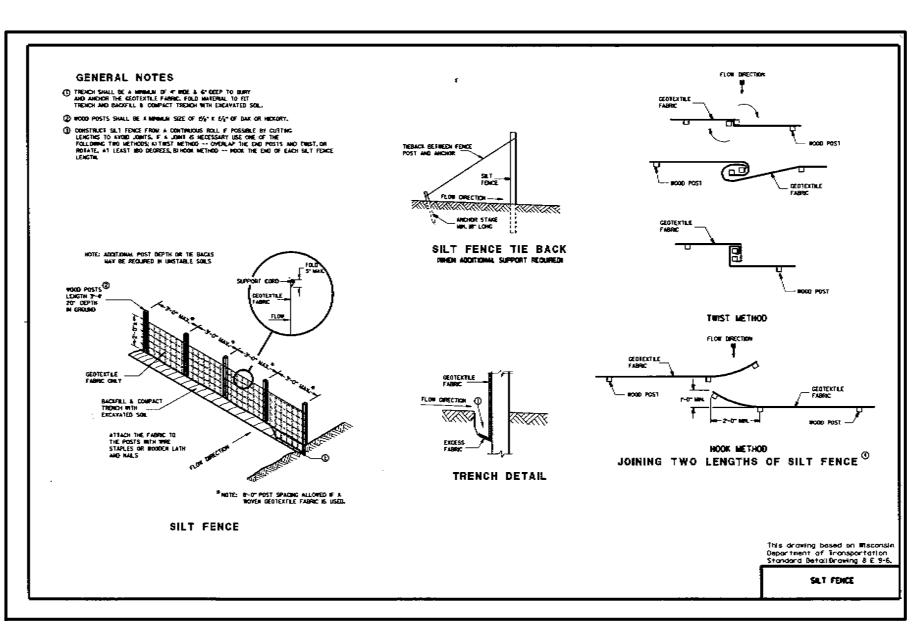

5 SILT FENCE DETAIL
C7 NO SCALE



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ISSUE LEVEL / REVISION: DATE: No.:
PERMIT SET 06-27-15
PERMIT REVISIONS 07-18-15

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SUBURBAN ASPHALT COMPANY, INC. for

PRIESTS OF THE SACRED HEART

Project title

PARKING LOT AND DRIVE RECONSTRUCTION

7373 SOUTH LOVERS LANE ROAD FRANKLIN, WISCONSIN 53132

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DETAILS

DATE: 07/18/15
CLIENT PROJECT No.:
INSPEC PROJECT No.: 301471
PROJECT MGR: DR
DRAWN BY: DR

CHECKED BY:

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SUBURBAN ASPHALT COMPANY, INC.

PRIESTS OF THE SACRED HEART

PARKING LOT AND DRIVE RECONSTRUCTION

7373 SOUTH LOVERS LANE ROAD FRANKLIN, WISCONSIN 53132

EXISTING CONDITIONS WATERSHED

INFORMATION FOR PERMIT

APPROVALS ONLY

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1"=30'-0"





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SUBURBAN ASPHALT COMPANY, INC.

PRIESTS OF THE SACRED HEART

PARKING LOT AND DRIVE RECONSTRUCTION

7373 SOUTH LOVERS LANE ROAD FRANKLIN, WISCONSIN 53132

NEW CONDITIONS WATERSHED

INFORMATION FOR PERMIT

APPROVALS ONLY

DATE: 07/18/15 CLIENT PROJECT No.: INSPEC PROJECT No.: PROJECT MGR: DRAWN BY:

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NORTH

NEW CONDITIONS - WATERSHED INFORMATION 1"=30'-0"