primary use of the site as agriculture with sheets flow, along with budget constraints curb and gutter has not been added.

8. Staff recommends adding additional parking to the site and/or considering a parking bank on site should a future need for parking arise.

RESPONSE: Staff recommendations will be taken into consideration.

#### **Lighting Plan**

- 1. Staff recommends submittal of a Lighting Plan to include any existing lighting and any necessary new lighting, evaluated for both general security and safety purposes and for the existing and proposed parking lots, sidewalks, and entrances of frequently used buildings.
- 2. Staff recommends that any light poles utilize shielded luminaries, that such light poles be so shielded and/or located such that no excessive light source is directly visible beyond the property boundary.

RESPONSE: Existing site lighting to remain. Proposed site lighting consists of low level pedestrian bollards along sidewalk from parking area to Visitor Center.

Snow Storage Plan

1. Provide a Snow Storage Plan in accordance with Section 15-5.0210 of the UDO.

RESPONSE: A snow storage plan has been added to the proposal narrative.

#### Sign Plan

If any signage is shown on the revised plan submittal, including monument signs shown on the site and landscape plans and wall signs illustrated on the building elevations, then staff recommends adding a note which reads, "Signs are shown for reference only and require separate review and approval by the Architectural Review Board and issuance of a Sign Permit by the Building Inspection Department".

 At this time, any proposed signage would be subject to review and approval by City of Franklin Architectural Review Board and issuance of a Sign Permit by the City of Franklin Building Inspection Department. Staff recommends discussing sign requirements and the amount of signage allowed with the Building Inspector, Fred Baumgart. The Building Inspection Department can be reached at (414) 425-0084.

RESPONSE: For any future signage needs, the required approvals will be sought

#### **Dumpster Plan**

1. Please illustrate on the site plan and provide details for storage of trash dumpsters and garbage receptacles. Trash facilities must provide sight-proof fencing (wood or masonry) and landscaping to totally obstruct vision into the garbage storage area. Section 15-3.0803(I) of the UDO defines the detailed standards for trash dumpsters and garbage receptacles. If no dumpsters are required, please indicate and explain in a revised letter of intent or supplemental letter how garbage will be taken care of on your site.

#### RESPONSE: Details for dumpster storage has been added to the site plan.

#### Planned Development District Ordinance

1. Staff will provide the draft PDD Ordinance for you as soon as possible.

#### **Project Narrative**

1. If it is intended that existing structures are to remain, and be maintained without any further City approvals, please clearly state that in the project narrative. Please be aware that any changes in use, building additions, or new buildings, would however require separate approvals from the City unless specifically identified within the proposed PDD.

RESPONSE: Recommended language has been added to the proposal narrative.

#### **Engineering Staff Comments**

1. Engineering staff comments are forthcoming. Staff recommends contacting Ron Romeis directly at 414-425-7510 if you have any stormwater management, erosion control, etc. related questions.

#### **Fire Department Comments**

1. The Fire Department did not have any comments. However, at the May 7<sup>th</sup> Development Review Team meeting regarding the Visitor Center, Fire Department staff had indicated that the Visitor Center would need a sprinkler system as part of its fire suppression system, that the existing fire hydrant may need to be relocated, and that the main access drive through the farm building complex should be paved (or the current gravel drives confirmed that they can support the weight of emergency vehicles). Staff recommends contacting the Fire Department's Assistant Chief Ron Mayer at (414) 425-1420.

#### Police Department Staff Comments

1. The Police Department did not have any comments. However, at the May 7<sup>th</sup> Development Review Team meeting, Police Department staff indicated it would be important to obtain the support of, and to keep informed, the House of Correction about the proposed project.

#### **Milwaukee County Parks CMP Amendment Application**

#### **Legal Description of Property**

#### Location:

COMM. 1860 FT W OF SE COR OF SE 22 5 21 THEN 1320 FEET NELY 1410.46 FT W TO NW COR SD QUAR S TO SW COR SD QUAR THE E TO BEG CONT 55.758 ACS

#### TAX ID:

883999002



# HUNGER TASK FORCE GRANARY ALTERATION & ADDITION

9000 SOUTH 68TH STREET FRANKLIN, WISCONSIN

# JUNE 17, 2015 95% REVIEW DOCUMENTS

SHEET INDEX

CODE SUMMARY PLAN GENERAL NOTES

LIFE SAFETY AND GENERAL INFORMATION

G000 COVERSHEET

CIVIL

C-0 SURVEY (PREPARED BY SIGMA)
C100 PRELIMINARY SITE PLAN

ARCHITECTURAL

A010 ARCHITECTURAL SITE PLAN
A100 DEMOLITION PLAN AND EXTERIOR ELEVATIONS
A200 FLOOR PLAN
A201 REFLECTED CEILING PLAN AND ROOF PLAN
A400 EXTERIOR ELEVATIONS
A500 BUILDING SECTIONS
A501 WALL SECTIONS

A501 WALL SECTIONS
A600 EXTERIOR DETAILS
A601 EXTERIOR DETAILS
INTERIOR ELEVATIONS
A801 INTERIOR ELEVATIONS
A810 SCHEDULES

STRUCTURAL

S100 FOUNDATION AND FLOOR FRAMING PLAN S200 ROOF FRAMING PLAN

<u>PLUMBING</u>

P1.0 SYMBOLS, ABBREVIATIONS, SCHEDULES & DETAILS P1.1 SUPPLY PIPING, WASTE AND VENT PLANS

MECHANICAL

M1.0 SYMBOLS, ABBREVIATIONS, SCHEDULES & DETAILS M1.1 MECHANICAL FLOOR PLAN

ELECTRICAL

00 FIRST FLOOR ELECTRICAL PLAN

# ARCHITECT OF RECORD

ARCINT-ARCHITECTURE

3618 WEST PIERCE STREET MILWAUKEE, WI 53215 tel (414) 688-4386

# STRUCTURAL ENGINEERING

BLODGETT ENGINEERING W169 N10815 REDWOOD LANE -GERMANTOWN, WI tel (262) 293-9923

# CIVIL ENGINEERING

SIGMA GROUP

1300 WEST CANAL STREET MILWAUKEE, WI 53233 tel (414) 643-4200

## MECHANICAL ENGINEERING

THE MATRIX GROUP

311 EAST CHICAGO STREET SUITE 310 MILWAUKEE, WI 53202 tel (414) 329-2827

# ELECTRICAL ENGINEERING

CZARNECKI ENGINEERING

1121 MARVIN COURT SUITE B WAUKESHA, WI 53186 tel (262) 513-2020 PROJECT NAME
HUNGER TASK FORCE
GRANARY ALTERATION
& ADDITION

arcint

architecture

arcint architecture IIc 3618 west pierce street


arcint-architecture.com

PROJECT TEAM

9000 S. 68TH STREET FRANKLIN, WISCONSIN

#### SITE LOCATION MAP



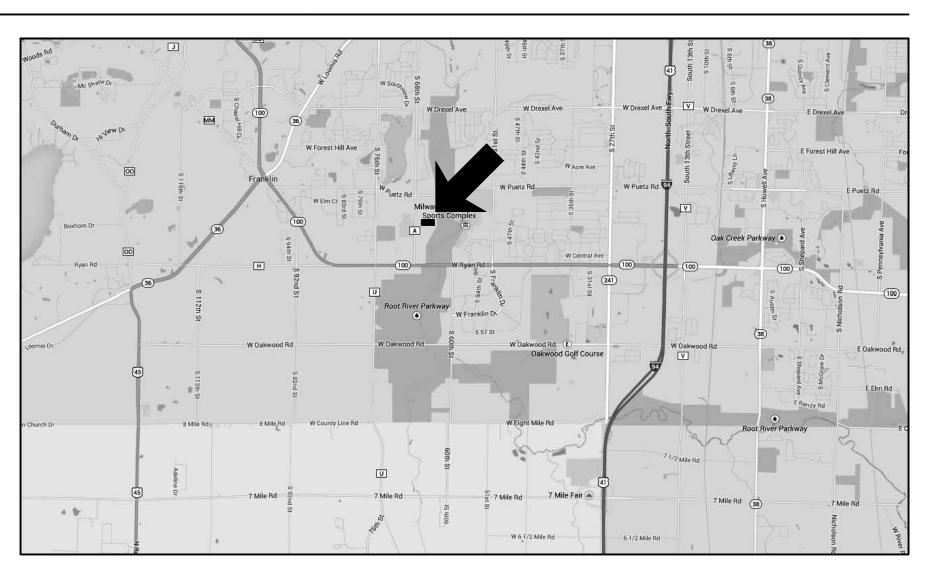

DRAWING ISSUE HISTORY

SD 07-28-2014 Schematic Design 50% Construction Docs

95% REVIEW DOCUMENTS

AA PROJECT NUMBER


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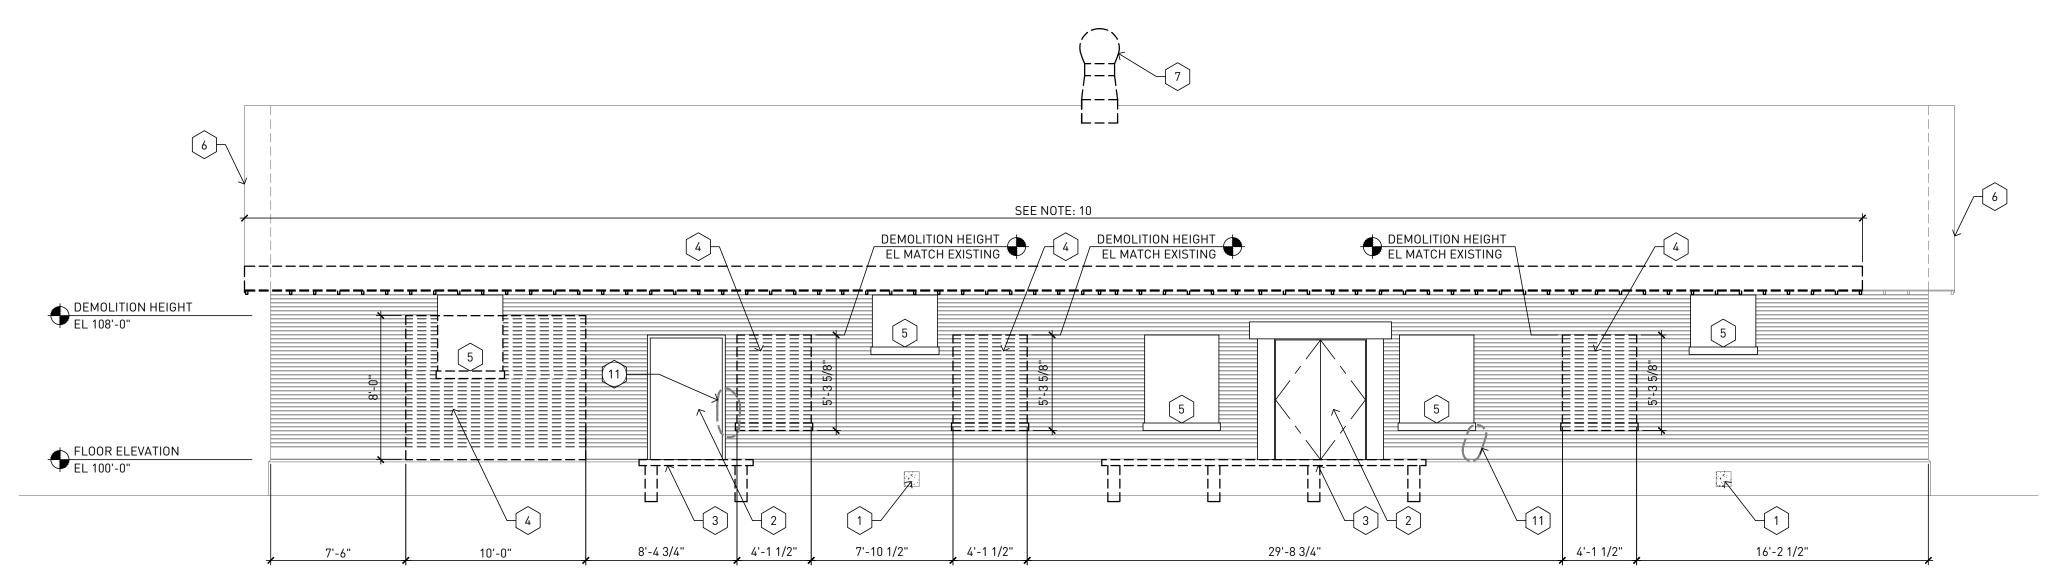
05-17-2014

SHEET TITLE
COVERSHEET


SHEET NUMBER

G000



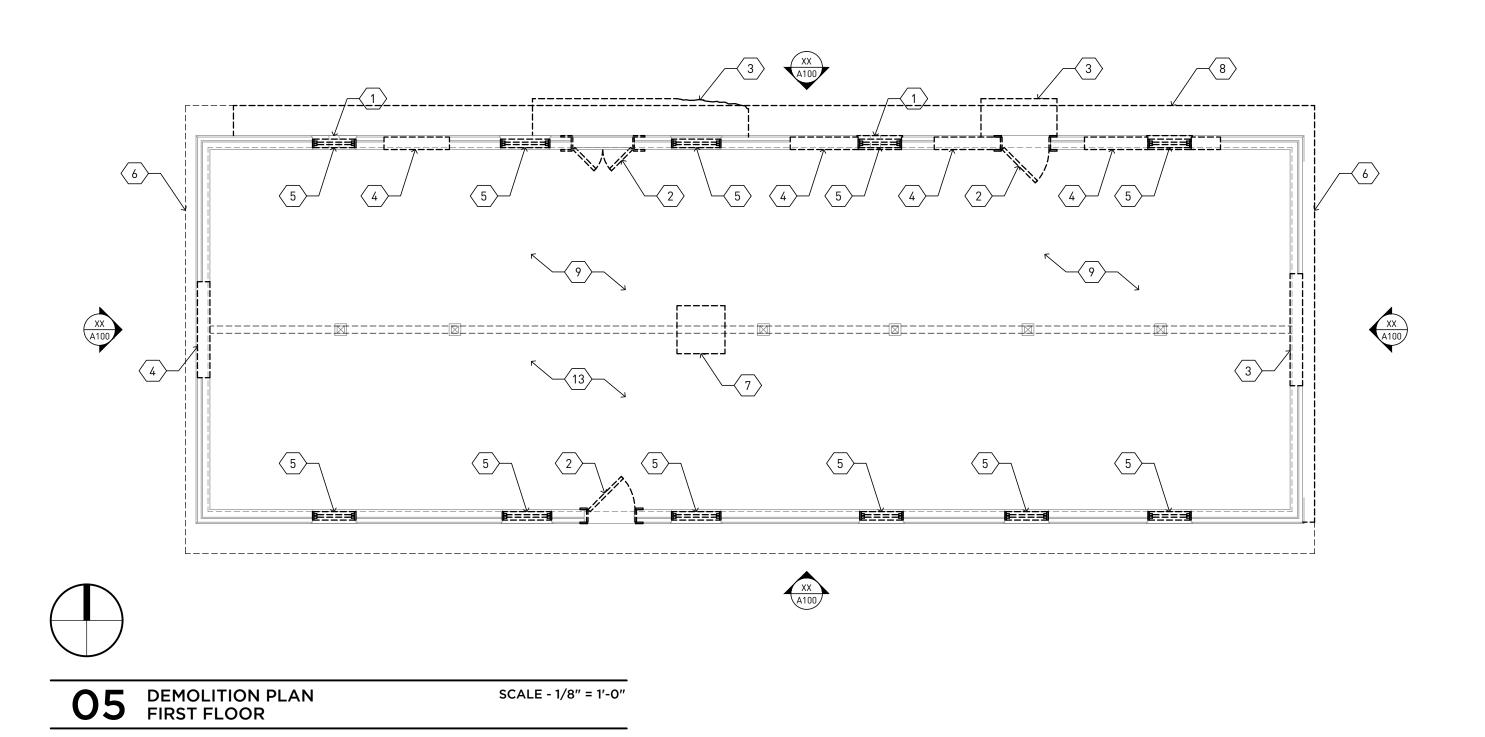


O4 EXISTING EXTERIOR ELEVATION NORTH ELEVATION SCALE - 3/16" = 1'-0"

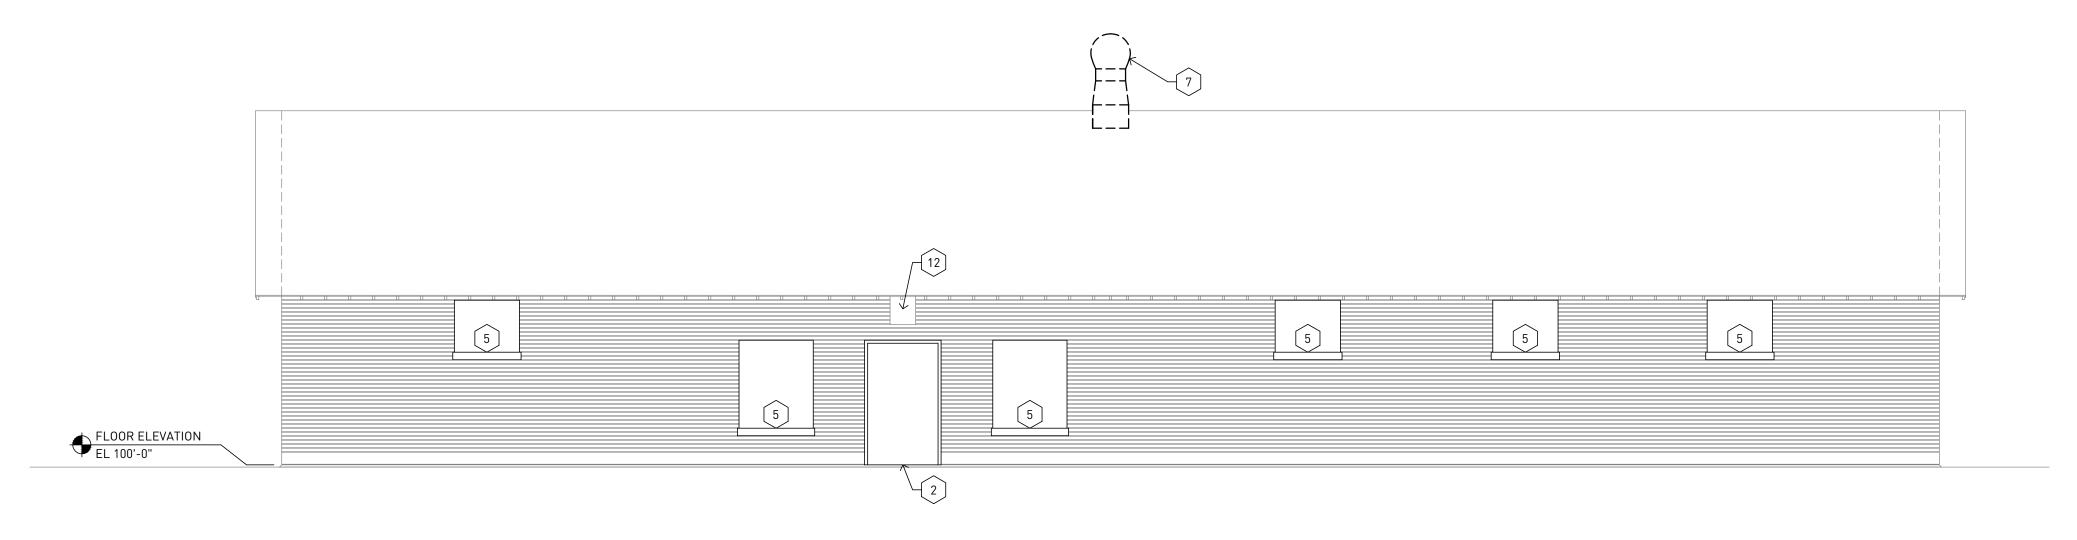

**02** EXISTING EXTERIOR ELEVATION SOUTH ELEVATION SCALE - 3/16" = 1'-0"



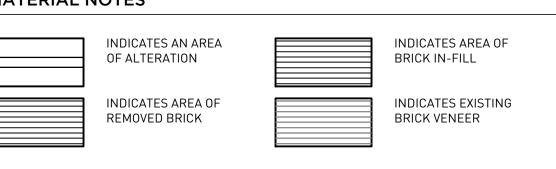


#### **DEMOLITION ELEVATIONS GENERAL DEMOLITION NOTES**


- A. REMOVE ALL EXISTING WINDOWS AND ASSOCIATED TRIM. PREP OPENING FOR NEW CONSTRUCTION.
- B. REMOVE ALL EXISTING SHINGLES AND ASSOCIATED UNDERLAYMENT LAYERS TO EXISTING WOOD DECKING.
- C. SALVAGE EXISTING BRICK FOR REUSE.
- D. PREPARE ALL EXPOSED WOOD FOR EXTERIOR PRIMER AND PAINT.
- E. COORDINATE DEMOLITION OF LOAD BEARING WALLS WITH STRUCTURAL PLANS.

#### **DEMOLITION PLANS AND ELEVATIONS EXISTING BUILDING KEYNOTES**

- REMOVE EXISTING FOUNDATION VENT.
- 2. REMOVE EXISTING DOOR LEAF, CASING AND JAMB. SALVAGE DOOR AND RETURN TO OWNER.
- 3. REMOVE EXISTING REINFORCED CONCRETE LOADING DOCK AND DIAGONAL SUPPORT STRUCTURE - SAW-CUT AND GRIND FLUSH WITH FACE OF FOUNDATION WALL.
- 4. DEMOLISH EXISTING MASONRY WALL FOR NEW DOOR/WINDOW/OPENING REMOVE MASONRY ON EITHER SIDE OF FINISHED MASONRY OPENING TO PROVIDE BEARING FOR NEW PRECAST CONCRETE LINTEL ABOVE.
- 5. REMOVE EXISTING WOOD WINDOW AND ASSOCIATED TRIM.
- 6. REMOVE EXISTING WOOD RAKE TRIM.
- 7. REMOVE EXISTING ROOM VENTILATION TURBINE.
- 8. CUT EXISTING TRUSS TAILS FLUSH WITH FACE OF BUILDING AT NEW ROOF AREAS.
- 9. REMOVE EXISTING CONCRETE SLAB-ON-GRADE.
- 10. OUTLINE OF NEW ADDITION IN ELEVATION.
- 11. BRICK MASONRY REPAIR AND RE-POINTING.
- 12. REMOVE THRU WALL VENTILATION FAN.
- 13. REMOVE EXISTING SHINGLE ROOF AND UNDERLAYMENT.

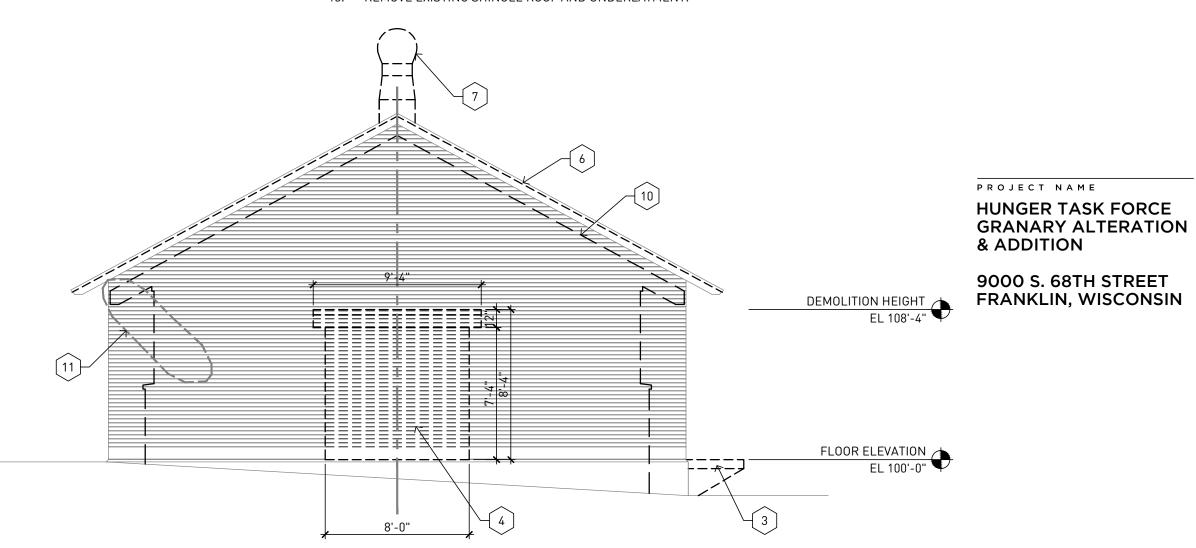

O3 EXISTING EXTERIOR ELEVATION EAST ELEVATION SCALE - 3/16" = 1'-0"

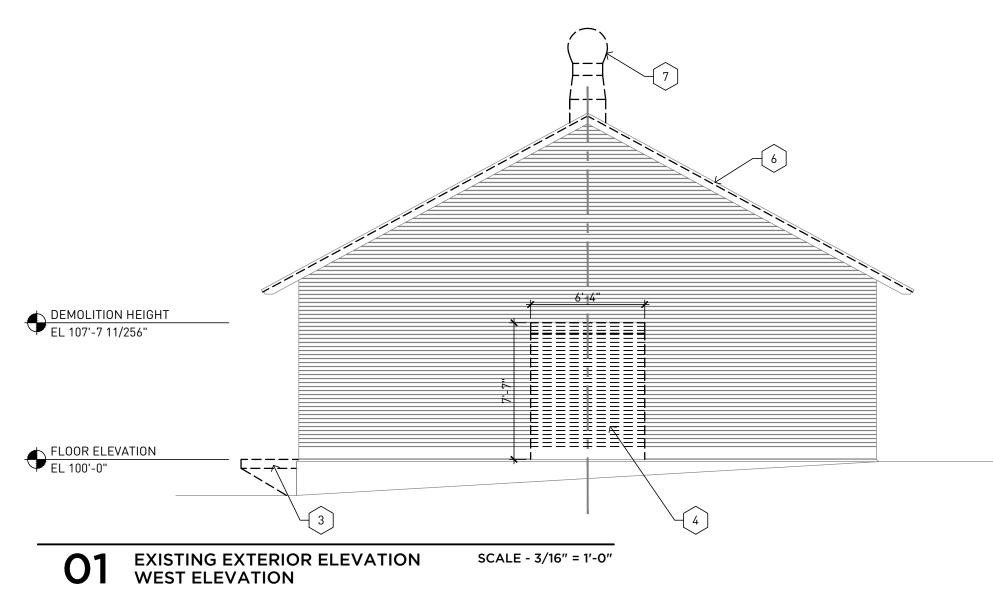

DRAWING ISSUE HISTORY 
 SD
 07-28-2014
 Schematic Design

 CD50
 11-20-2014
 50% Construction Docs

 CD95
 05-17-2015
 95% Review Documents

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milwaukee, wisconsin 53215 arcint-architecture.com


SET TYPE 95% REVIEW DOCUMENTS

AA PROJECT NUMBER

DATE 05-17-2014

SHEET TITLE ELEVATIONS AND PLAN DEMOLITION

SHEET NUMBER

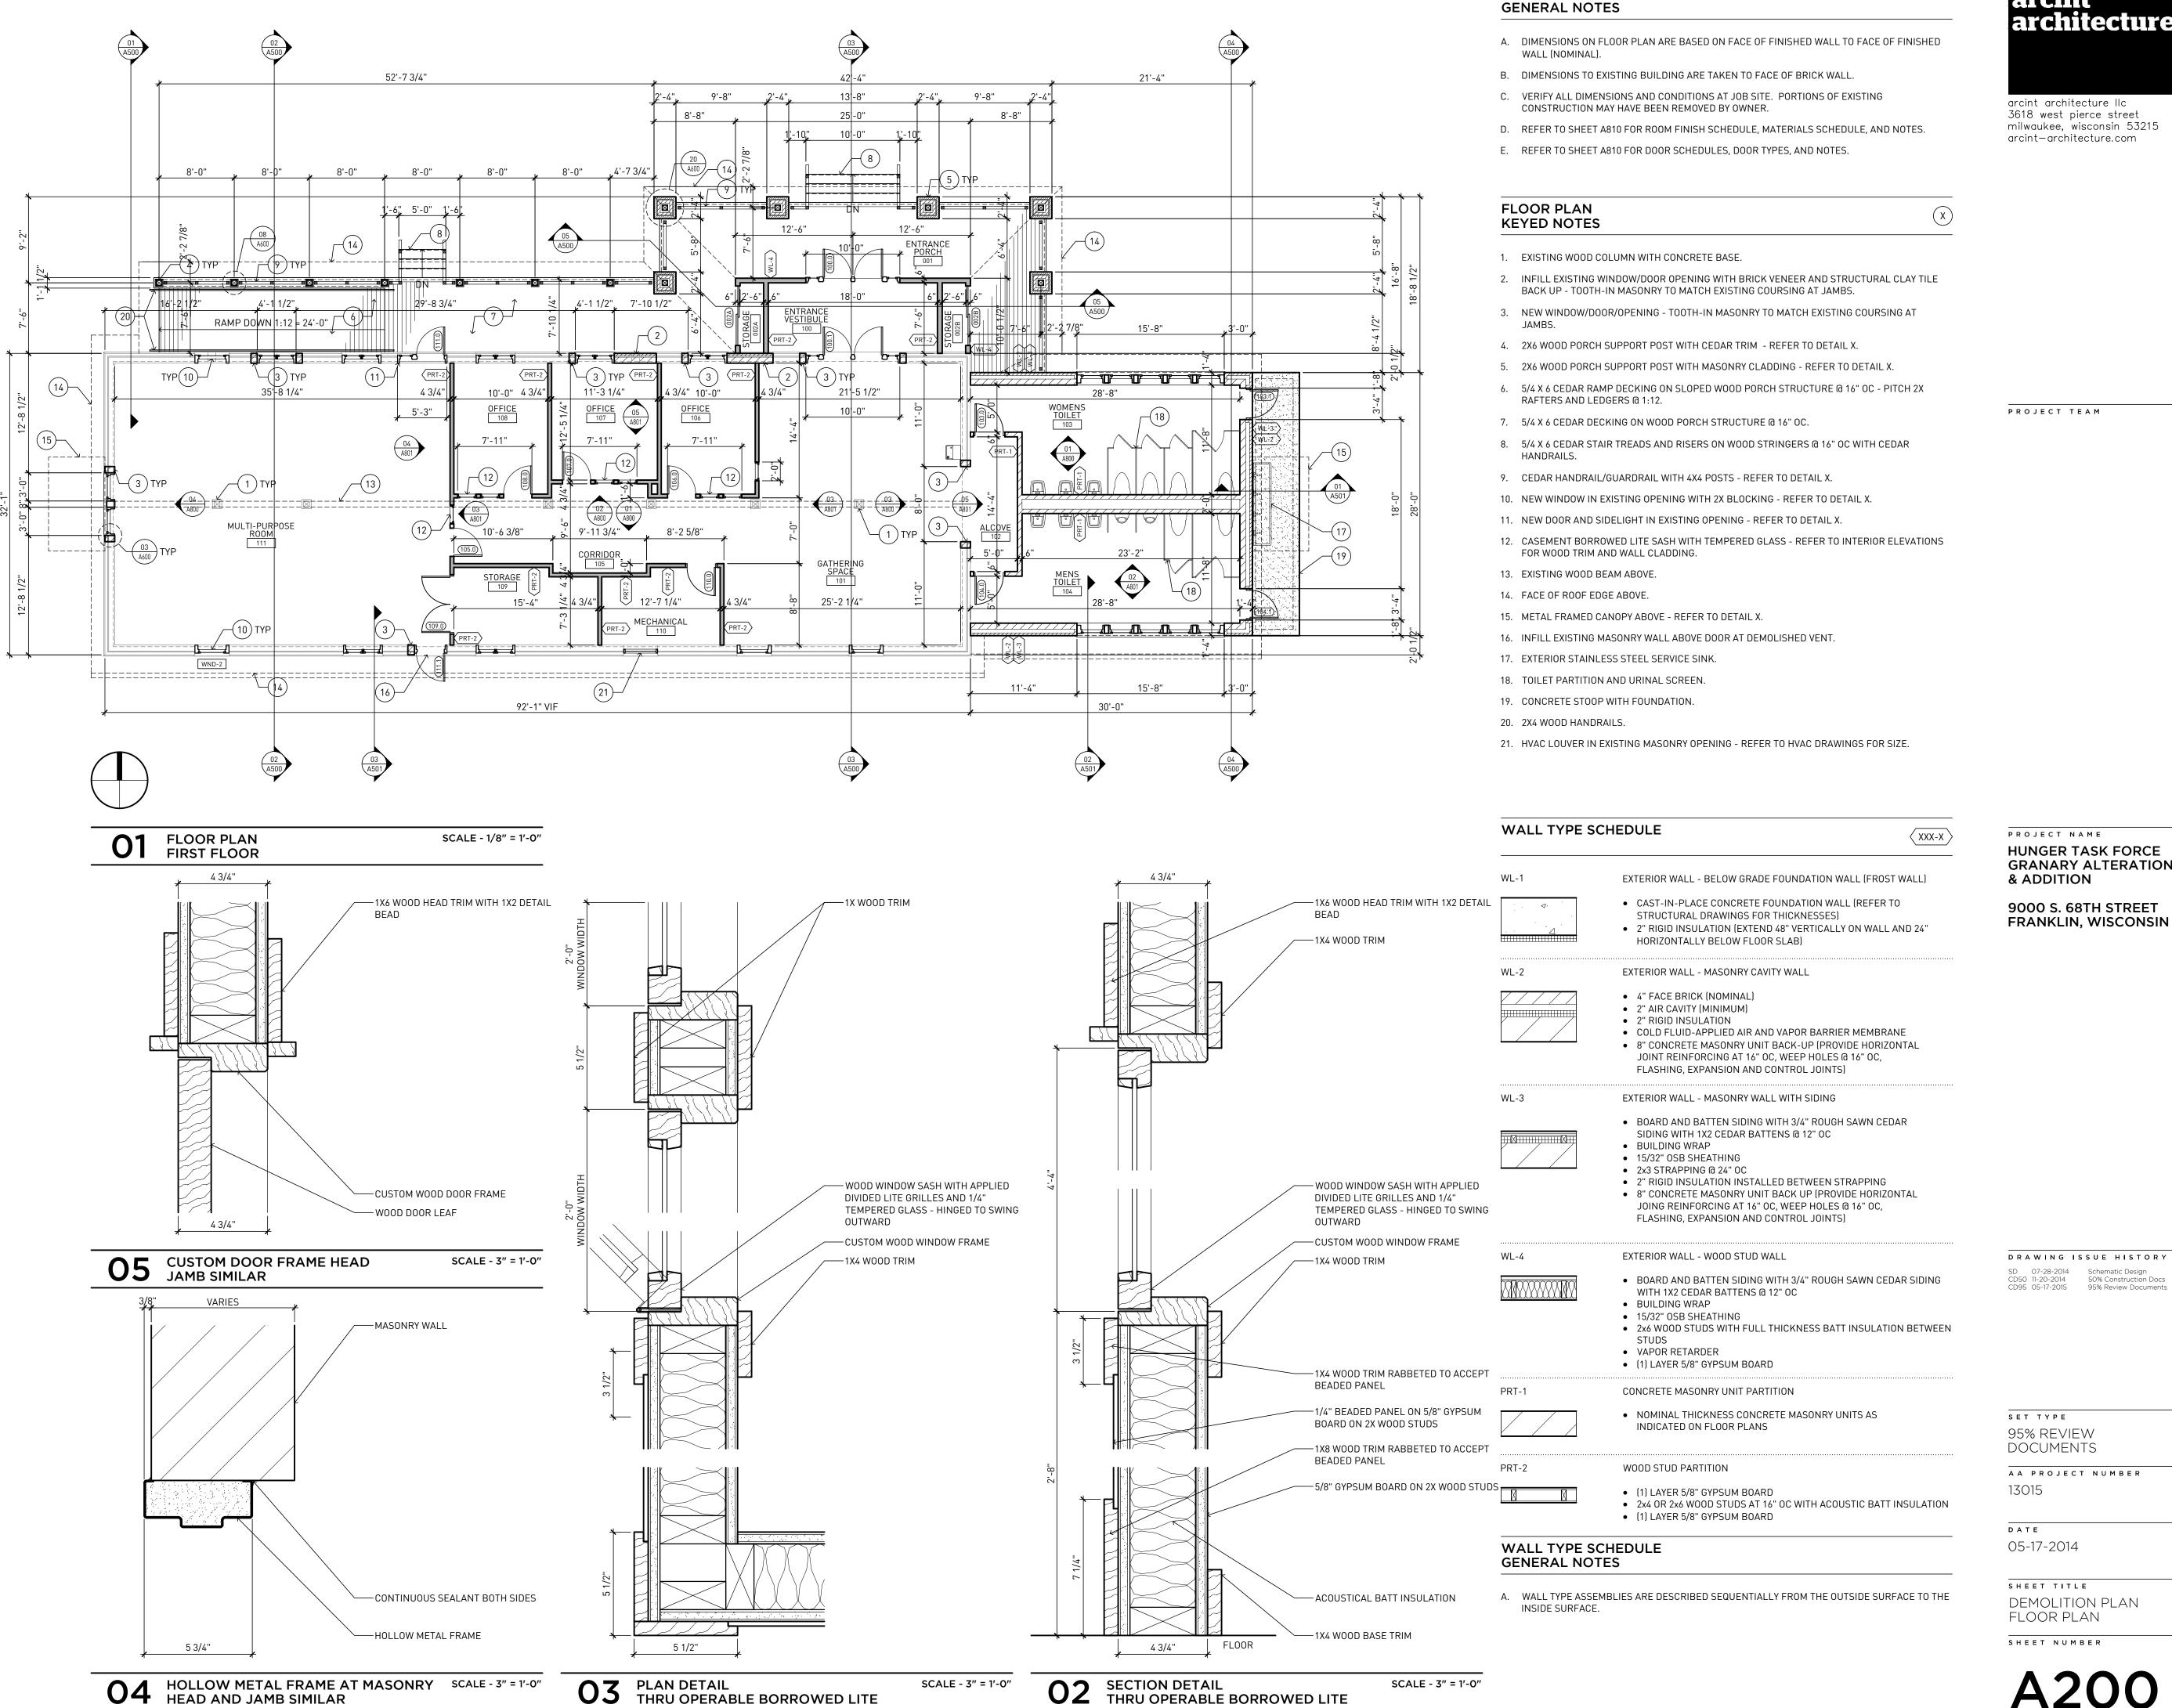

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**FLOOR PLAN** 

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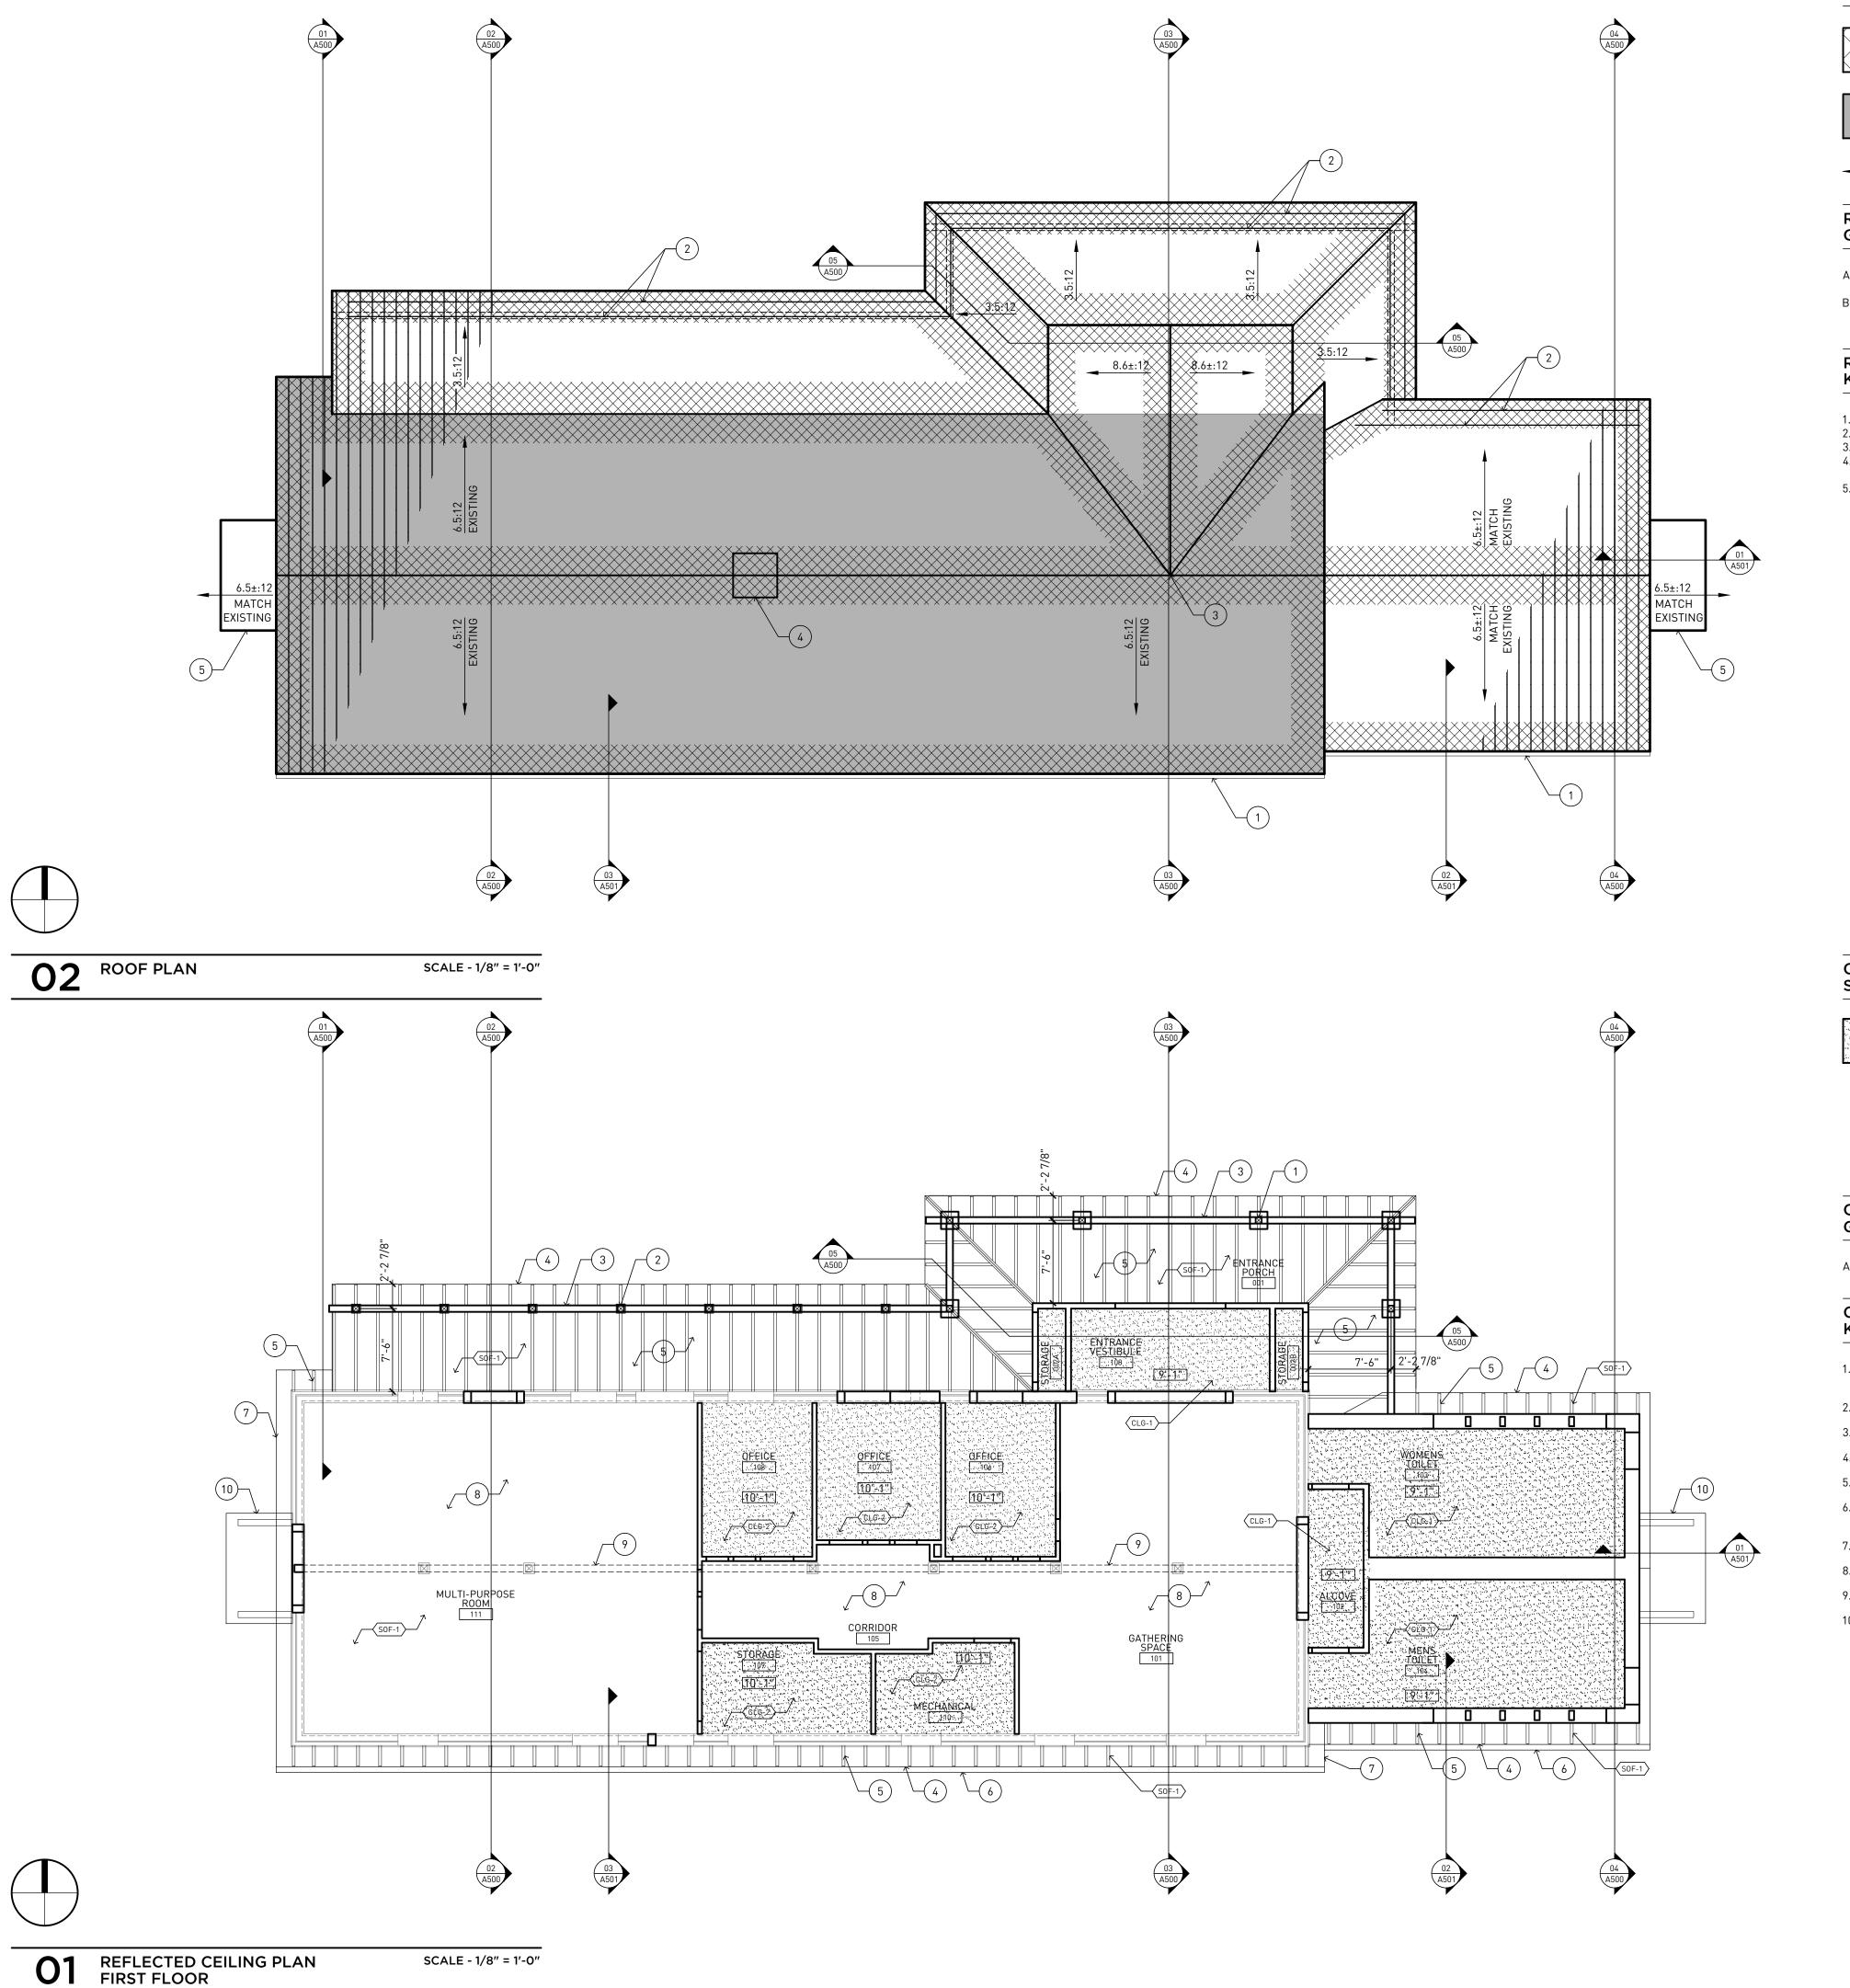
**HUNGER TASK FORCE GRANARY ALTERATION** 

FRANKLIN, WISCONSIN

DRAWING ISSUE HISTORY

AA PROJECT NUMBER

DEMOLITION PLAN FLOOR PLAN



#### ROOF PLAN SYMBOLS LEGEND

LOCATION OF
SELF-ADHERING
RUBBERIZED ASPHALT
UNDERLAYMENT MEMBRANE



LOCATION OF NAILBASE OVER EXISTING ROOF STRUCTURE.



DIRECTION OF ROOF SLOPE

#### ROOF PLAN GENERAL NOTES

- A. COORDINATE AND VERIFY ALL ROOF OPENINGS AND PENETRATIONS WITH STRUCTURAL, PLUMBING, HVAC, AND ELECTRICAL REQUIREMENTS.
- B. PROVIDE WATER TIGHT INTEGRITY AT ALL PENETRATIONS AND EQUIPMENT PER ROOFING MANUFACTURERS STANDARD DETAILS AND REQUIREMENTS FOR WARRANTY AND CURRENT NRCA STANDARDS.

#### ROOF PLAN KEYED NOTES



- 1. HALF-ROUND GUTTER AND CORRUGATED ROUND DOWNSPOUT.
- BAR-TYPE SNOW GUARDS.
   MATCH RIDGE HEIGHT.
- 4. PATCH EXISTING WOOD DECKING AND STRUCTURE AT DEMOLISHED TURBINE ROOF
- VENTILATOR.
  5. METAL FRAMED CANOPY BELOW.

PROJECT TEAM

PROJECT NAME

& ADDITION

HUNGER TASK FORCE GRANARY ALTERATION

9000 S. 68TH STREET FRANKLIN, WISCONSIN

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CEILING PLAN SYMBOLS LEGEND

GYPSUM BOARD CEILING

GYPSUM BOARD CEILING

SURFACE MOUNTED DOWN LIGHT

RETURN, TRANSFER, EXHAUST GRILLE

CEILING MOUNTED EXIT LIGHT

SUPPLY GRILLE

CEILING PLAN GENERAL NOTES

A. REFER TO ELECTRICAL DRAWINGS FOR LIGHTING LAYOUT.

#### CEILING PLAN KEYED NOTES

BOXED-OUT AND TAPERED WOOD CLADDING AROUND 6X6 WOOD POST AT ENTRY PORCH -

WALL MOUNTED EXIT LIGHT

- REFER TO DETAIL X.

  2. 6X6 WOOD POST WRAPPED WITH WOOD TRIM REFER TO DETAIL X.
- 3. COMPOSITE WOOD BEAM.
- 4. EDGE OF ROOF.
- 5. EXPOSED 2X OUTLOOKERS PAINTED.
- 6" HALF-ROUND GUTTER SYSTEM WITH HANGING BRACKETS AND ROUND CORRUGATED DOWNSPOUTS.
- 7. NEW RAKE TRIM AT EXISTING ROOF EDGE PAINTED.
- 8. ICE-BLAST CLEAN EXISTING TRUSS STRUCTURE TO REMAIN.
- 9. ICE-BLAST CLEAN EXISTING MULTI-LAYER 2X WOOD BEAM TO REMAIN.
- 10. STEEL CANOPY STRUCTURE.

DRAWING ISSUE HISTORY

SD 07-28-2014 Schematic Design
CD50 11-20-2014 50% Construction Docs
CD95 05-17-2015 95% Review Documents

95% REVIEW DOCUMENTS

A A PROJECT NUMBER

13015

DATE 05-17-2014

REFLECTED CEILING AND ROOF PLAN

SHEET NUMBER

FLOOR ASSEMBLY - CONCRETE SLAB ON GRADE

SCHEDULE FOR LOCATIONS OF POLISHED FINISH.

BLOWN-IN CELLULOSE INSULATION IN TRUSS SPACE.

GYPSUM BOARD CEILING ASSEMBLY - AT EXISTING ROOF TRUSSES

FLOOR ASSEMBLY - PORCH DECKING

GYPSUM BOARD CEILING ASSEMBLY

OUT BETWEEN TRUSS BOTTOM CHORDS.

REINFORCED CONCRETE SLAB ON VAPOR RETARDER ON 6-INCH DRAINAGE FILL.

REFER TO STRUCTURAL DRAWINGS FOR SLAB THICKNESSES. REFER TO ROOM FINISH

5/4X6 CEDAR WOOD DECKING ON WOOD BALCONY FRAMING - PROVIDE CONCEALED

ONE LAYER 5/8" GYPSUM BOARD ATTACHED TO UNDERSIDE OF WOOD TRUSSES OR

RAFTERS. PROVIDE VAPOR RETARDER AT UNDERSIDE OF CEILING JOISTS AND R-50

ONE LAYER 5/8" GYPSUM BOARD ATTACHED TO 7/8" METAL FURRING CHANNELS ON

UNDERSIDE OF WOOD TRUSSES - PROVIDE ACOUSTICAL INSULATION LOOSLY ROLLED

ASSEMBLY KEYNOTES STANDING SEAM METAL ROOFING ASSEMBLY - AT EXISTING ROOF STRUCTURE METAL SNAP-SEAM ROOFING PANELS ON ICE-AND-WATER SHIELD (WHERE INDICATED) ON 4-1/2" IN NOMINAL THICKNESS NAILABLE INSULATION SYSTEM ON VAPOR REFER TO EXTERIOR WALL TYPE SCHEDULE ON SHEET G010

RETARDER ON OSB SHEATHING ON EXISTING WOOD DECKING AND STRUCTURAL REFER TO INTERIOR PARTITION TYPE SCHEDULE ON SHEET G010 RFG-1B STANDING SEAM METAL ROOFING ASSEMBLY - AT NEW ROOF STRUCTURE METAL SNAP-SEAM ROOFING PANELS ON ICE-AND-WATER SHIELD (WHERE INDICATED)

ON PLYWOOD SHEATHING ON WOOD TRUSS OR RAFTER STRUCTURAL SYSTEM. RFG-2 CORRUGATED METAL ROOFING ASSEMBLY - AT AWNINGS CORRUGATED METAL ROOFING PANELS ATTACHED TO STEEL SUPPORT STRUCTURE

MATERIAL KEYNOTES

GLAZED FACE BRICK VENEER - FIELD COLOR TYPE: MODULAR SIZE GLAZED FACE BRICK MANUFACTURER: GLEN GARY HANLEY PLANT GLAZED COLOR: WHITE G791

GLAZED FACE BRICK VENEER - ACCENT COLOR TYPE: MODULAR SIZE GLAZED FACE BRICK MANUFACTURER: GLEN-GARY HANLEY PLANT COLOR: MINT G10-8071 OR SKYLINE G419

SEAMLESS GUTTER AND DOWNSPOUT GUTTER TYPE: HALF-ROUND STYLE GUTTER WITH 6" PROFILE AND HANGER SYSTEM. DOWNSPOUT TYPE: CORRUGATED ROUND.

COLOR: GALVALUME. WOOD SOFFIT SYSTEM TYPE AND PATTERN: EXPOSED WOOD OUTLOOKERS OR EXISTING WOOD RAFTER TAILS.

COLOR: PAINTED - REFER TO EXTERIOR ELEVATIONS FOR COLOR. DWD-X REFER TO DOOR TYPES ON SHEET A811.

WND-X WINDOWS REFER TO WINDOW SCHEDULE. **ELEVATION GENERAL NOTES** 

> A. DIMENSIONS ON FLOOR PLAN ARE BASED ON FACE OF FINISHED WALL TO FACE OF FINISHED WALL (NOMINAL).

B. VERIFY ALL DIMENSIONS AND CONDITIONS AT JOB SITE. PORTIONS OF EXISTING CONSTRUCTION MAY HAVE BEEN REMOVED BY OWNER.

C. REFER TO SHEET XXX FOR ROOM FINISH SCHEDULE, MATERIALS SCHEDULE, AND NOTES. D. REFER TO SHEET XXX FOR DOOR SCHEDULES, DOOR TYPES, AND NOTES.

**ELEVATION KEYED NOTES** 

1. STEEL FRAME TRUSS. SEE STRUCTURAL FOR REFERENCE.

2. STAINLESS STEEL EXTERIOR WALL HUNG SINK. WOOD COLUMN - TYPE 1. SEE DETAIL x/A501. 4. WOOD COLUMN - TYPE 2. SEE DETAIL x/A501. 5. WOOD RAILING. SEE DETAIL x/A501.

6. DECORATIVE WOOD SKIRT. SEE DETAIL x/A501. 7. RETAINING WALL. SEE CIVIL FOR REFERENCE.


8. RE-USE SALVAGED BRICK FOR SOLIDER COURSE DETAILING AT WINDOW HEAD.

9. WOOD STAIRS. SEE DETAIL x/A501. 10. LINE OF GABLE FACE.

11. EXISTING BRICK.

12. ADA ACCESS RAMP. 13. AREA OF IN-FILLED RE-USED BRICK.

14. CONTINUOUS RIDGE VENT. 15. REPLACE EXISTING GABLE TRIM.

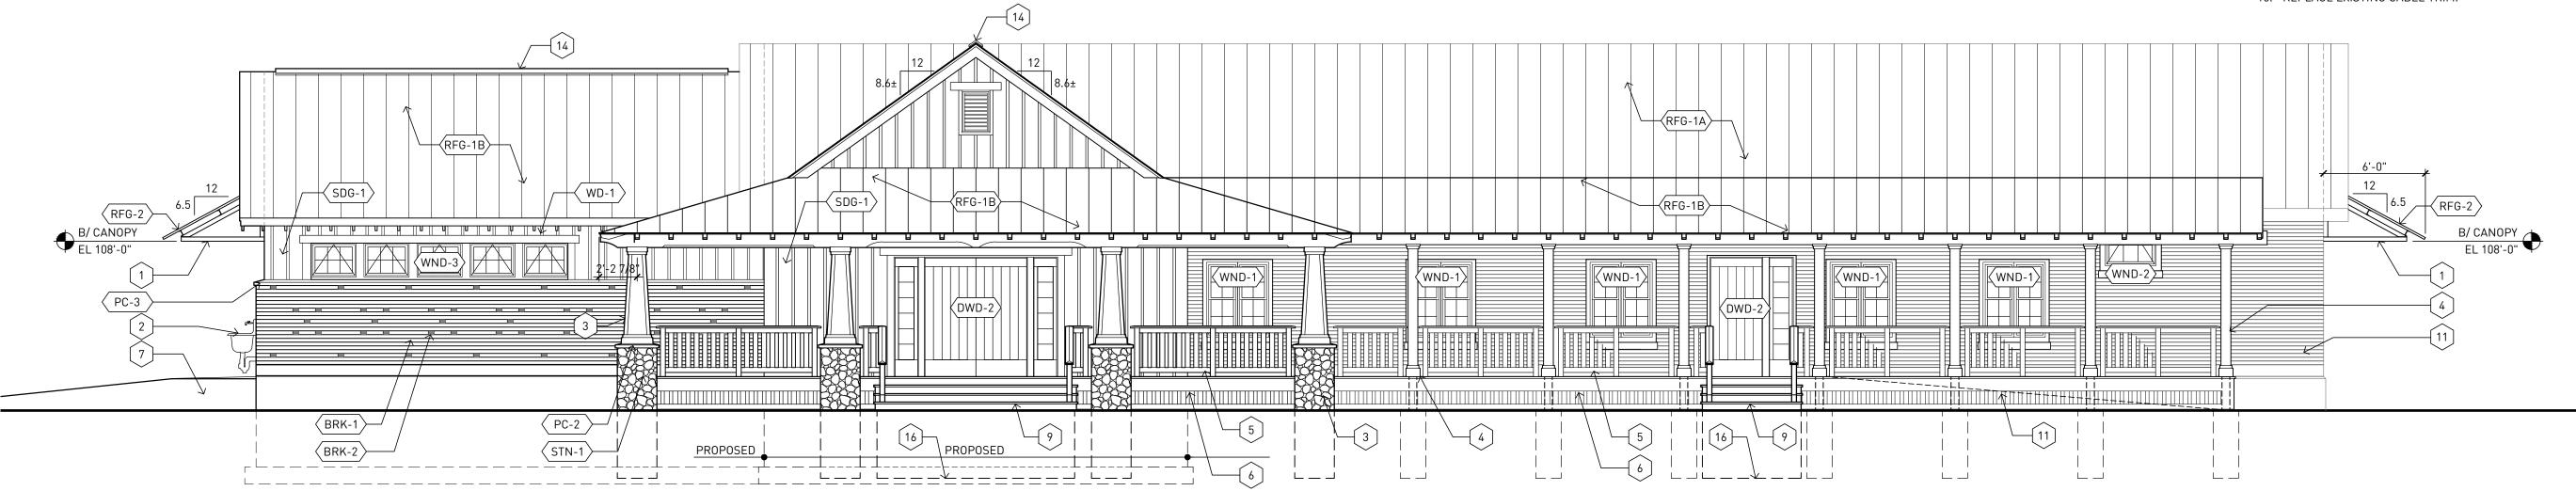

STONE VENEER - COLUMN BASE

PRECAST CONCRETE WINDOW SILL

COLOR: MATCH LIMESTONE BUFF

COLOR: MATCH LIMESTONE BUFF

COLOR: MATCH LIMESTONE BUFF

METAL COUNTERFLASHING AND REGLET

COLOR: SPLIT FIELD STONE

PRECAST CONCRETE CAP

PRECAST CONCRETE SILL

BOARD AND BATTEN SIDING

EXTERIOR WOOD TRIM

MANUFACTURER: HALQUIST STONE COMPANY

TYPE AND PATTERN: 3/4" ROUGH-SAWN CEDAR PLYWOOD WITH 1x2 CEDAR BATTEN

TYPE AND PATTERN: 5/4" ROUGH-SAWN CEDAR DIMENSIONAL RUNNING TRIM BOARDS

STRIPS AT 12" OC WITH 5/4" x 4" ROUGH-SAWN TRIM AT CORNERS.

WITH 3/4" ROUGH-SAWN CEDAR PLYWOOD REFER TO TRIM DETAILS


COLOR: AS SELECTED FROM MANUFACTURER'S STANDARD COLORS.

COLOR: PAINTED - REFER TO EXTERIOR ELEVATIONS FOR COLOR.


COLOR: PAINTED - REFER TO EXTERIOR ELEVATIONS FOR COLOR.

TYPE: FIELD STONE


SCALE - 3/16" = 1'-0" PROPOSED EXTERIOR ELEVATION PROPOSED EXTERIOR NORTH ELEVATION

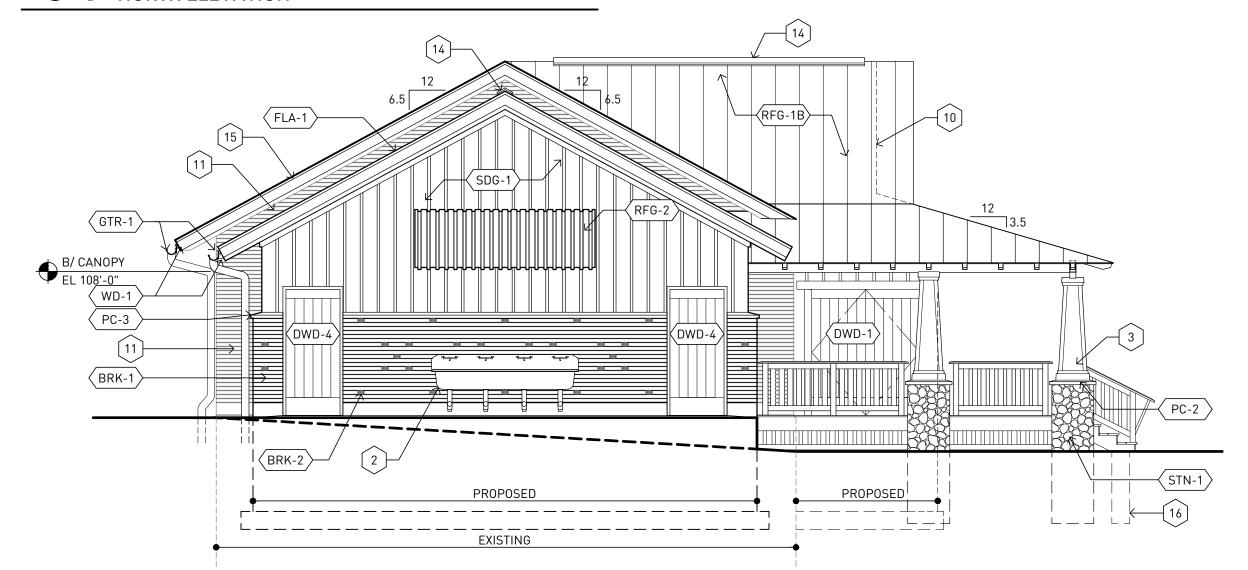

PROPOSED EXTERIOR ELEVATION EAST ELEVATION SCALE - 3/16" = 1'-0"

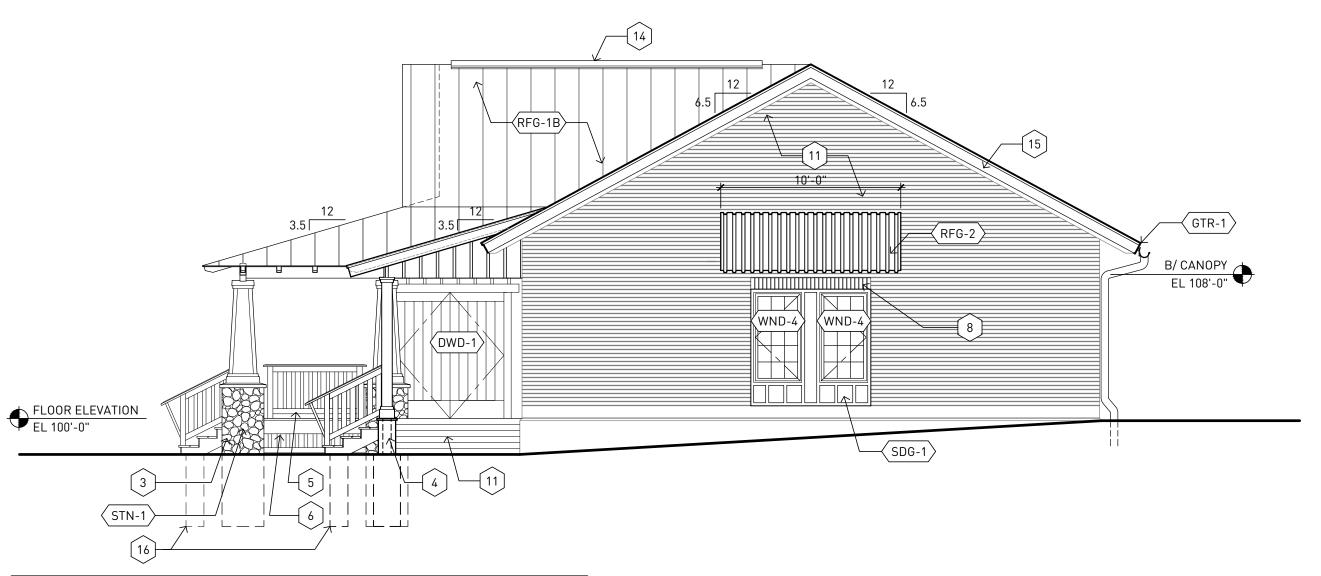

PROPOSED EXTERIOR ELEVATION WEST ELEVATION SCALE - 3/16" = 1'-0"

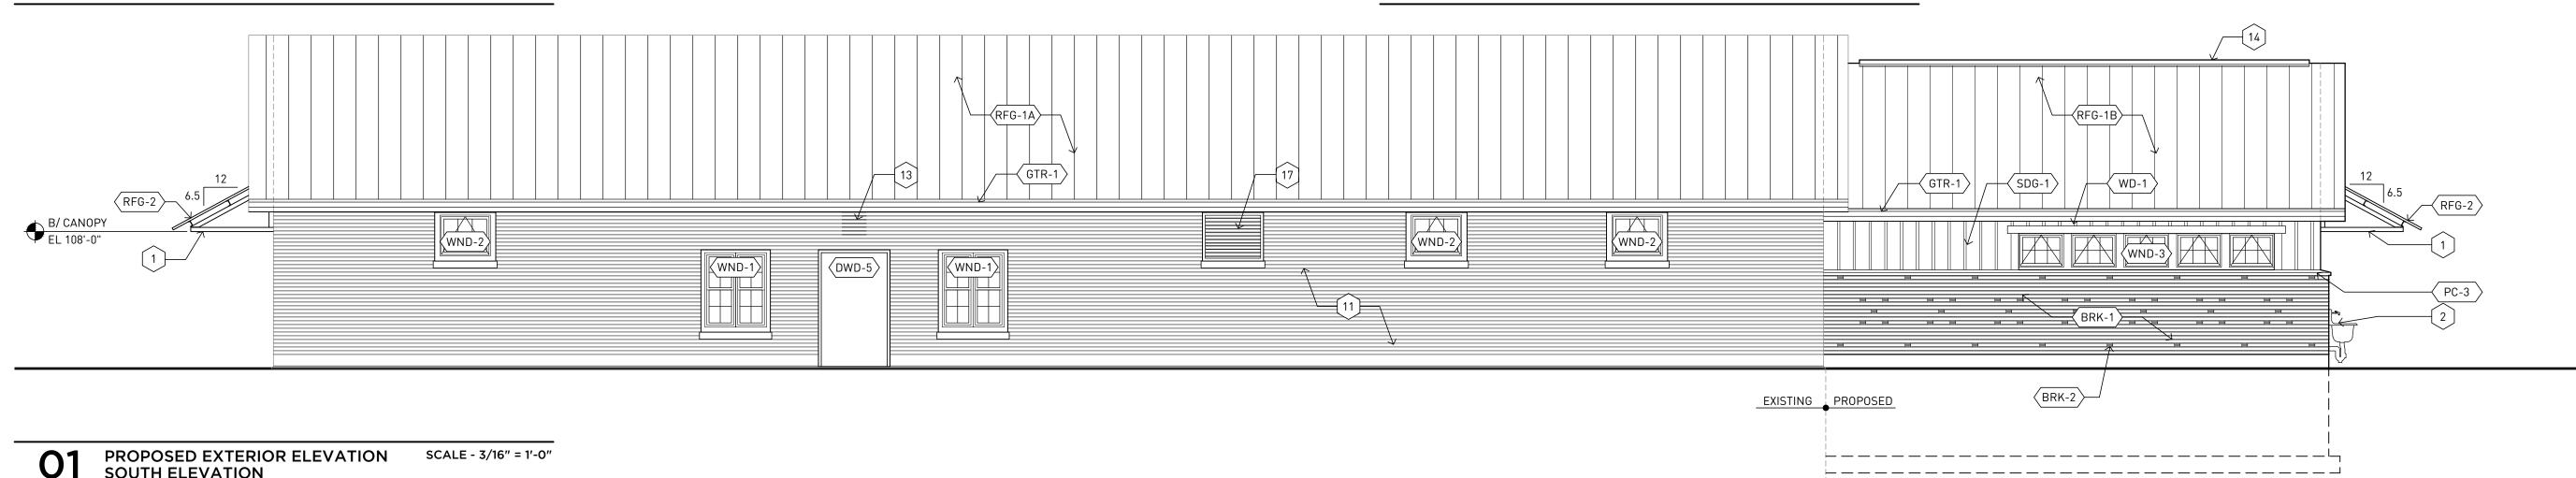

PROJECT NAME **HUNGER TASK FORCE GRANARY ALTERATION** & ADDITION

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3618 west pierce street

arcint-architecture.com

PROJECT TEAM

milwaukee, wisconsin 53215

architecture

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 SD
 07-28-2014
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 95% Review Documents

SET TYPE 95% REVIEW DOCUMENTS

AA PROJECT NUMBER 13015

DATE 05-17-2014

SHEET TITLE EXTERIOR ELEVATIONS PROPOSED

SHEET NUMBER

O1 PROPOSED EXTERIOR ELEVATION SOUTH ELEVATION

 $\langle XXX-1 \rangle$ 

ASSEMBLY KEYNOTES REFER TO EXTERIOR WALL TYPE SCHEDULE ON SHEET G010

REFER TO INTERIOR PARTITION TYPE SCHEDULE ON SHEET G010

FLOOR ASSEMBLY - CONCRETE SLAB ON GRADE REINFORCED CONCRETE SLAB ON VAPOR RETARDER ON 6-INCH DRAINAGE FILL. REFER TO STRUCTURAL DRAWINGS FOR SLAB THICKNESSES. REFER TO ROOM FINISH SCHEDULE FOR LOCATIONS OF POLISHED FINISH.

FLOOR ASSEMBLY - PORCH DECKING 5/4X6 CEDAR WOOD DECKING ON WOOD BALCONY FRAMING - PROVIDE CONCEALED

GYPSUM BOARD CEILING ASSEMBLY ONE LAYER 5/8" GYPSUM BOARD ATTACHED TO UNDERSIDE OF WOOD TRUSSES OR RAFTERS. PROVIDE VAPOR RETARDER AT UNDERSIDE OF CEILING JOISTS AND R-50 BLOWN-IN CELLULOSE INSULATION IN TRUSS SPACE.

GYPSUM BOARD CEILING ASSEMBLY - AT EXISTING ROOF TRUSSES ONE LAYER 5/8" GYPSUM BOARD ATTACHED TO 7/8" METAL FURRING CHANNELS ON UNDERSIDE OF WOOD TRUSSES - PROVIDE ACOUSTICAL INSULATION LOOSLY ROLLED OUT BETWEEN TRUSS BOTTOM CHORDS.

RFG-1A STANDING SEAM METAL ROOFING ASSEMBLY - AT EXISTING ROOF STRUCTURE METAL SNAP-SEAM ROOFING PANELS ON ICE-AND-WATER SHIELD (WHERE INDICATED) ON 4-1/2" IN NOMINAL THICKNESS NAILABLE INSULATION SYSTEM ON VAPOR RETARDER ON OSB SHEATHING ON EXISTING WOOD DECKING AND STRUCTURAL

RFG-1B STANDING SEAM METAL ROOFING ASSEMBLY - AT NEW ROOF STRUCTURE METAL SNAP-SEAM ROOFING PANELS ON ICE-AND-WATER SHIELD (WHERE INDICATED) ON PLYWOOD SHEATHING ON WOOD TRUSS OR RAFTER STRUCTURAL SYSTEM.

RFG-2 CORRUGATED METAL ROOFING ASSEMBLY - AT AWNINGS CORRUGATED METAL ROOFING PANELS ATTACHED TO STEEL SUPPORT STRUCTURE

MATERIAL KEYNOTES

GLAZED FACE BRICK VENEER - FIELD COLOR TYPE: MODULAR SIZE GLAZED FACE BRICK MANUFACTURER: GLEN GARY HANLEY PLANT GLAZED COLOR: WHITE G791

GLAZED FACE BRICK VENEER - ACCENT COLOR TYPE: MODULAR SIZE GLAZED FACE BRICK MANUFACTURER: GLEN-GARY HANLEY PLANT COLOR: MINT G10-8071 OR SKYLINE G419

STONE VENEER - COLUMN BASE TYPE: FIELD STONE MANUFACTURER: HALQUIST STONE COMPANY

COLOR: SPLIT FIELD STONE PRECAST CONCRETE WINDOW SILL COLOR: MATCH LIMESTONE BUFF

PRECAST CONCRETE CAP COLOR: MATCH LIMESTONE BUFF PRECAST CONCRETE SILL COLOR: MATCH LIMESTONE BUFF

BOARD AND BATTEN SIDING TYPE AND PATTERN: 3/4" ROUGH-SAWN CEDAR PLYWOOD WITH 1x2 CEDAR BATTEN STRIPS AT 12" OC WITH 5/4" x 4" ROUGH-SAWN TRIM AT CORNERS. COLOR: PAINTED - REFER TO EXTERIOR ELEVATIONS FOR COLOR.

EXTERIOR WOOD TRIM TYPE AND PATTERN: 5/4" ROUGH-SAWN CEDAR DIMENSIONAL RUNNING TRIM BOARDS WITH 3/4" ROUGH-SAWN CEDAR PLYWOOD REFER TO TRIM DETAILS COLOR: PAINTED - REFER TO EXTERIOR ELEVATIONS FOR COLOR.

METAL COUNTERFLASHING AND REGLET COLOR: AS SELECTED FROM MANUFACTURER'S STANDARD COLORS. SEAMLESS GUTTER AND DOWNSPOUT GUTTER TYPE: HALF-ROUND STYLE GUTTER WITH 6" PROFILE AND HANGER SYSTEM. DOWNSPOUT TYPE: CORRUGATED ROUND.

COLOR: GALVALUME.

WOOD SOFFIT SYSTEM TYPE AND PATTERN: EXPOSED WOOD OUTLOOKERS OR EXISTING WOOD RAFTER TAILS. COLOR: PAINTED - REFER TO EXTERIOR ELEVATIONS FOR COLOR.

DWD-X REFER TO DOOR TYPES ON SHEET A811.


WND-X WINDOWS

REFER TO WINDOW SCHEDULE.


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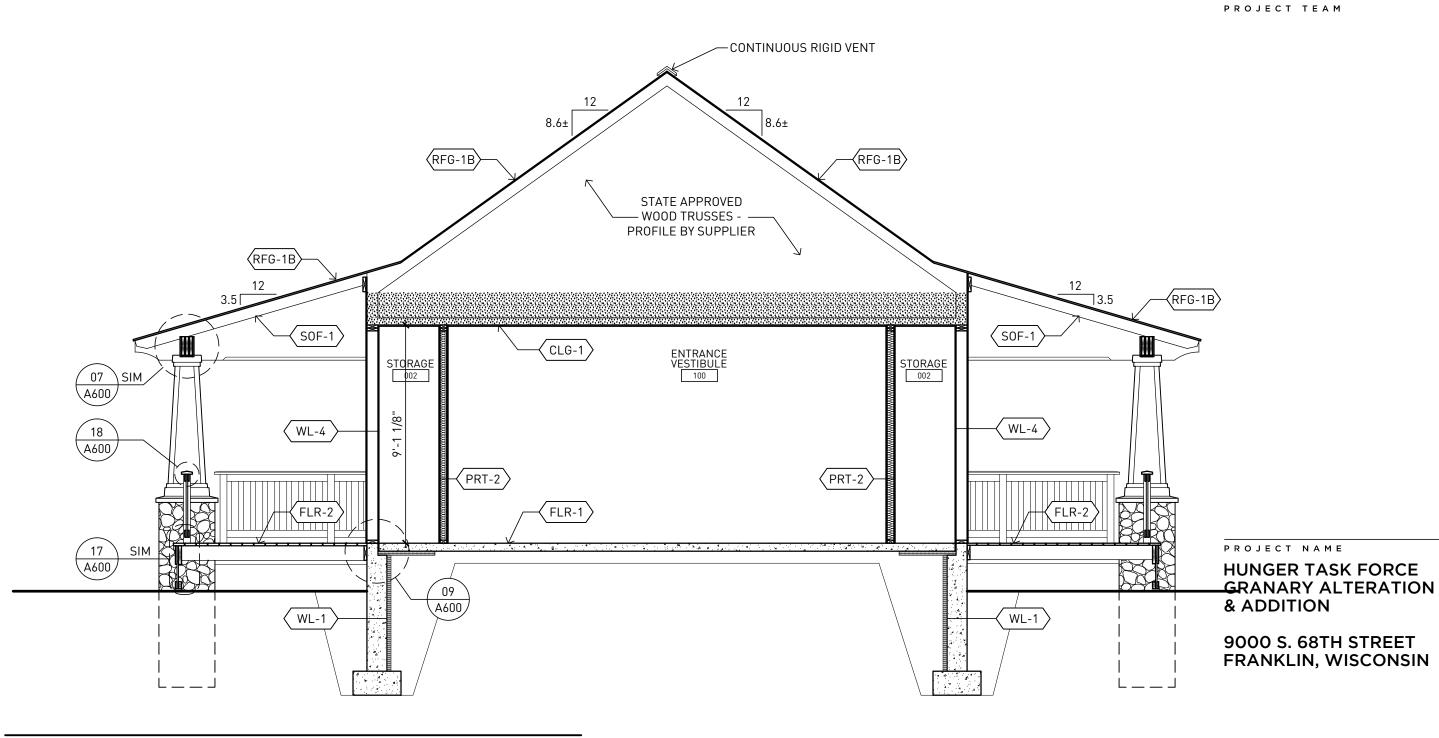
3618 west pierce street milwaukee, wisconsin 53215 arcint-architecture.com




O1 WALL SECTION - NORTH / SOUTH THRU FRONT WALL SCALE - 1/4" = 1'-0"

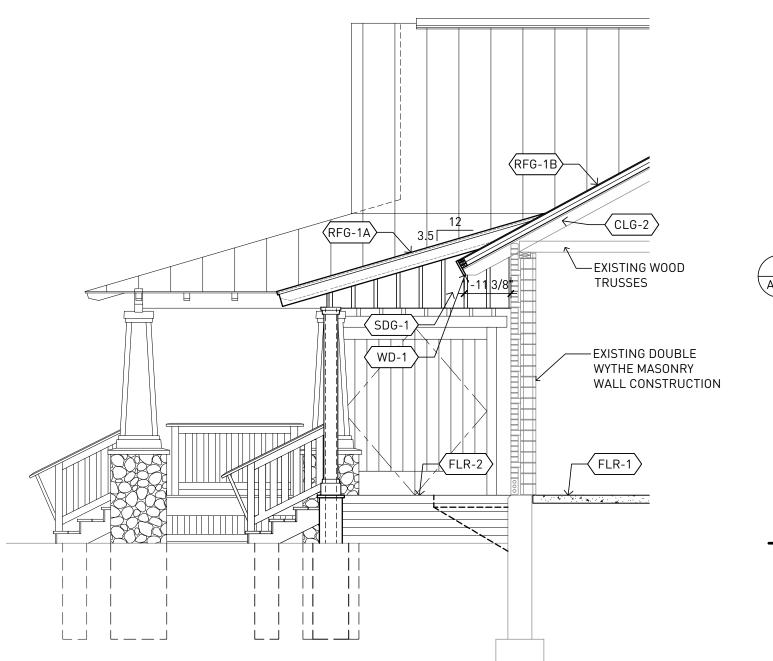


O4 BUILDING SECTION - ADDITION SCALE - 1/4" = 1'-0"

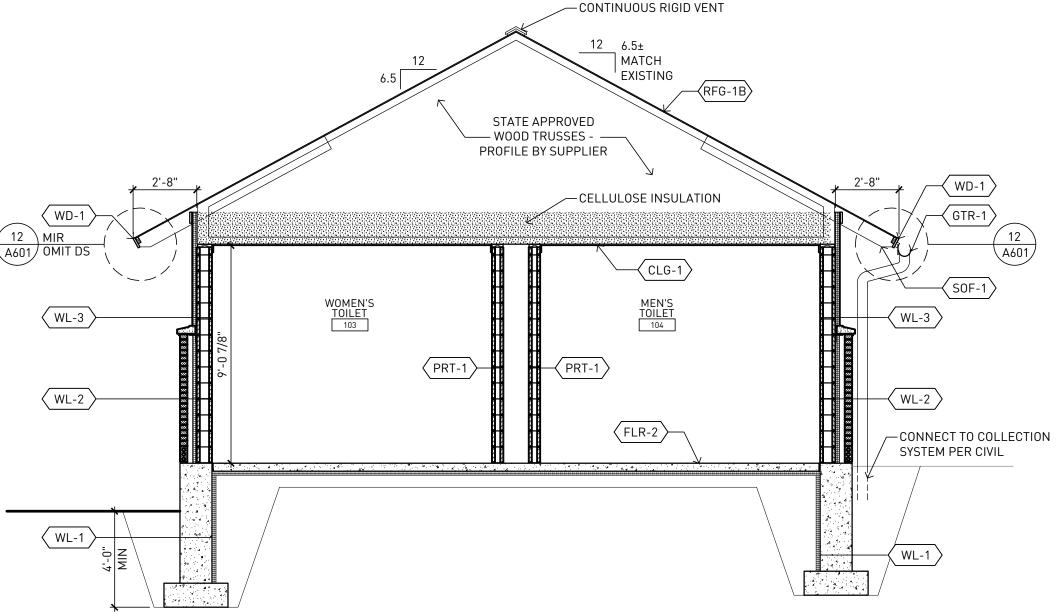

**05** BUILDING SECTION - EAST / WEST THRU FRONT ENTRY SCALE - 1/4" = 1'-0"

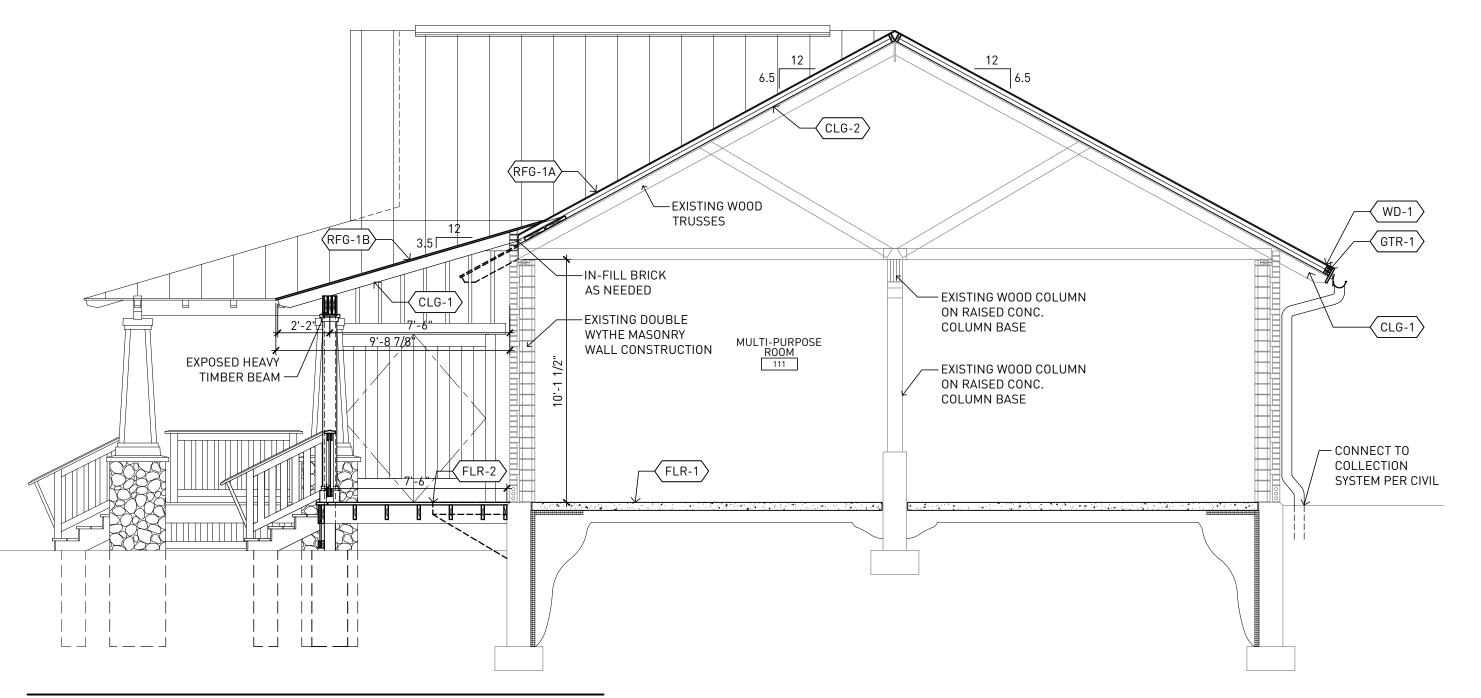

**02** BUILDING SECTION - SO NORTH / SOUTH THRU COVERED PORCH SCALE - 1/4" = 1'-0"

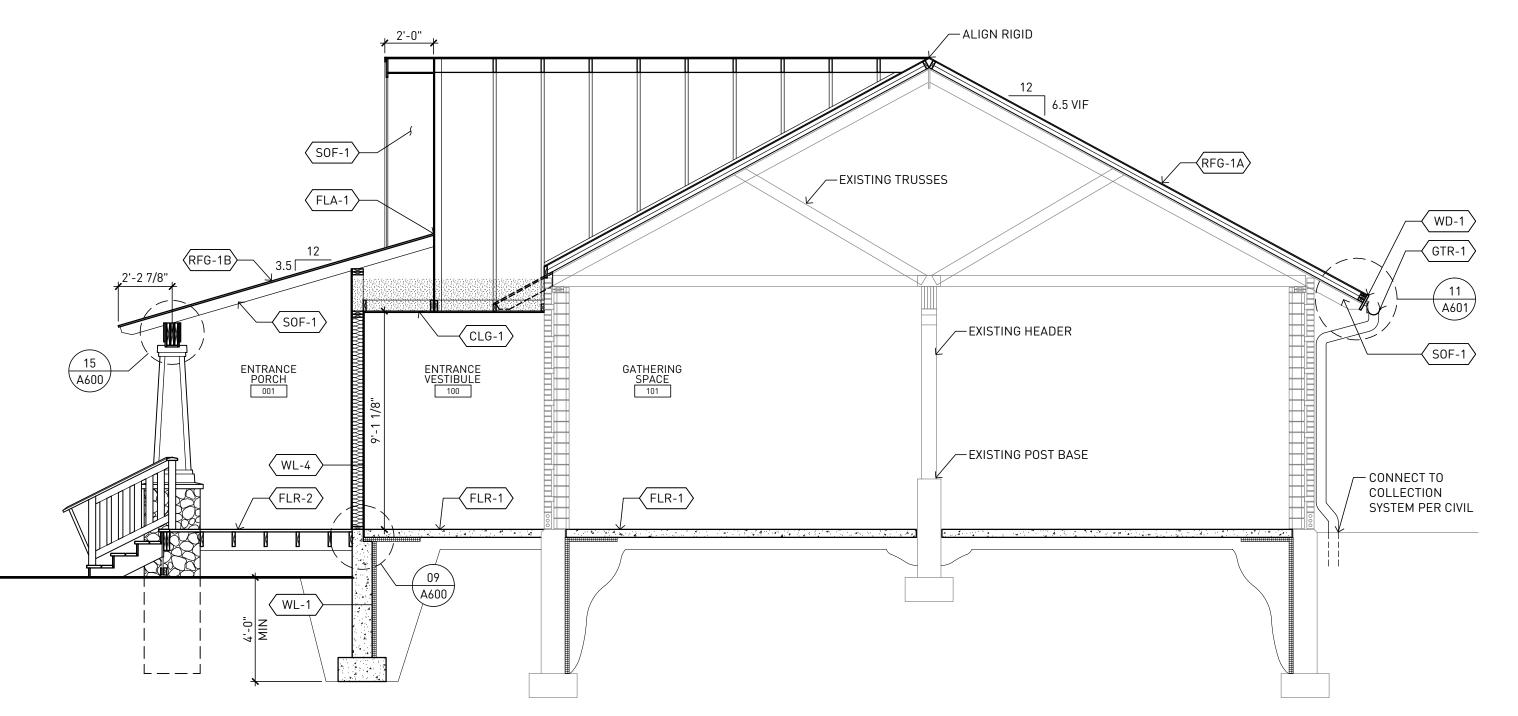

**03** BUILDING SECTION - NORTH / SOUTH THRU FRONT ENTRY SCALE - 1/4" = 1'-0" DRAWING ISSUE HISTORY 
 SD
 07-28-2014
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SET TYPE 95% REVIEW DOCUMENTS

AA PROJECT NUMBER 13015

DATE 05-17-2014

SHEET NUMBER

SHEET TITLE BUILDING SECTIONS

MATERIAL IDENTIFICATION KEYNOTES

ASSEMBLY KEYNOTES RFG-1A STANDING SEAM METAL ROOFING ASSEMBLY - AT EXISTING ROOF STRUCTURE STONE VENEER - COLUMN BASE TYPE: FIELD STONE METAL SNAP-SEAM ROOFING PANELS ON ICE-AND-WATER SHIELD (WHERE INDICATED) EXTERIOR WALLS ON 4-1/2" IN NOMINAL THICKNESS NAILABLE INSULATION SYSTEM ON VAPOR REFER TO EXTERIOR WALL TYPE SCHEDULE ON SHEET G010 COLOR: SPLIT FIELD STONE RETARDER ON OSB SHEATHING ON EXISTING WOOD DECKING AND STRUCTURAL INTERIOR PARTITIONS PRECAST CONCRETE WINDOW SILL REFER TO INTERIOR PARTITION TYPE SCHEDULE ON SHEET G010 COLOR: MATCH LIMESTONE BUFF RFG-1B STANDING SEAM METAL ROOFING ASSEMBLY - AT NEW ROOF STRUCTURE METAL SNAP-SEAM ROOFING PANELS ON ICE-AND-WATER SHIELD (WHERE INDICATED) FLOOR ASSEMBLY - CONCRETE SLAB ON GRADE PRECAST CONCRETE CAP ON PLYWOOD SHEATHING ON WOOD TRUSS OR RAFTER STRUCTURAL SYSTEM. COLOR: MATCH LIMESTONE BUFF REINFORCED CONCRETE SLAB ON VAPOR RETARDER ON 6-INCH DRAINAGE FILL. REFER TO STRUCTURAL DRAWINGS FOR SLAB THICKNESSES. REFER TO ROOM FINISH RFG-2 CORRUGATED METAL ROOFING ASSEMBLY - AT AWNINGS PRECAST CONCRETE SILL SCHEDULE FOR LOCATIONS OF POLISHED FINISH. PC-3 CORRUGATED METAL ROOFING PANELS ATTACHED TO STEEL SUPPORT STRUCTURE COLOR: MATCH LIMESTONE BUFF FLOOR ASSEMBLY - PORCH DECKING

MATERIAL KEYNOTES

5/4X6 CEDAR WOOD DECKING ON WOOD BALCONY FRAMING - PROVIDE CONCEALED

ONE LAYER 5/8" GYPSUM BOARD ATTACHED TO UNDERSIDE OF WOOD TRUSSES OR

RAFTERS. PROVIDE VAPOR RETARDER AT UNDERSIDE OF CEILING JOISTS AND R-50

ONE LAYER 5/8" GYPSUM BOARD ATTACHED TO 7/8" METAL FURRING CHANNELS ON

UNDERSIDE OF WOOD TRUSSES - PROVIDE ACOUSTICAL INSULATION LOOSLY ROLLED

GYPSUM BOARD CEILING ASSEMBLY

OUT BETWEEN TRUSS BOTTOM CHORDS.

BLOWN-IN CELLULOSE INSULATION IN TRUSS SPACE.

GYPSUM BOARD CEILING ASSEMBLY - AT EXISTING ROOF TRUSSES

BRK-1 GLAZED FACE BRICK VENEER - FIELD COLOR TYPE: MODULAR SIZE GLAZED FACE BRICK MANUFACTURER: GLEN GARY HANLEY PLANT GLAZED COLOR: WHITE G791

GLAZED FACE BRICK VENEER - ACCENT COLOR TYPE: MODULAR SIZE GLAZED FACE BRICK MANUFACTURER: GLEN-GARY HANLEY PLANT COLOR: MINT G10-8071 OR SKYLINE G419

MANUFACTURER: HALQUIST STONE COMPANY BOARD AND BATTEN SIDING

TYPE AND PATTERN: 3/4" ROUGH-SAWN CEDAR PLYWOOD WITH 1x2 CEDAR BATTEN STRIPS AT 12" OC WITH 5/4" x 4" ROUGH-SAWN TRIM AT CORNERS. COLOR: PAINTED - REFER TO EXTERIOR ELEVATIONS FOR COLOR. EXTERIOR WOOD TRIM TYPE AND PATTERN: 5/4" ROUGH-SAWN CEDAR DIMENSIONAL RUNNING TRIM BOARDS WITH 3/4" ROUGH-SAWN CEDAR PLYWOOD REFER TO TRIM DETAILS

COLOR: PAINTED - REFER TO EXTERIOR ELEVATIONS FOR COLOR.

METAL COUNTERFLASHING AND REGLET COLOR: AS SELECTED FROM MANUFACTURER'S STANDARD COLORS. SEAMLESS GUTTER AND DOWNSPOUT GUTTER TYPE: HALF-ROUND STYLE GUTTER WITH 6" PROFILE AND HANGER SYSTEM. DOWNSPOUT TYPE: CORRUGATED ROUND. COLOR: GALVALUME.

XXX-1

WOOD SOFFIT SYSTEM TYPE AND PATTERN: EXPOSED WOOD OUTLOOKERS OR EXISTING WOOD RAFTER TAILS. COLOR: PAINTED - REFER TO EXTERIOR ELEVATIONS FOR COLOR.

DWD-X REFER TO DOOR TYPES ON SHEET A811.

WND-X WINDOWS REFER TO WINDOW SCHEDULE.

PROJECT TEAM

architecture

arcint architecture IIc

3618 west pierce street

arcint—architecture.com

milwaukee, wisconsin 53215

PROJECT NAME **HUNGER TASK FORCE GRANARY ALTERATION** & ADDITION

9000 S. 68TH STREET FRANKLIN, WISCONSIN

DRAWING ISSUE HISTORY 
 SD
 07-28-2014
 Schematic Design

 CD50
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 50% Construction Docs

 CD95
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 95% Review Documents

SET TYPE 95% REVIEW DOCUMENTS


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DATE 05-17-2014


SHEET TITLE BUILDING SECTIONS


SHEET NUMBER



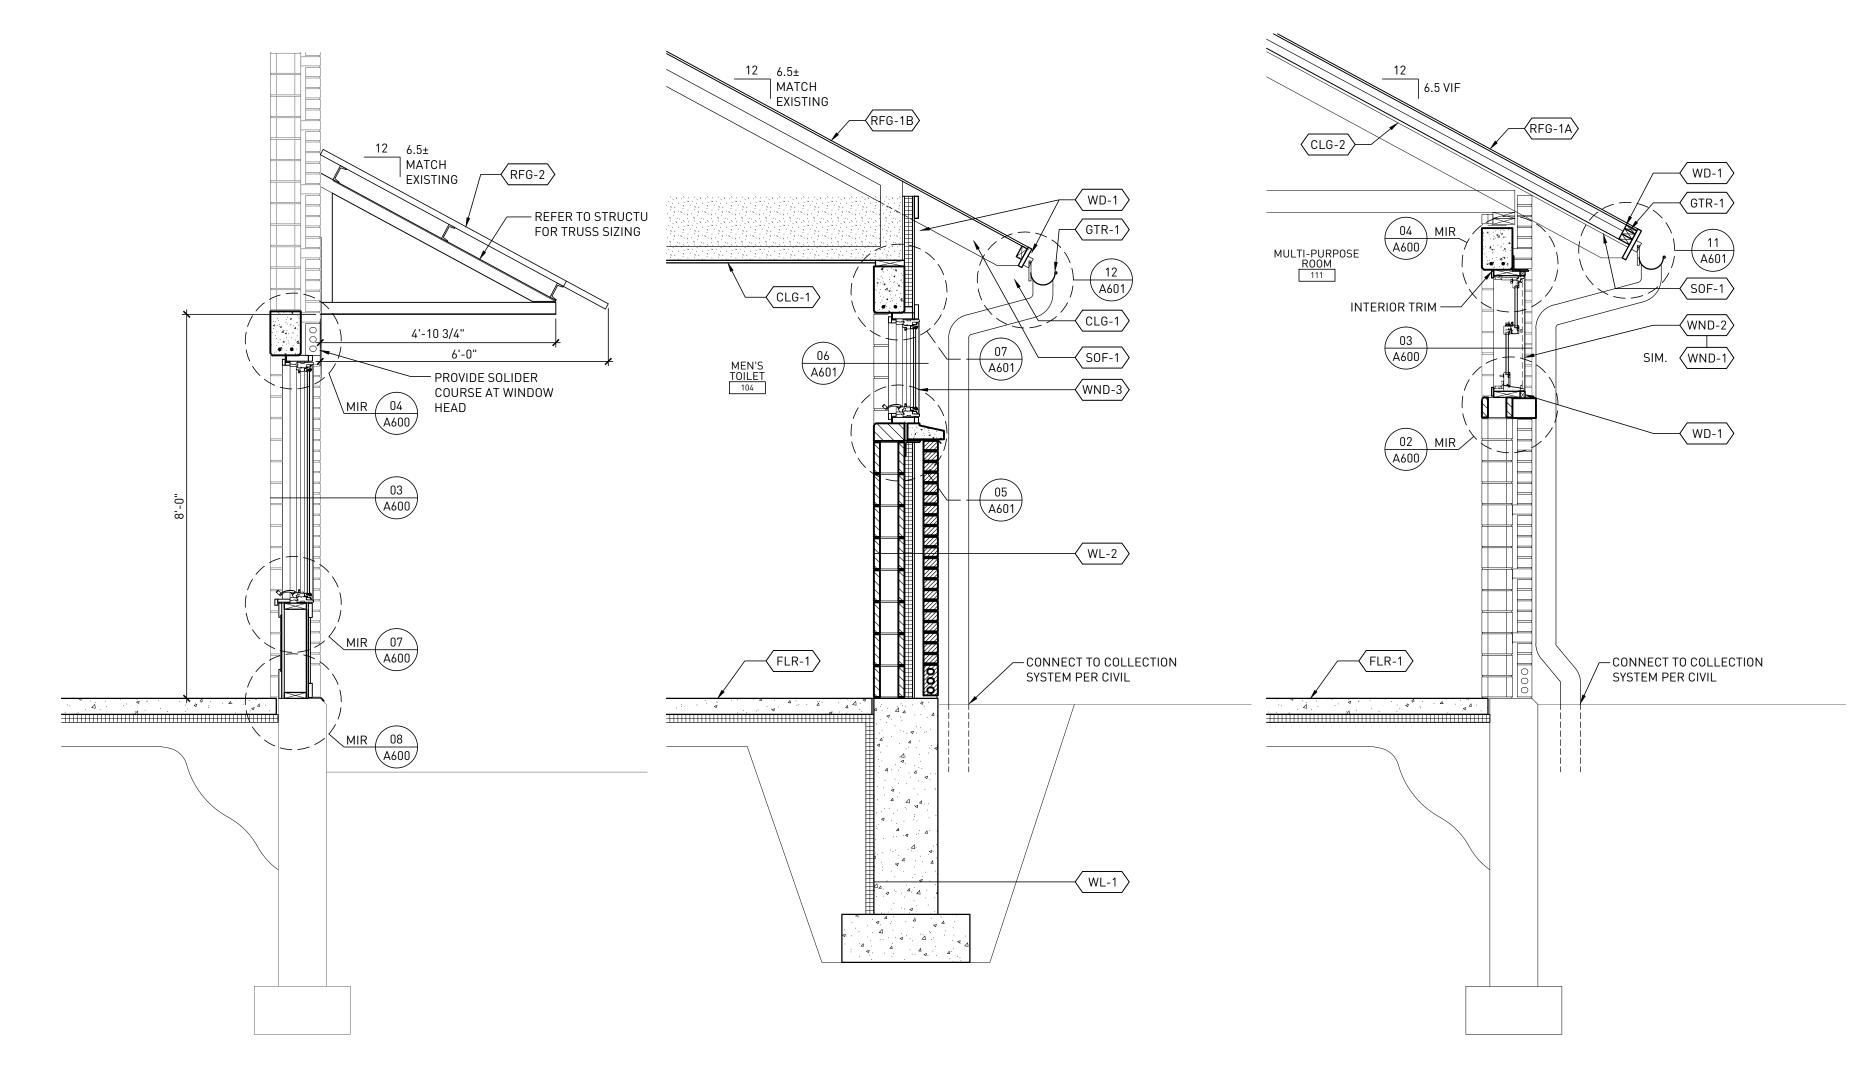

SCALE - 1/2" = 1'-0"

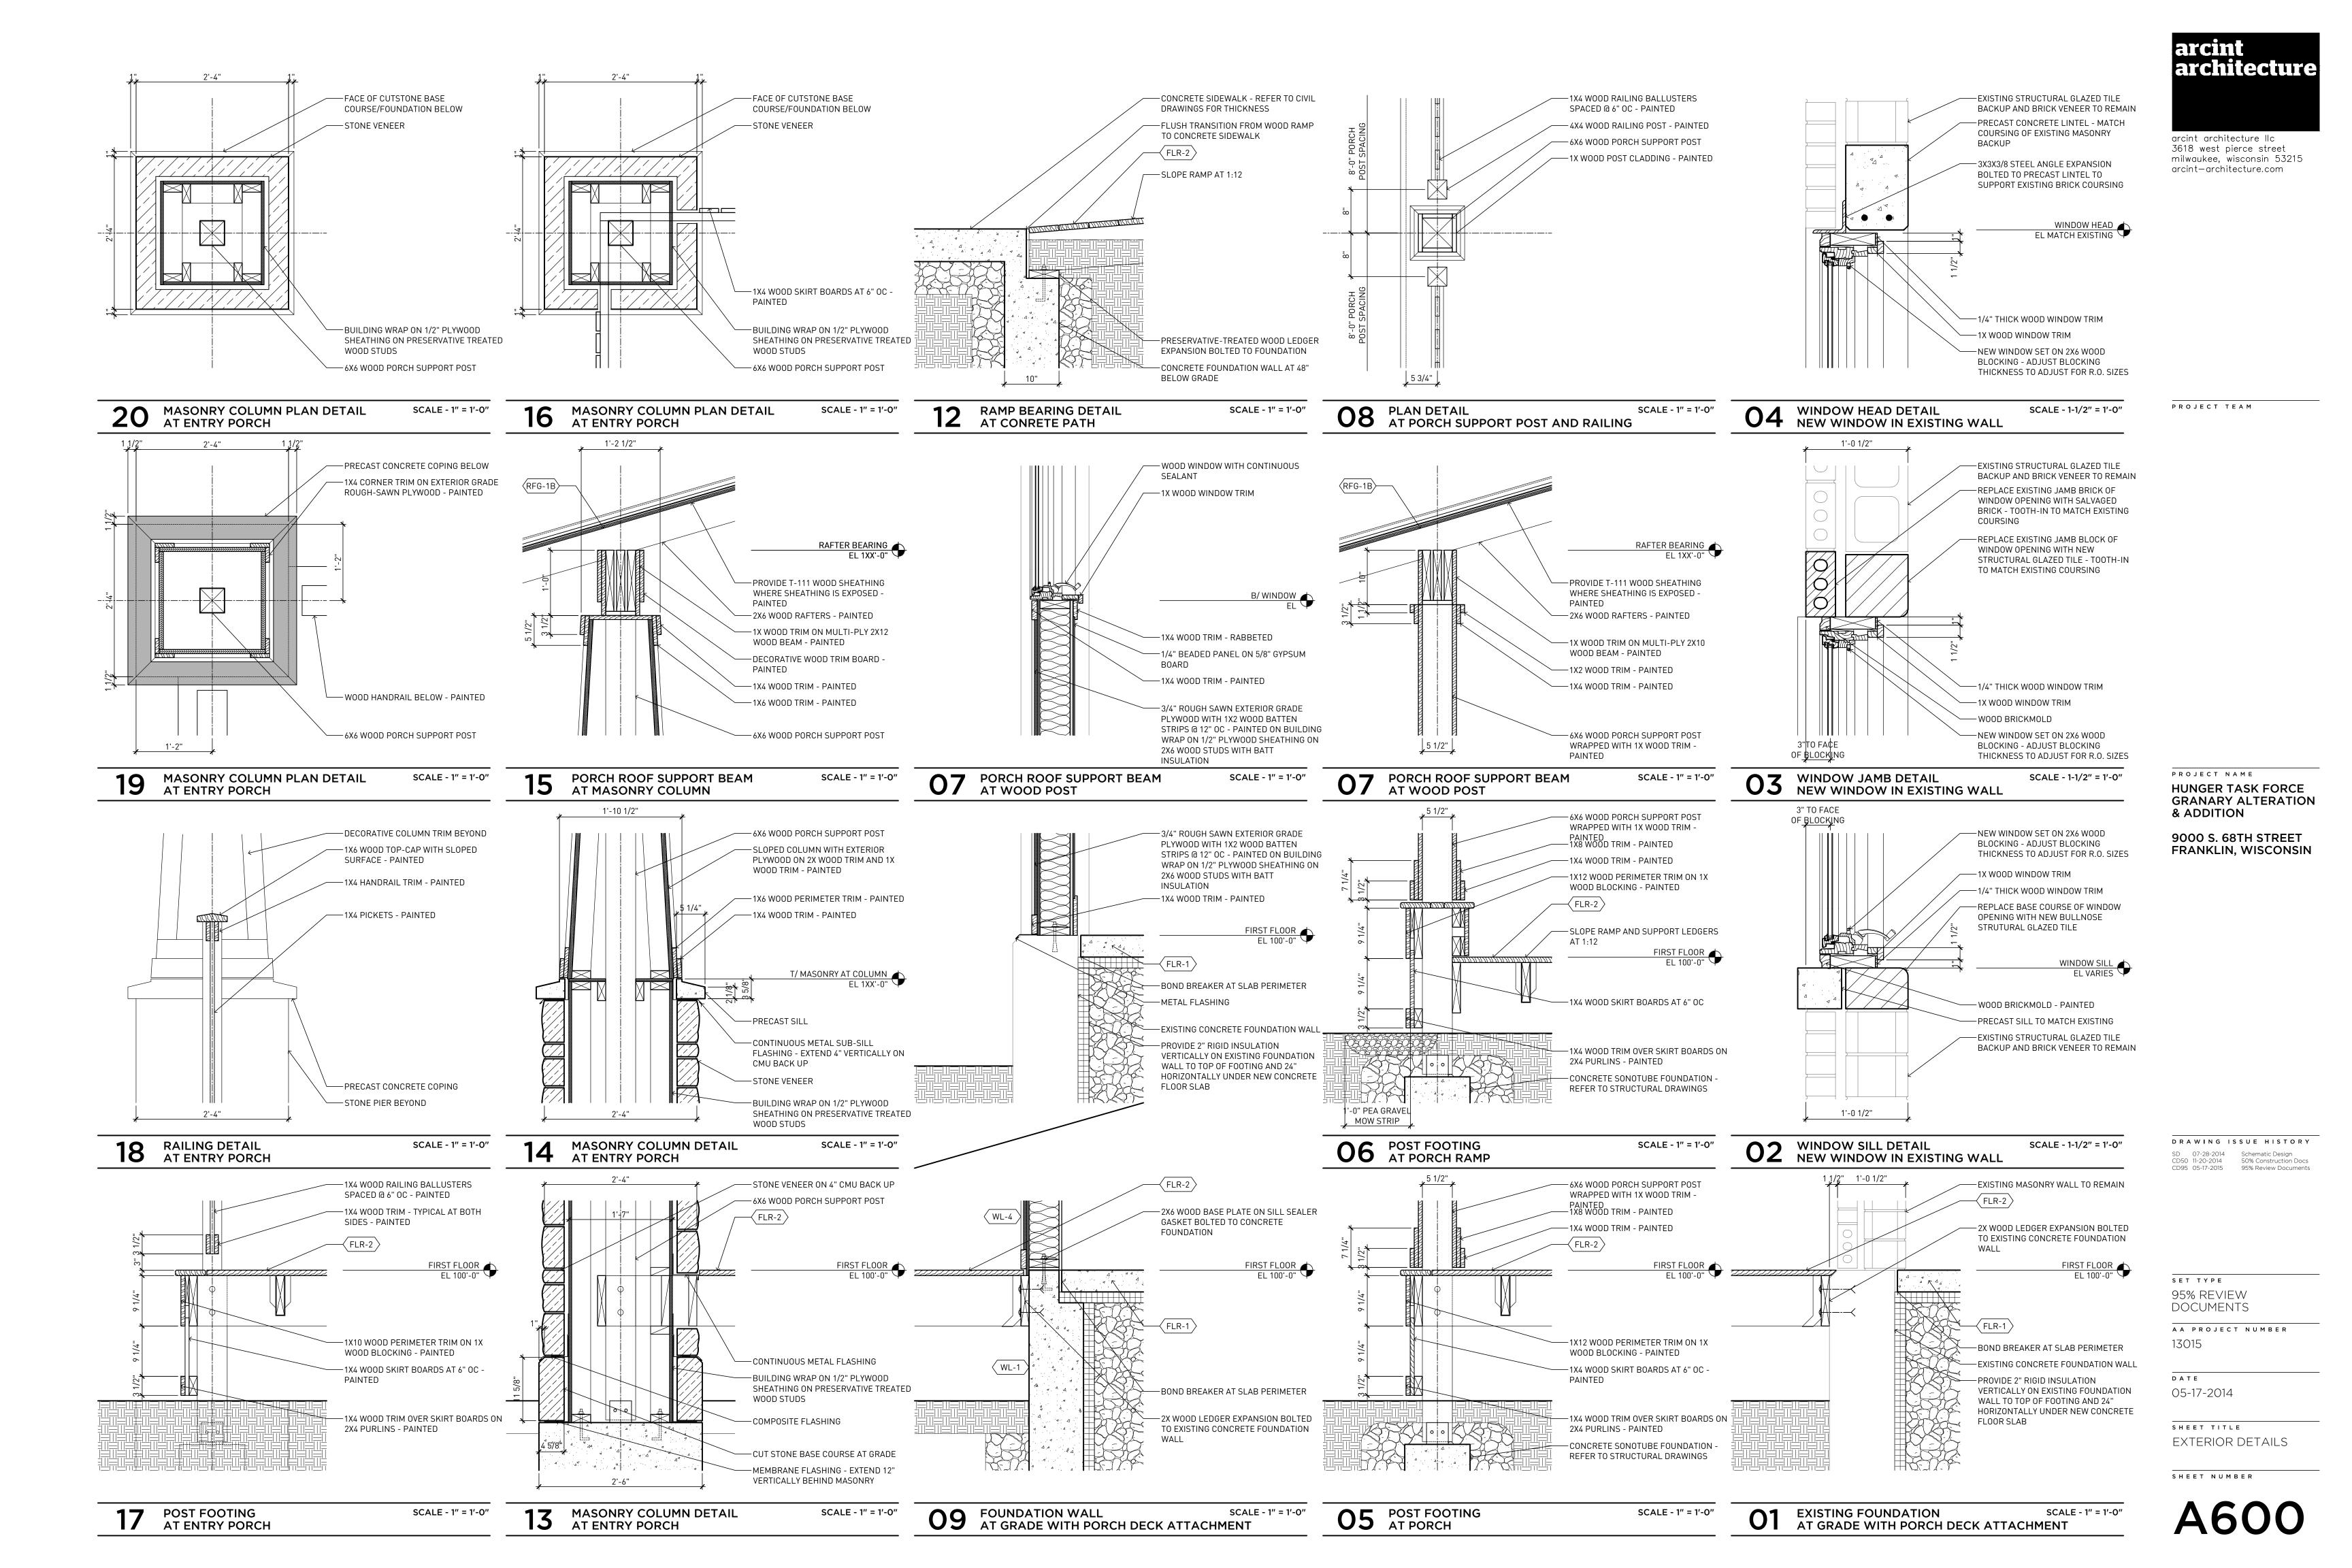

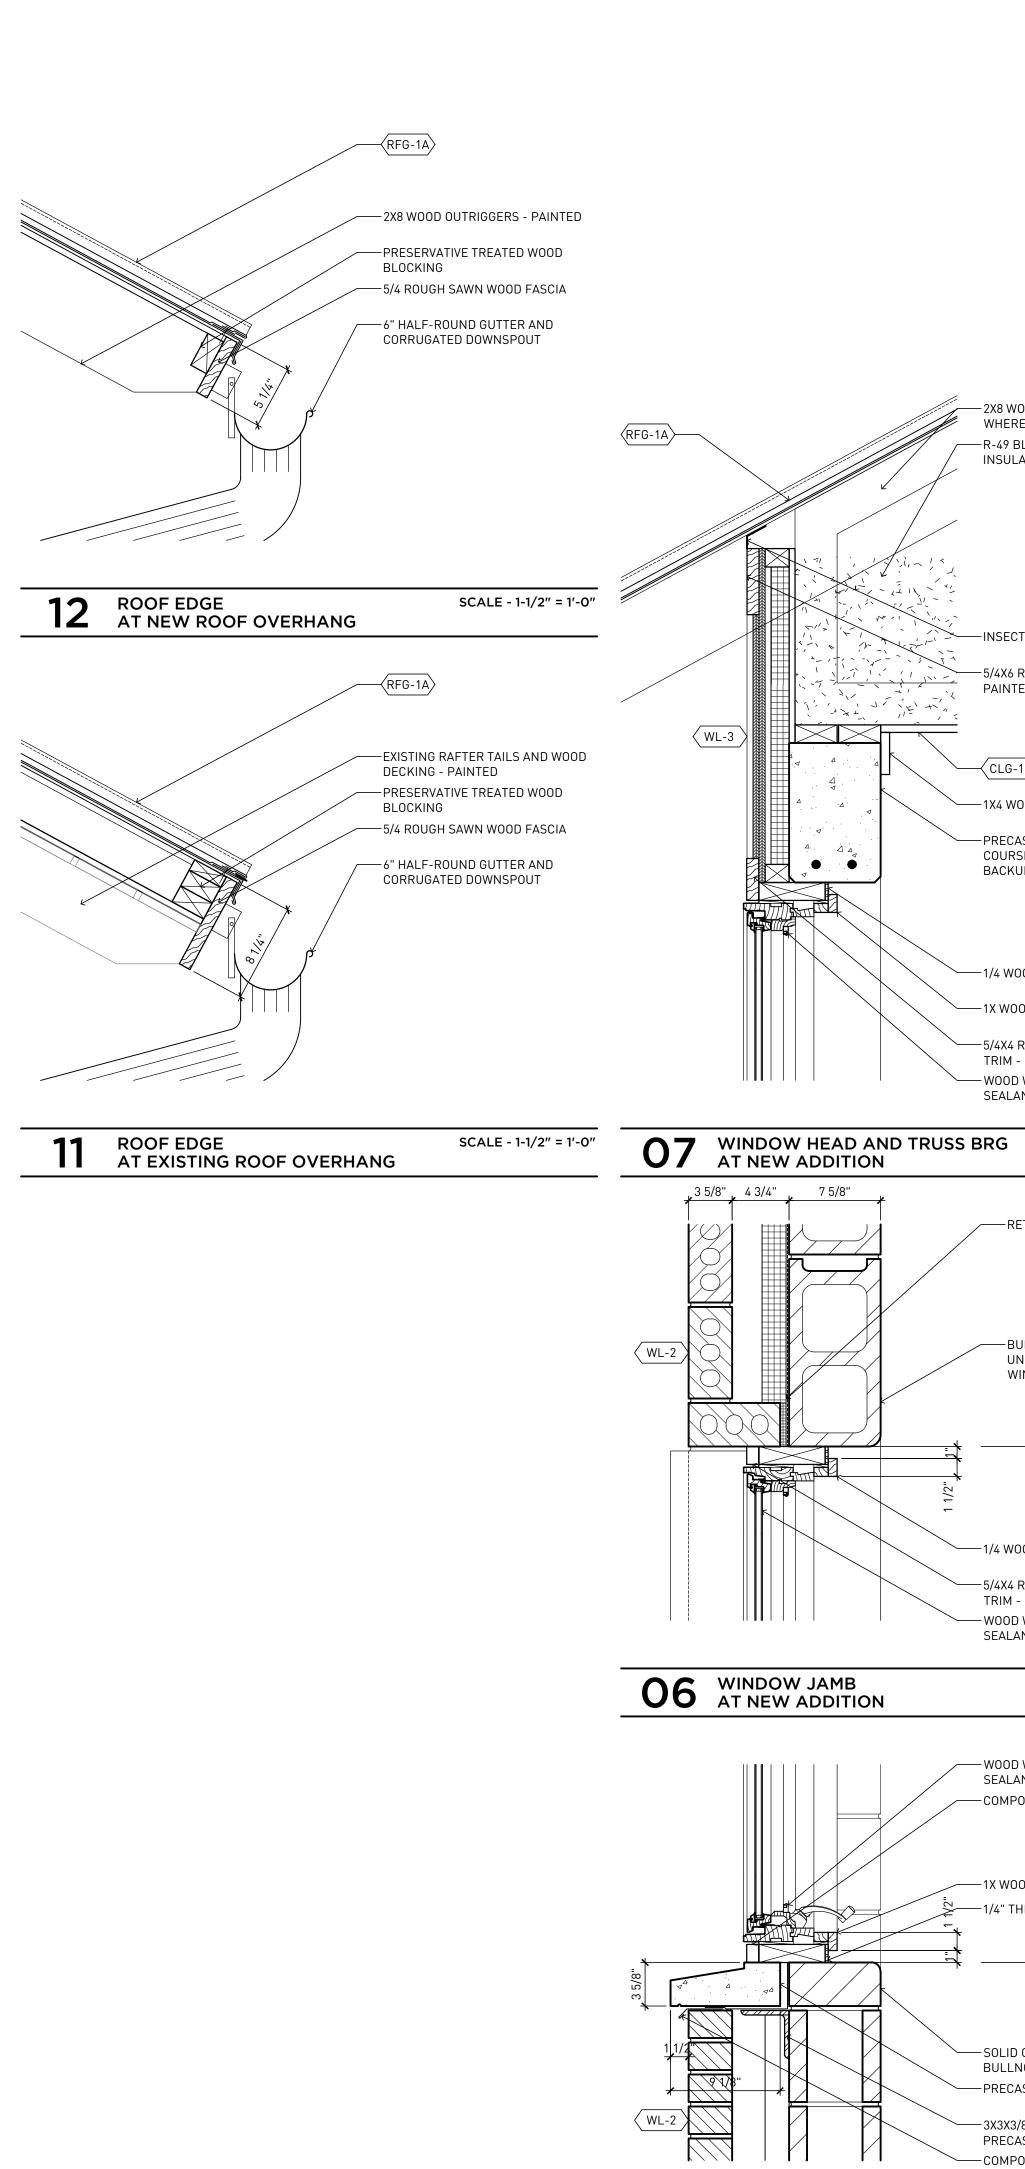



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— 1/4" THICK WOOD WINDOW TRIM —1X WOOD WINDOW TRIM -CUSTOM WOOD FRAME TYPICAL SPACED WITH 2X WOOD BLOCKING - ADJUST BLOCKING THICKNESS TO ADJUST FOR

EXISTING STRUCTURAL GLAZED TILE

PRECAST CONCRETE LINTEL - MATCH COURSING OF EXISTING MASONRY

-3X3X3/8 STEEL ANGLE EXPANSION

SUPPORT EXISTING BRICK COURSING


WINDOW SILL EL VARIES

BOLTED TO PRECAST LINTEL TO

BACKUP

R.O. SIZES

PROJECT TEAM

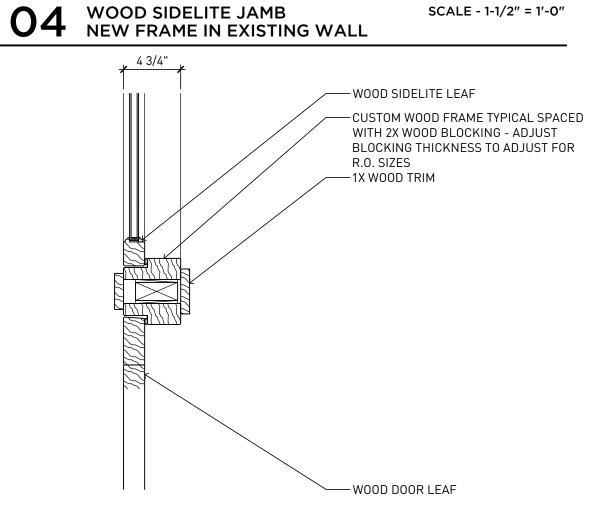

- 2X8 WOOD OUTRIGGERS - PAINTED WHERE EXPOSED TO VIEW

R-49 BLOWN-IN CELLULOSE ATTIC

INSULATION

-INSECT SCREEN

-1X4 WOOD TRIM

— 1/4 WOOD WINDOW TRIM

-1X WOOD WINDOW TRIM

TRIM - PAINTED

SEALANT

-5/4X4 ROUGH SAWN WOOD WINDOW

-WOOD WINDOW WITH CONTINUOUS

RETURN BRICK VENEER AT JAMB

-BULLNOSE CONCRETE MASONRY

WINDOW SILL EL VARIES

UNIT AT OUTSIDE CORNER OF

WINDOW JAMB

—1/4 WOOD WINDOW TRIM

TRIM - PAINTED

SEALANT

-5/4X4 ROUGH SAWN WOOD WINDOW

-WOOD WINDOW WITH CONTINUOUS

-WOOD WINDOW WITH CONTINUOUS

SEALANT AT PERIMETER -COMPOSITE WOOD TRIM

—1X WOOD WINDOW TRIM

BULLNOSE SILL

PRECAST SILL

O5 WINDOW SILL AT NEW ADDITION

PRECAST CONCRETE SILL

VERTICALLY BEHIND SILL

——1/4" THICK WOOD WINDOW TRIM

— SOLID CONCRETE BLOCK BACKUP WITH

-3X3X3/8 STEEL ANGLE TO SUPPORT

-COMPOSITE FLASHING - EXTEND 4"

SCALE - 1-1/2" = 1'-0"

SCALE - 1-1/2" = 1'-0"

WINDOW SILL EL VARIES

SCALE - 1-1/2" = 1'-0"

BACKUP


- 5/4X6 ROUGH SAWN WOOD TRIM -

PRECAST CONCRETE LINTEL - MATCH
COURSING OF EXISTING MASONRY

PAINTED

PROJECT NAME WOOD DOOR AND SIDELITE JAMB SCALE - 1-1/2" = 1'-0" NEW FRAME IN EXISTING WALL **HUNGER TASK FORCE GRANARY ALTERATION** & ADDITION

9000 S. 68TH STREET FRANKLIN, WISCONSIN

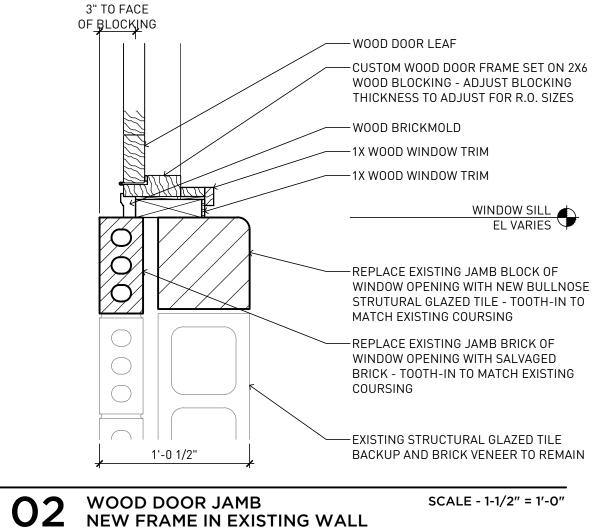

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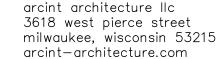
AA PROJECT NUMBER 13015

DATE 05-17-2014

SHEET TITLE EXTERIOR DETAILS

SHEET NUMBER





PROJECT TEAM

PROJECT NAME **HUNGER TASK FORCE GRANARY ALTERATION** & ADDITION

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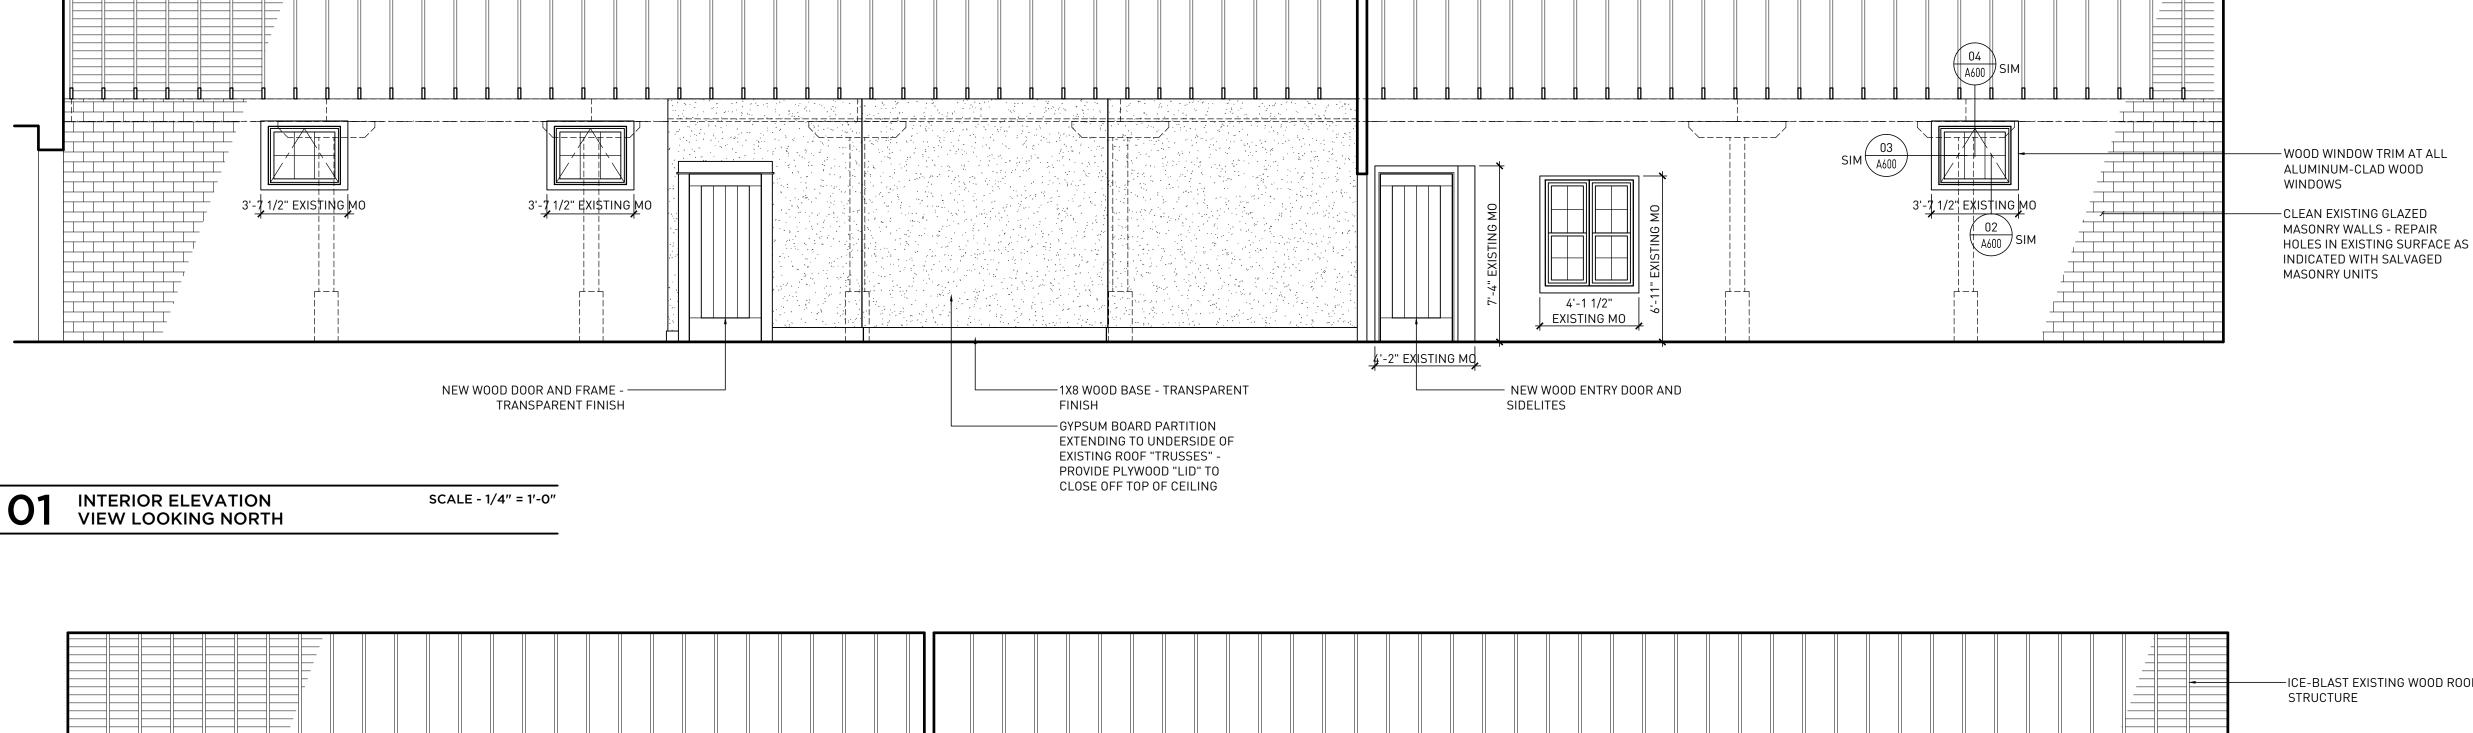
AA PROJECT NUMBER 13015


DATE 05-17-2014

SHEET TITLE INTERIOR ELEVATIONS

SHEET NUMBER







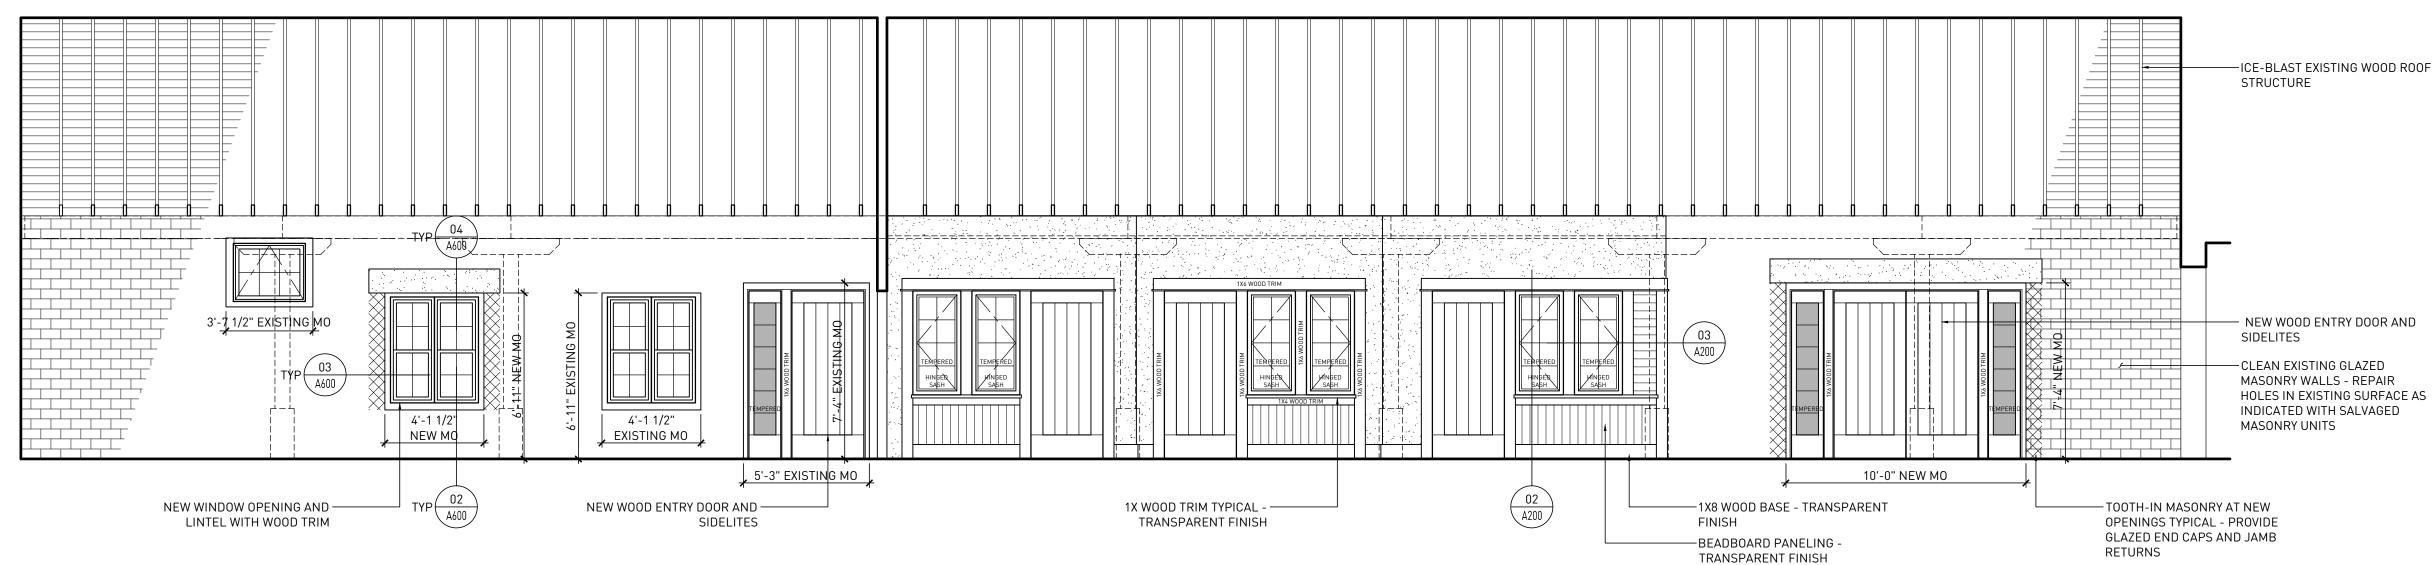


**02** INTERIOR ELEVATION VIEW LOOKING SOUTH SCALE - 1/4" = 1'-0"

03 INTERIOR ELEVATION VIEW LOOKING WEST

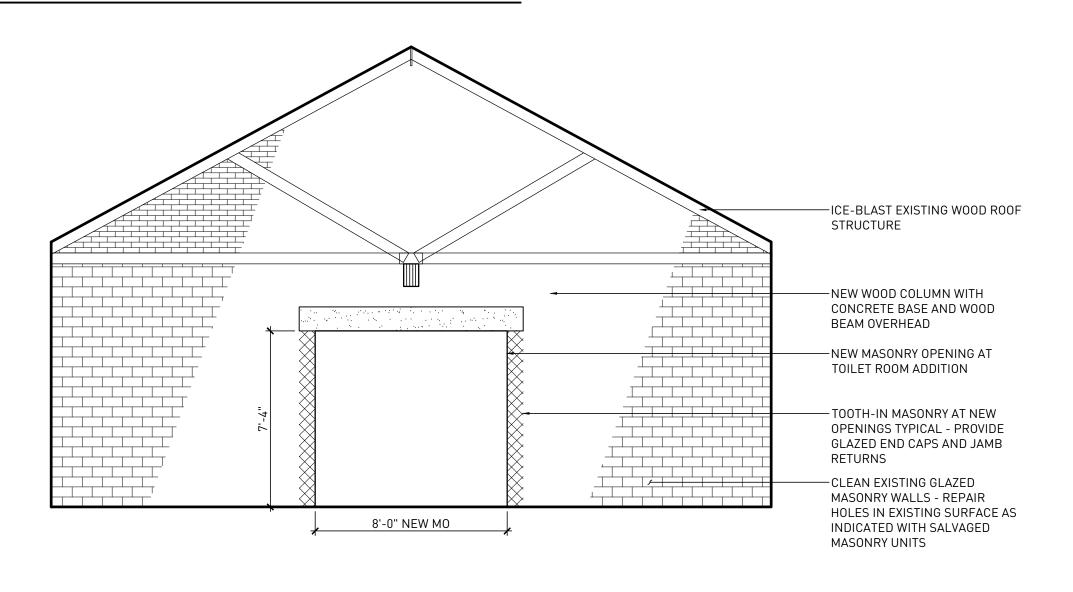

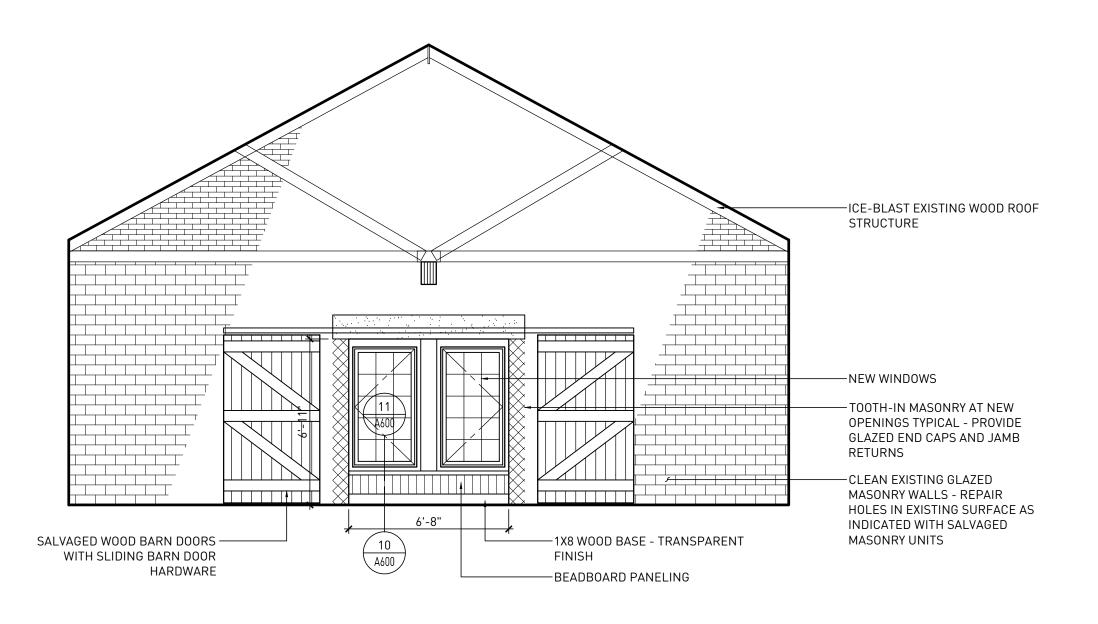


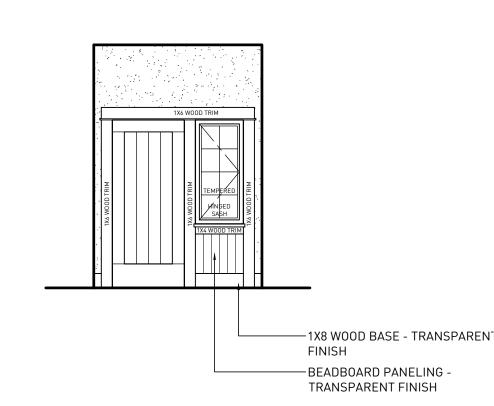

-ICE-BLAST EXISTING WOOD ROOF

STRUCTURE



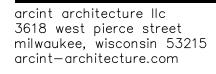




PROJECT TEAM


PROJECT NAME

& ADDITION

HUNGER TASK FORCE GRANARY ALTERATION


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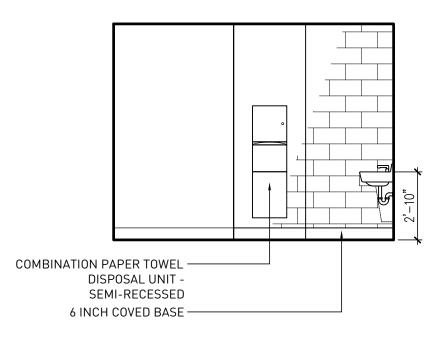


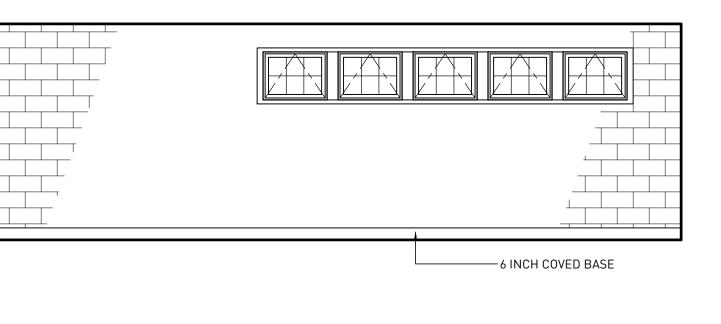

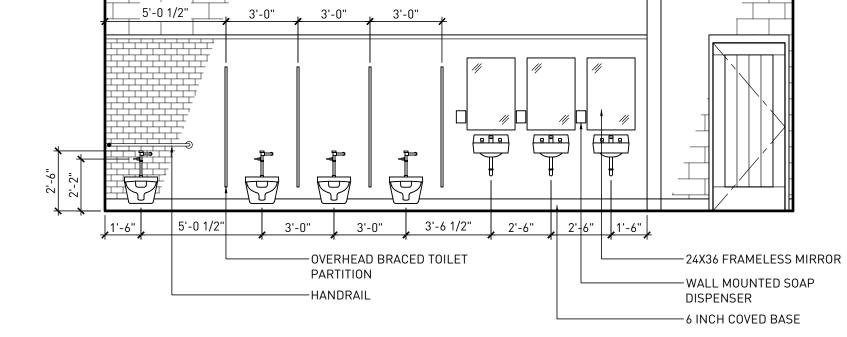INTERIOR ELEVATION WOMENS TOILET SCALE - 1/4" = 1'-0"


-6 INCH COVED BASE



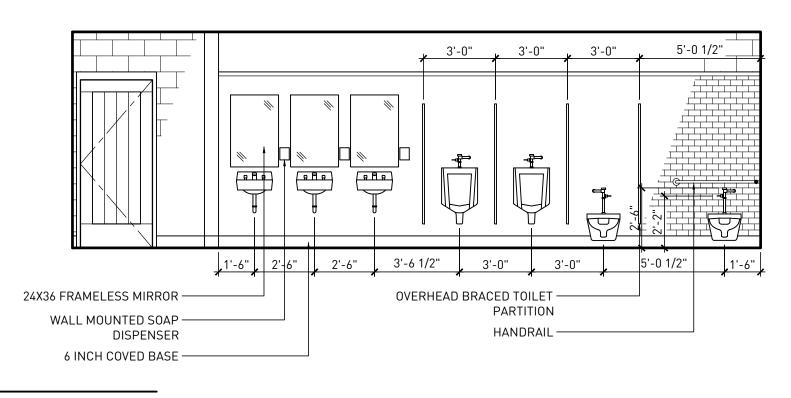

— COMBINATION PAPER TOWEL DISPOSAL UNIT -SEMI-RECESSED


-6 INCH COVED BASE

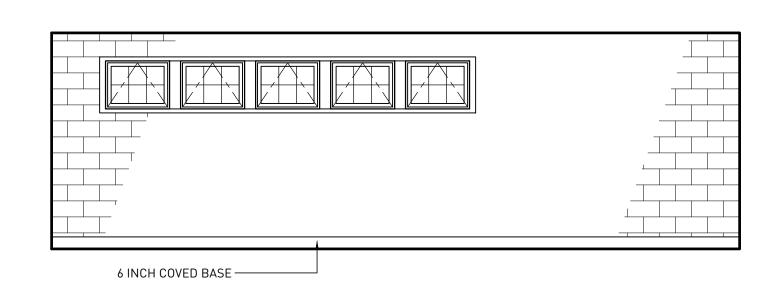



**02** INTERIOR ELEVATION MENS TOILET

6 INCH COVED BASE -

SCALE - 1/4" = 1'-0"

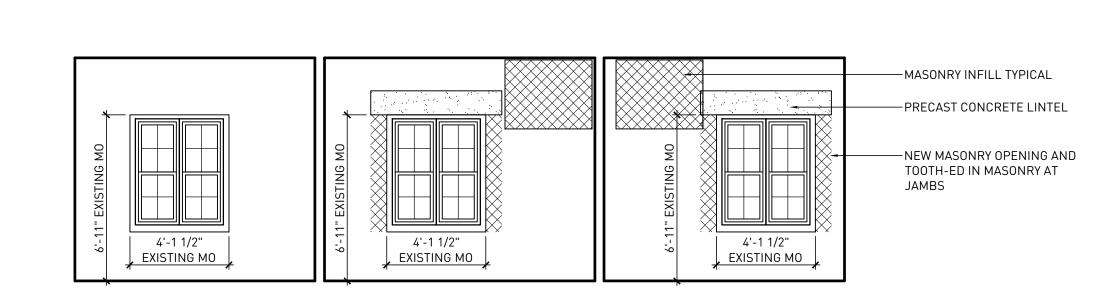

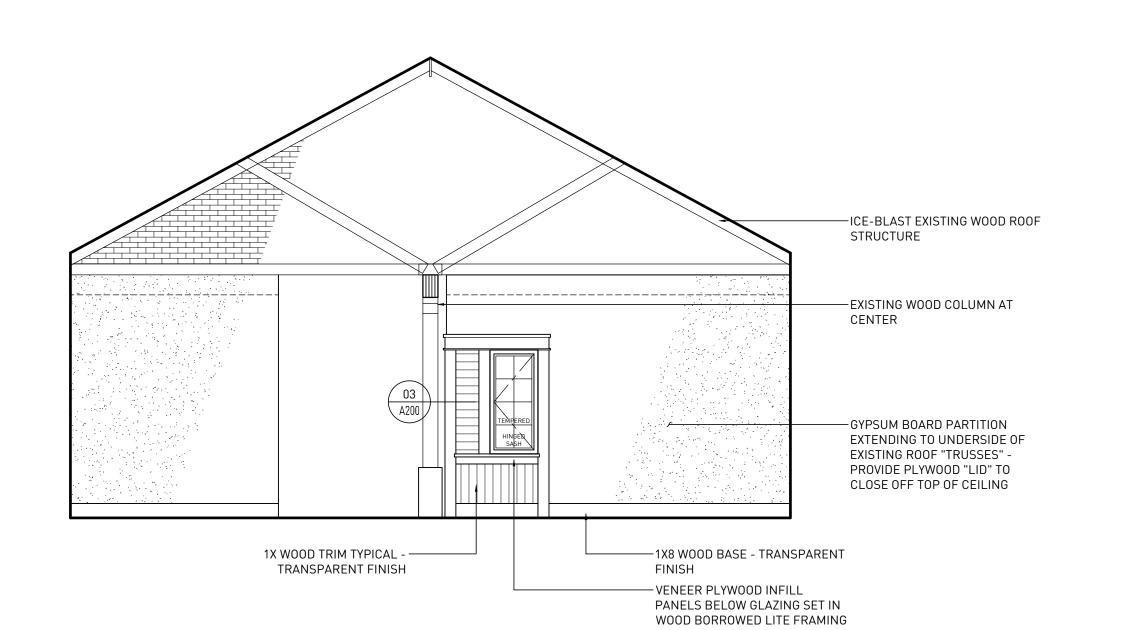

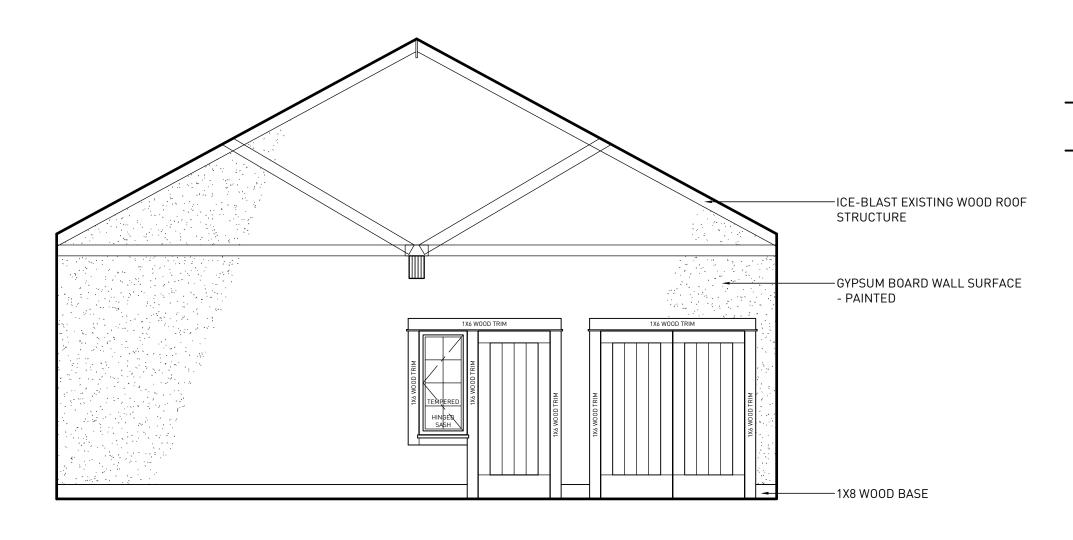

O5 INTERIOR ELEVATION ALCOVE LOOKING WEST SCALE - 1/4" = 1'-0"

> SET TYPE 95% REVIEW DOCUMENTS

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SHEET TITLE INTERIOR ELEVATIONS

SHEET NUMBER

**04** INTERIOR ELEVATION LOOKING EAST SCALE - 1/4" = 1'-0"

SCALE - 1/4" = 1'-0" O3 INTERIOR ELEVATION LOOKING EAST

	FINISH SCHEDULE																		
		FL00R		NORTH WAI	ĻL	SOUTH WAL	L	EAST WALL		WEST WALI	<u>l</u>	MILLWORK				CEILING		WINDOW	
00M	ROOM NAME	MATERIAL	BASE	MATERIAL	FINISH	MATERIAL	FINISH	MATERIAL	FINISH	MATERIAL	FINISH	BASE CAB	COUNTER	WALL CAB	TRIM	MATERIAL	FINISH	TREATMENTS	NOTES
NTRY I	LEVEL																		
100	ENTRANCE VESTIBULE	PCONC	WD	GYP	PT-2	GYP	PT-2	GYP	PT-2	GYP	PT-2	-	-		WD	CLG-1	PT-1	-	1
101	GATHERING SPACE	PCONC	WD	EX	-	EX	-	EX	-	GYP	PT-3	12-	-	-	WD	EX EXP	-	-	2,3
02	ALCOVE	PCONC	-	СМИ	PT-2	СМИ	PT-2	CT-1	-	EX	-	-	-	_	-	CLG-1	PT-1	-	
03	WOMEN'S TOILET ROOM	PCONC	=	СМИ	PT-4	CMU/CT-1	PT-4	СМИ	PT-4	СМИ	PT-4	=	_	4	-	CLG-1	PT-1	_	-
04	MEN'S TOILET ROOM	PCONC	2	CMU/CT-1	PT-4	СМИ	PT-4	CMU	PT-4	СМИ	PT-4	_	-	-	-	CLG-1	PT-1	-	-/-
05	CORRIDOR	PCONC	WD	GYP	PT-3	GYP	PT-3	2	_	GYP	PT-3	-	÷	-	WD	EXEXP	-	-	3
06	OFFICE	PCONC	WD	EX	-	GYP	PT-2	GYP	PT-2	GYP	PT-2	-	4	-	WD	CLG-2	PT-1		-
07	OFFICE	PCONC	WD	EX	_	GYP	PT-2	GYP	PT-2	GYP	PT-2	_	_	_	WD	CLG-2	PT-1	-	-
08	OFFICE	PCONC	WD	EX	-	GYP	PT-2	GYP	PT-2	GYP	PT-2	-	-	-	WD	CLG-2	PT-1	-	-
09	STORAGE	SCONC	WD	GYP	PT-2	EX	-	GYP	PT-2	GYP	PT-2	-	-	-	-	CLG-2	PT-1	-	_
10	MECHANICAL	PCONC	WD	GYP	PT-2	GYP	PT-2	GYP	PT-2	GYP	PT-2	-	-	-	_	CLG-2	PT-1	-	-
111	MULTI-PURPOSE ROOM	PCONC	WD	EX	-	EX	-	GYP	PT-2	EX	e.	-	-	÷	WD	EXEXP		-	2,3
	FINISH SCHEDULE - KEYED NOTE	S																	
	PROVIDE WOOD BASE AT GYPSUM BOARD WALLS	S ONLY - NO	WOOD BAS	E SHALL BE PR	ROVIDED AT	MASONRY WA	LLS.												
	ICE BLAST EXISTING WOOD STRUCTURE INCLUD	E WOOD TRU	JSSES AND	ASSOCIATE FF	RAMING, WO	OOD COLUMN S	TRUCTUR	ES AND UNDE	RSIDE OF W	VOOD DECK.									
ROOM	FINISH SCHEDULE – MATERIALS																		
laterial	Material Name	Product Nar	me and Nur	mber								Manufacture	r and Produc	t Rep Contac	:t				
PT-1	PAINT	SW6119, AN	NTIQUE WH	ITE - EGGSHEL	L							SHERWIN W	ILLIAMS						
T-2	PAINT	COLOR TO E	BE DETERM	IINED								SHERWIN W	/ILLIAMS						
T-3	PAINT	COLOR TO E	BE DETERM	IINED								SHERWIN W	'ILLIAMS				Ì		
T-4	PAINT	COLOR TO E	BE DETERM	IINED								SHERWIN W	ILLIAMS						
/D-1	TRANSPARENT FINISH (KNOTTY PINE)																		
T-1	CERAMIC TILE (BATHROOM BACKSPLASH)	RITTENHOU	JSE SQUAR	RE, MINT ICE, 3"	'X 6" - RUN	NING BOND PA	ATTERN					DAL TILE							
	* VERIFY ALL GROUT COLORS WITH ARCHITECT																		

FRAME

FWD-1

FWD-1

FHM-1

FHM-1

FHM-1

FHM-1

FWD-1

FWD-1

FWD-1

FWD-1

FWD-1

FWD-1

FWD-1

TYPE

MATERIAL FINISH

STN

STN

STN

STN

STN

STN

STN

STN

WD

HM

HM

HM

WD

WD

WD

WD

WD

WD

HARDWARE RATING

1,2,4

1,2,4

WIND	OW SCHEDULE												
			WINDOW UNIT		BASIS-OF-DESIGN WINDO	W SPECIFICATIONS		FINISHES				MIN PERFORM	
MARK	FUNCTION	CONFIGURATION	UNIT SIZE (WxH)	ROUGH OPENING (WxH)	MANUFACTURER/SERIES	MODEL NUMBER	TEMPERED	EXTERIOR	INTERIOR	HARDWARE	EGRESS	SHGC	U-FACTOR
WND-1	DOUBLE-HUNG	(2) MULLED	1'-9 5/8 X 4'-4 7/8"	1'-10 1/8 X 4'-4 7/8"	ANDERSON 400 SERIES	TW1842	-	DARK BRONZE	PINE/CLEAR	STONE	-	0.42	0.25
VND-2	OUTSWING AWNING	SINGLE	2'-11 15/16" X 2'-4 3/8"	3'-0 1/2" X 2'-4 7/8"	ANDERSON 400 SERIES	A31	-	DARK BRONZE	PINE/CLEAR	STONE	-	0.42	0.25
VND-3	OUTSWING AWNING	SINGLE	2'-7 1/2" X 2'-0 1/8"	2'-8" X 2'-0 5/8"	ANDERSON 400 SERIES	A281	-	DARK BRONZE	PINE/CLEAR	STONE	-	0.42	0.25
WND-4	CASEMENT	SINGLE	2'-7 1/2" X 4'-11 7/8"	2'-8" X 5'-0 3/8"	ANDERSON 400 SERIES	CX15	-	DARK BRONZE	PINE/CLEAR	STONE	-	0.42	0.25
NOTES:													
1	PROVIDE DIVIDED LIT	E GRILLES ON THE I	NTERIOR OF ALL INSULAT	ED GLASS WINDOWS.									

DRAWING	ISSUE HISTORY
SD 07-28-2014 CD50 11-20-2014 CD95 05-17-2015	Schematic Design 50% Construction Docs 95% Review Documents

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architecture

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PROJECT TEAM


PROJECT NAME

& ADDITION

HUNGER TASK FORCE GRANARY ALTERATION

9000 S. 68TH STREET FRANKLIN, WISCONSIN

1 3/4"	VARIES 13/4"	2",	VARIES	<u>,</u> 2"
7'-13/4"		7'-4"		
	WD-1 STOM WOOD FRA	ME	FHM-1 HOLLOW MET	AL DOOR

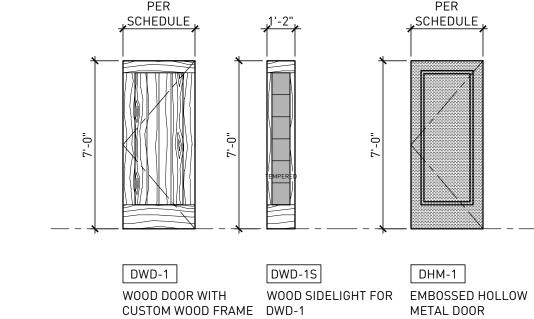

SET	TYPE	:	
	% REV		•
A A	PROJ	ЕСТ	NUMBER
130	15		
	E		
05	-17-20	14	
SHI	ET TI	TLE	
SC	HEDL	JLE:	S
-		\	

SCALE - 1/4" = 1'-0"

DOOR SCHEDULE - KEYED NOTES STAIN AS SELECTED FROM DOOR MANUFACTURER'S STANDARD STAINS. AUTOMATIC DOOR OPERATOR. SLIDING CLOSET DOOR DOOR HARDWARE. PROVIDE SIDELIGHT DWD-1S AS INDICATED ON THE ELEVATIONS.

MATERIAL FINISH GLASS

STN

DOOR SCHEDULE

DOOR ROOM ROOM NAME

STORAGE

**ENTRANCE VESTIBULE** 

**ENTRANCE VESTIBULE** 

WOMEN'S TOILET ROOM

WOMEN'S TOILET ROOM

MEN'S TOILET ROOM

MEN'S TOILET ROOM

CORRIDOR

OFFICE

OFFICE

OFFICE

111.1 111 GATHERING SPACE

STORAGE

MECHANICAL

DOOR SCHEDULE - GENERAL NOTES

**GATHERING SPACE** 

002A 002A STORAGE

002B 002B

103.1 103

104.0 104

104.1 104

105.0 105

107.0 107

109.0 109

110.0 110

111.0 111

SIZE (WXH)

(2) 3'-4" x 7'-0"

(2) 3'-4" x 7'-0"

(2) 3'-0" x 7'-0"

(2) 3'-0" x 7'-0"

REFER TO PROJECT MANUAL FOR HARDWARE GROUPS LOCATED IN SECTION 08 81 00 - DOOR HARDWARE.

(2) 3'-0" x 7'-0"

DWD-2

DWD-1

DHM-1

DWD-1

DHM-1

DWD-1

DWD-1

DWD-1

DWD-1


DWD-1

DWD-1

PROVIDE TEMPERED GLAZING IN ALL DOORS AND SURROUNDING GLASS LITES AND WHERE INDICATED ON DOOR AND FRAME ELEVATIONS.

O1 DOOR TYPES SCALE - 1/4" = 1'-0" O2 DOOR FRAME TYPES

SHEET NUMBER

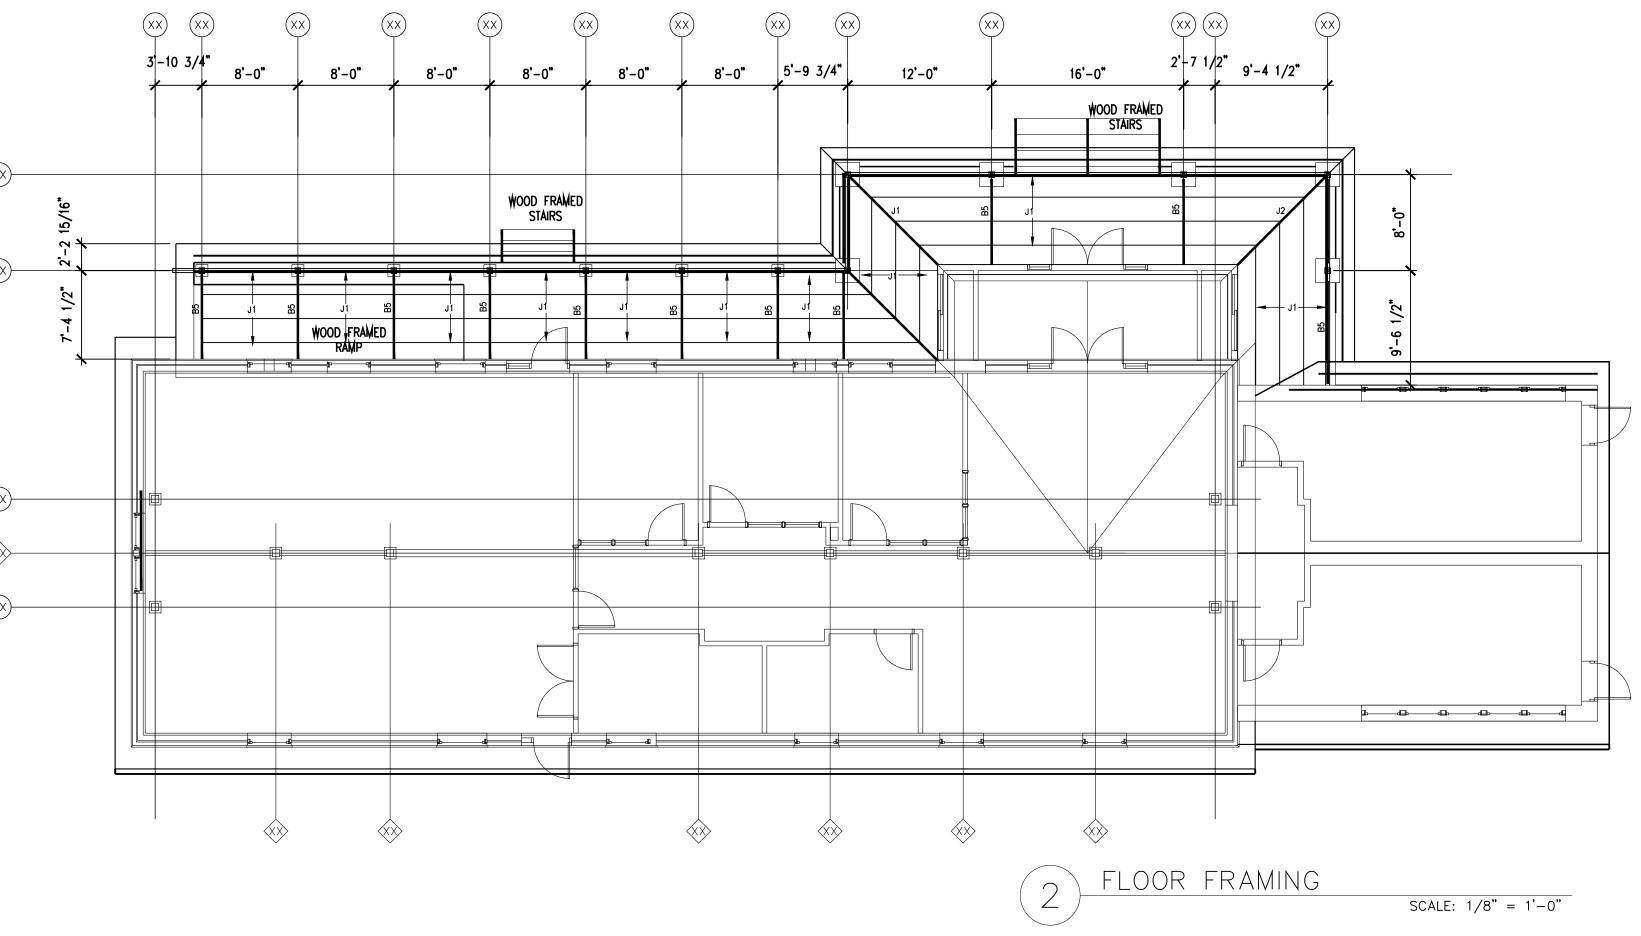

8'-0"

10'-11 1/2"

8'-0"

12'-10 1/4"

90'-4"

12'-0"

(xx)(xx)

10'-11 1/2"

10 1/2"

FOUNDATION PLAN

11'-0 1/2"

16'-4"

25'-0"

29'-10 1/2"

30'-0"

SCALE: 1/8" = 1'-0"



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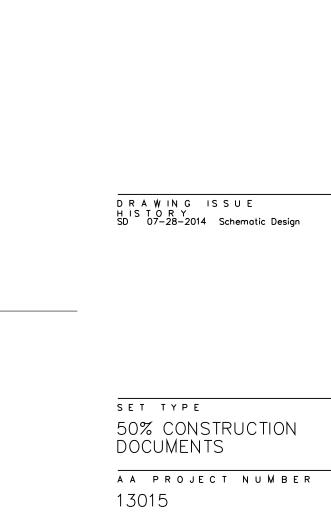
PROJECT TEAM

## **BLODGETT** Engineering, LLC

W169 N10815 Redwood Lane Germantown, WI 53022 blodgetteng@wi.rr.com ph/fax: 262-293-9923

PROJECT NAME HUNGER TASK FORCE GRANARY ALTERATION & ADDITION

SOUTH 68TH STREET FRANKLIN, WISCONSIN




DATE 08-25-2014

SHEET TITLE FOUNDATION AND FLOOR FRAMING PLAN

S100

SHEET NUMBER

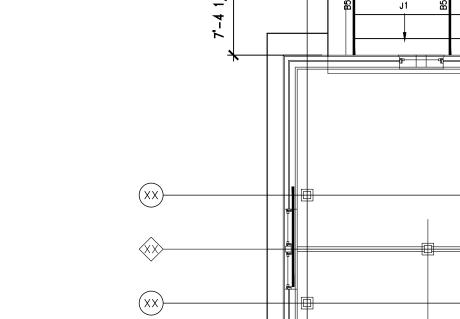

(xx) (xx)

(XX)—

(XX)——

(XX)—

8'-0"

9'-6 1/4"

8'-0"

12'-10 1/4"

8'-0"

WOOD RAFTER AND BEAM SCHEDULE

2x10 @ 24" O.C.

(2) 2x10

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NOTES:

CONNECTION

DETAIL ---

DETAIL ----

DETAIL # 6

DETAIL # 7



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LIN	TEL SCHEDULE		
NO.	SIZE	FY	CONNECTION
L1	W12x26	A992	DETAIL XXX
L2	8" BOND BEAM W/ (2) #5 BARS	GR. 60	DETAIL XXX
L3	6" x 10" W/ (1)#5 C.I.P.	4 KSI	DETAIL XXX
L4	W5x16 W/ 1/4"x11" PLATE	A992-50	DETAIL XXX

WOOI	D RAFTER AND BEAM	SCHE	DIII F
*****	NALTER AND BEAM	JOHL	. DOLL
NO.	SIZE	GRADE	CONNECTION
R1	2x6 @ 24" O.C.	DF#2	DETAIL
J1	2x10 @ 24" O.C.	DF#2	DETAIL
XX		A992	
B1	6x8 STANDARD DRESSED	DF#2	DETAIL
B2	(3) 2x10	DF#2	DETAIL
В3	6x10 STANDARD DRESSED	DF#2	DETAIL
B4	(2) 2x8	DF#2	DETAIL
	-		
		A992	DETAIL # 5
		A992	DETAIL # 1

A992

---

ROOF FRAMING PLAN

SCALE: 1/8" = 1'-0"


DETAIL # 1
DETAIL # 6

DETAIL # 7

PROJECT TEAM

## BLODGETT Engineering, LLC

W169 N10815 Redwood Lane Germantown, WI 53022 blodgetteng@wi.rr.com ph/fax: 262-293-9923

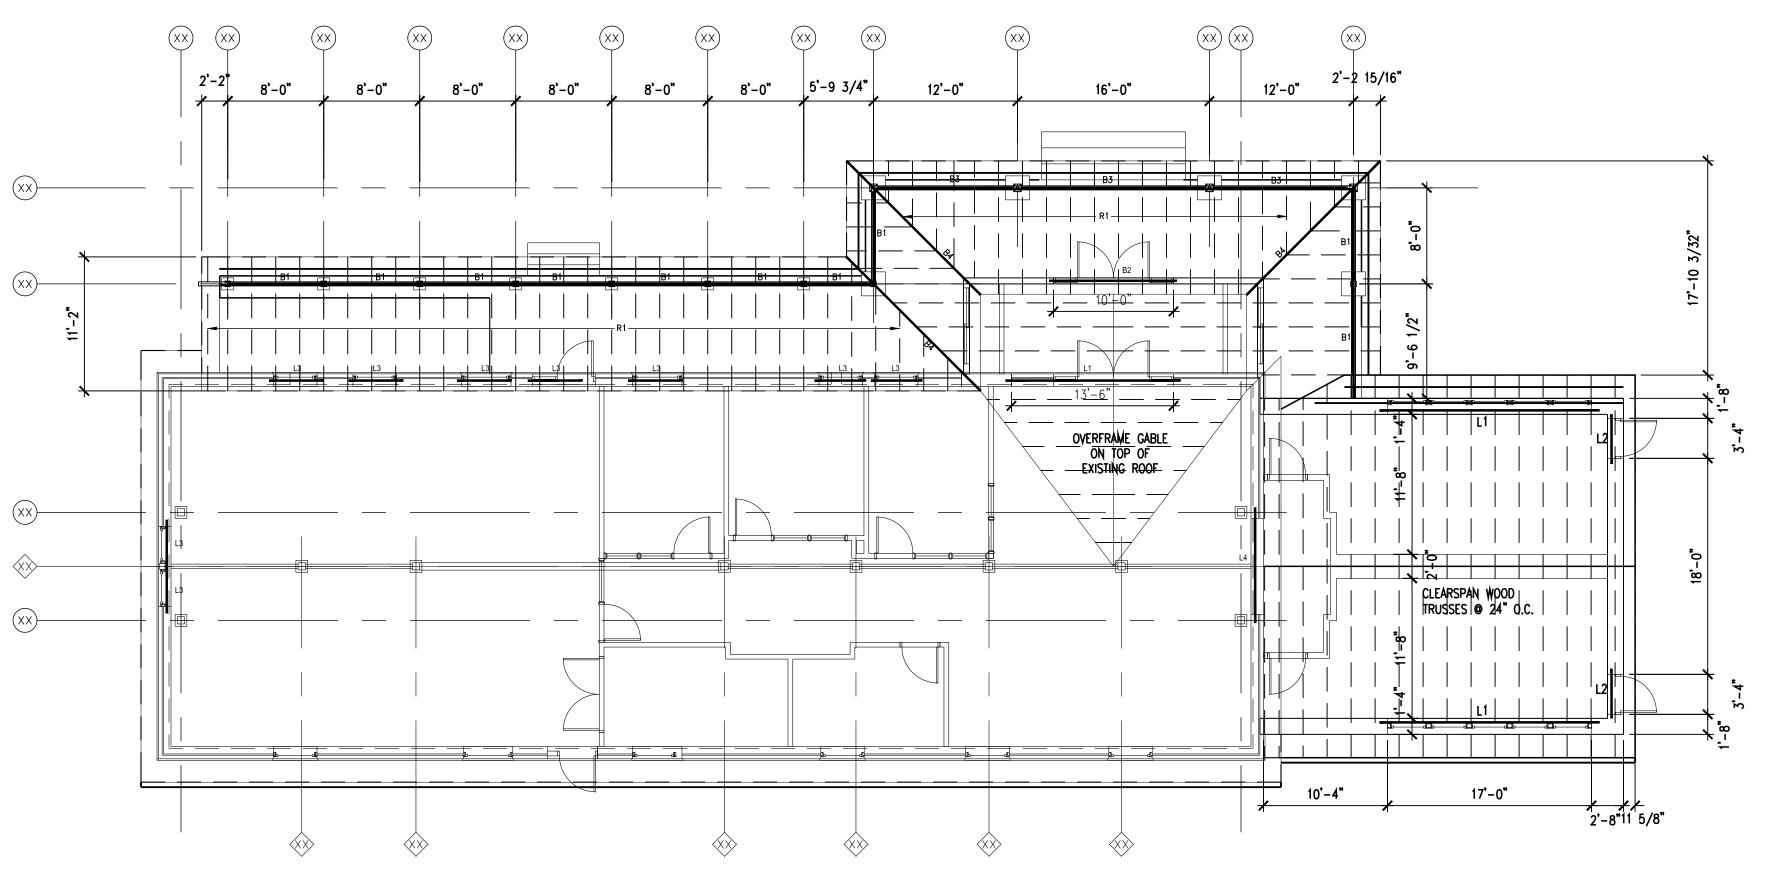

PROJECT NAME
HUNGER TASK FORCE
GRANARY ALTERATION
& ADDITION

SOUTH 68TH STREET FRANKLIN, WISCONSIN

D R A W IN G IS S U E H IS T O R Y SD 07-28-2014 Schematic Design

SET TYPE
50% CONSTRUCTION
DOCUMENTS

AA PROJECT NUMBER 13015

DATE 08-25-2014

SHEET TITLE

ROOF FRAMING
PLAN

SHEET NUMBER

S200


## **GENERAL NOTES**

- 1. COORDINATE WITH OTHER TRADES TO ELIMINATE ANY CONFLICTS BETWEEN PIPING, DUCTWORK, ELECTRICAL WORK, ETC.
- 2. FOR DETAILS, EQUIPMENT CONNECTIONS, AND PIPES SIZES NOT SHOWN ON FLOOR PLANS, REFER TO DETAILS, RISERS AND SCHEDULES.
- 3. PIPE ROUTING IS SHOWN IN APPROXIMATE LOCATIONS.
- 4. PLUMBING CONTRACTOR SHALL COORDINATE WITH MECHANICAL AND GENERAL CONTRACTORS FOR VERTICAL CHASE AND WALL REQUIREMENTS.
- 5. VERIFY ALL PLUMBING EQUIPMENT CONNECTION AND ROUGH—IN REQUIREMENTS BEFORE
- 6. FIRST FLOOR FINISHED FLOOR ELEVATION = 100.00 UNLESS DENOTED OTHERWISE.
- 7. PLUMBING CONTRACTOR SHALL PROVIDE ACCESSIBILITY TO ALL VALVES AND CONTROL DEVICES. FURNISH ACCESS PANELS WHERE SHOWN OR REQUIRED FOR ACCESS TO ALL CONCEALED VALVES OR OTHER EQUIPMENT FURNISHED UNDER THIS CONTRACT WHERE NO OTHER MEANS IS PROVIDED.
- 8. PLUMBING CONTRACTOR TO SEE ARCHITECTURAL PLANS FOR CHANGES IN CEILING HEIGHTS.
- 9. CONTRACTOR SHALL BE RESPONSIBLE FOR INSTALLATION OF ALL REQUIRED PIPING OFFSETS FOR COMPLETE PLUMBING SYSTEM INSTALLATION.
- 10. DRAWING INTENT IS TO INDICATE GENERAL ARRANGEMENT, DESIGN AND INTENT OF WORK, AND IS PARTIALLY DIAGRAMMATIC. DRAWING SHALL NOT BE SCALED.
- 11. WATER SUPPLY PIPE SIZES BASED ON CPVC TUBING. OTHER ACCEPTABLE MATERIALS MUST BE SIZED ACCORDING TO LOCAL CODE REQUIREMENTS.
- 12. SANITARY WASTE PIPING LARGER THAN 2" SHALL BE PITCHED AT 1/8" PER FOOT (MIN). SANITARY WASTE PIPING 2" AND SMALLER SHALL BE PITCHED AT 1/4" PER FOOT (MIN).

	MEC	HANICAL SYMBO	DLS
	MPRISE A STANDARD LIST; ILLE, DIFFUSER, AND PIPE	NOT ALL SYMBOLS MAY APPE SIZES ARE IN INCHES.	EAR ON THIS PROJECT.
SOIL OR WASTE ABOVE GROUND		N NITROGEN	1 2 3 4 5 6 7 8 9
SOIL OR WASTE UNDERGROUND	DI DEIONIZED WATER	NO	
VENT PIPE	SW SOFT WATER	—LPS— LOW PRESSURE STEAM (0-20 PSI)	10 11 12 13 14 15 16 17
RAIN WATER ABOVE GROUND	F FIRE LINE	—LPC— LOW PRESSURE CONDENSATE	18 19 20 21 22 23 24 25 26
RAIN WATER UNDERGROUND	FS FIRE SPRINKLER	MPS MEDIUM PRESSURE STEAM (21-74 PSI)	1. SIDE CONNECTION 14. EXP. JOINT W/ PIPE GUIDE 2. ELBOW DOWN 15. REDUCER
— <del>D</del> SUBDRAIN	——CA——— COMPRESSED AIR	MPC MEDIUM PRESSURE CONDENSATE	3. ELBOW UP 16. STRAINER 4. SHUT-OFF VALVE 17. UNION 5. BALANCING VALVE 18. DIRECTION OF FLOW
——D—— DRAIN	——CS———CONDENSER WATER SUPPLY	—HPS— HIGH PRESSURE STEAM (75+ PSI)	6. CONTROL VALVE 19. STEAM TRAP 7. PRESSURE REDUCING VALVE 20. PITCH PIPE DOWN
——CW—— COLD WATER	CR	—HPC— HIGH PRESSURE CONDENSATE	8. PRESSURE RELIEF VALVE 21. VALVE IN VERTICAL PIPE 9. CHECK VALVE 22. 3—WAY CONTROL VALVE
HW HOT WATER	—CHWS— CHILLED WATER SUPPLY		10. AIR VENT23. CIRCUIT SETTER11. PRESSURE GAUGE24. BALL VALVE12. THERMOMETER25. BUTTERFLY VALVE
RHW	—CHWR— CHILLED WATER RETURN	—FOF— FUEL OIL FILL	13. PIPE ANCHOR 26. TRIPLE DUTY VALVE
—HW180— 180° WATER (OR TEMP. INDICATED)	RL REFRIGERANT LIQUID	—FOS— FUEL OIL SUPPLY	NUMBER OF SECTION  M5  NUMBER OF SHEET WHERE SECTION APPEARS
ARV ACID RESISTANT VENT	RS REFRIGERANT SUCTION	—FOR— FUEL OIL RETURN	2 - NUMBER OF DETAIL
——ARW—— ACID RESISTANT WASTE	—HWS— HOT WATER HEATING SUPPLY	FOV FUEL OIL VENT	M3 - NUMBER OF SHEET WHERE DETAIL APPEARS
O OXYGEN	—HWR— HOT WATER HEATING RETURN	—FOG— FUEL OIL GAUGE	RTU - EQUIPMENT TYPE  3 - UNIT NUMBER (SEE EQUIPMENT SCHEDULES)
⊕ <u>FD</u> FLOOR DRAIN	S SENSOR →	FIRE DEPT CONNECTION	THERMOSTAT <u>LINETYPES</u>
(O) <u>RD</u> ROOF DRAIN	CO CLEAN OUT	PENDANT TYPE SPRINKLER HEAD W/ CEILING PLATE	CONNECT NEW TO EXISTING ————— EXISTING —————— DEMO
<u>DS</u> DOWN SPOUT	-O- CLEAN OUT O	UPRIGHT SPRINKLER HEAD	AIR FLOW ON NEGATIVE SIDE
→ HB HOSE BIB	S.P. STAND PIPE S	SMOKE DETECTOR →	AIR FLOW ON SUPPLY SIDE

A/C	AIR CONDITIONER	EC	ELECTRICAL CONTRACTOR	ID	INSIDE DIAMETER	S	SINK
Α̈́/E	ARCHITECT/ENGINEER	ELEC	ELECTRICAL	ID IE	INVERT ELEVATION	SA	SUPPLY AIR
ÁHU	AIR HANDLING UNIT	EL	ELEVATION	INSUL		SAN	SANITARY
ALT	ALTERNATE	EQUIP	EQUIPMENT	IPS	IRON PIPE SIZE	SCH	SCHEDULE
AP	ACCESS PANEL	EWC	ELECTRIC WATER COOLER			SECT	SECTION
APPROX.	APPROXIMATELY	EXH	EXHAUST	JAN	JANITOR	SH	SHOWER
ARCH	AIR CONDITIONER ARCHITECT/ENGINEER AIR HANDLING UNIT ALTERNATE ACCESS PANEL APPROXIMATELY ARCHITECTURAL/ARCHITECT	EXIST	EXISTING			SP	STATIC PRESSURE
			EXPANSION	LAV	LAVATORY	SPEC	SPECIFICATION
BDD	BACK DRAFT DAMPER	EXT	EXTERIOR			SS	STAINLESS STEEL
BTU	BRITISH THERMAL UNIT			MB	MOP BASIN THOUSAND BTUS PER HOUR MECHANICAL CONTRACTOR MECHANICAL MEDIUM	STD	STANDARD
BTUH	B.T.U. PER HOUR	F&T	FLOAT & THERMOSTATIC	MBH	THOUSAND BTUs PER HOUR	STM	STEAM
		FC0	FLOOR CLEANOUT	MC	MECHANICAL CONTRACTOR	STRUC	STRUCTURAL
Q.	CENTER LINE	FD	FLOOR DRAIN	MECH	MECHANICAL	SUSP	SUSPEND
CAB	CABINET	FE	FIRE EXTINGUISHER	MED	MILDION	SW	SWITCH
CAP	CAPACITY	FH	FIRE HYDRANT	MH	MAN HOLE		
CFM	CUBIC FEET PER MINUTE	FL	FLOAT & THERMOSTATIC FLOOR CLEANOUT FLOOR DRAIN FIRE EXTINGUISHER FIRE HYDRANT FLOOR	MOD	MOTOR OPERATED DAMPER	T-STAT	THERMOSTAT
CI	CAST IRON	FLEX	FLEXIBLE	MTD	MOUNTED	TEMP	
CIRC	CIRCULATOR	FOF	FUEL OIL FILL			THERM	
CLG	COOLING	FOG	FUEL OIL GAUGE	NAT	NATURAL	THRU	THROUGH
CM	CONSTRUCTION MANAGER	FOR	FUEL OIL RETURN			TLT	TOILET
CO	CLEAN OUT	FOS	FUEL OIL SUPPLY	OC	ON CENTER	TYP	TYPICAL
COMB	COMBINATION	FOV	FUEL OIL KETURN FUEL OIL SUPPLY FUEL OIL VENT FEET PER MINUTE	OD	OUTSIDE DIAMETER		
COMP	COMPRESSOR	FPM	FEET PER MINUTE	OPG	OPENING	UL	UNDERWRITERS LAB.
CONC	CONCRETE	FPS	FEET PER SECOND			UR	URINAL
COND	COOLING CONSTRUCTION MANAGER CLEAN OUT COMBINATION COMPRESSOR CONCRETE CONDENSATE, CONDENSOR	FT	FEET	PLBG	PLUMBING		
COMIN	CONNECTION			PSIA	POUNDS PER SQ. INCH ABSOLUTE	٧	VENT
CONT	CONTINUOUS	GA	GAUGE	PSIG	POUNDS PER SQ. INCH GAUGE	VAC	VACUUM
CONTR	CONTRACTOR	GALV	GALVANIZE		PREFABRICATED	VCP	VITRIFIED CLAY PIPE
CONV	CONVECTOR	GC	GENERAL CONTRACTOR	PRV	PRESSURE REDUCING VALVE		VERTICAL
CUH	CABINET UNIT HEATER	GEN	GENERAL	D.1	DETURN AIR	VOL	VOLUME
00	DDV DUI D TEMP	GPH	GALLONS PER HOUR	RA	RETURN AIR	VTR	VENT THRU ROOF
DB	DRY BULB TEMP.	GPM	GALLONS PER MINUTE	RAD	RADIATOR	147	WACTE
DF	DRINKING FOUNTAIN	HD	LIACE DID	RD REC	ROOF DRAIN	W w/	WASTE
DIA	DIAMETER	HB	HOSE BIB	REC	RECESSED	W/	WITH
DIFF	DIFFUSER	HD	HEAD	REF	REFRIGERANT	W/O	WITHOUT
DIM	DIMENSION	HOR	HORIZONTAL	REL	RELIEF	WB	WET BULB TEMP.
DISCH	DISCHARGE	HP	HORSEPOWER	REQ	REQUIRED	WC	WATER CLOSET
DN	DOWN	HTG	HEATING	RET	RETURN	WCO	WALL CLEANOUT
DPR	DAMPER DOWN SPOUT	HTR	HEATER	REV	REVISION DED MINISTE	WH	WATER HEATER
DS	DOWN SPOUT			RPM	REVOLUTIONS PER MINUTE		
DX	DIRECT EXPANSION						

	PLUMBING FIXTURE SCHEDULE												
Tag	Description	Manufacturer	Fixture	Flush Val	ve/Faucet	Dro	ain	Water Su	pply sizes	Sanitary size	Shut-off Valves	Remarks	
			Model Number	Manufacturer	Model Number	Manufacturer	Model Number	Hot (in)	Cold (in)	(in)	(Y,N or N/A)		
HD-1	Hub Drain	Fabricated by PC	-	_	-	_	_	-	-	3	N/A		
FCO-1	Floor Cleanout	Sioux Chief	834-4PNQ	-	-	-	-	-	-	See Plans	N/A	2,000 lb Load Rating	
FD-1	Floor Drain	Sioux Chief	832-25PNR	-	_	-	-	_	_	3	N/A	2,000 lb Load Rating	
HB-1	Hose Bibb			-	-	-	-	_	_				
L-1	Lavatory	Kohler	K-2210	Sloan Solis	EAF-275-ISM	-	_	1/2	1/2	1-1/2	Y		
S-1	Single Bowl Sink	Elkay	LR2521	Moen	Arbor 7594	-	_	1/2	1/2	1-1/2	Y		
UR-1	Urinal	Kohler	Bardon K-4904-ET	Plus	8180-1.0	-	_	_	3/4	2	Y	ADA Compliant	
WC-1	Water Closet	Kohler	K-4321	Sloan ECOS	8111-1.6/1.1	-	-	_	1-1/2	3	Υ	ADA Compliant, 5	

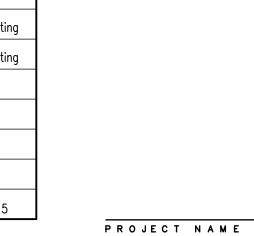

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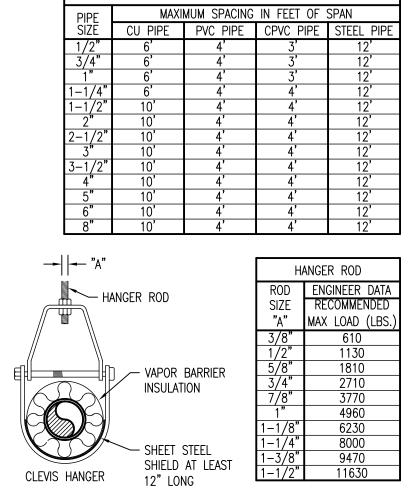
PROJECT TEAM

ENGINEERING CONSULTANT


milwaukee, wisconsin 53215


GRANARY ALTERATION & ADDITION SOUTH 68TH STREET FRANKLIN, WISCONSIN


HUNGER TASK FORCE




PIPE HANGER SPACING

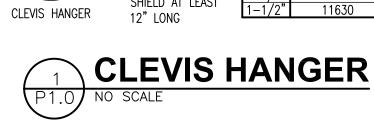


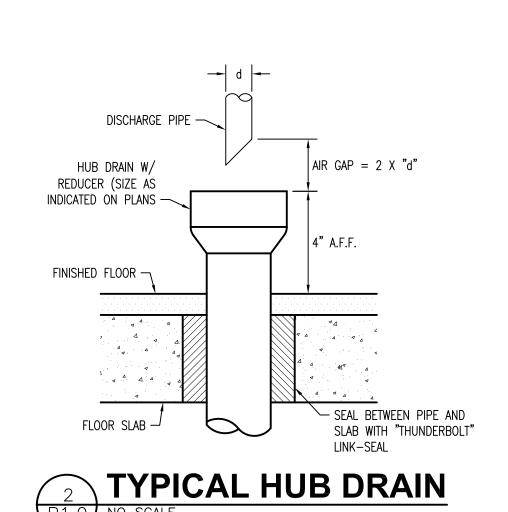

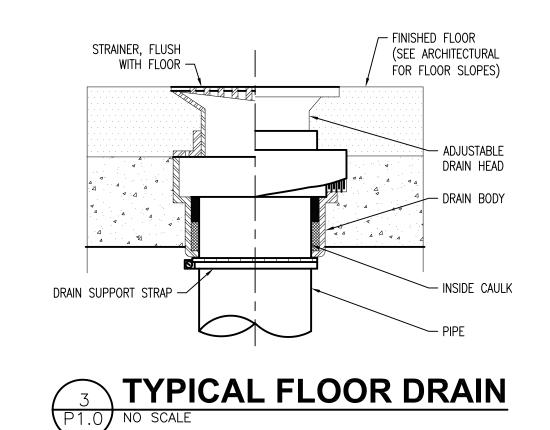

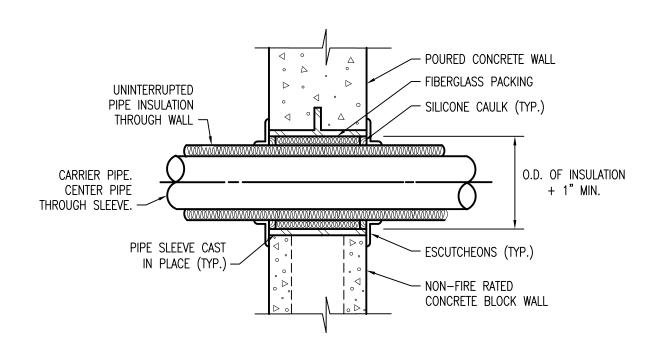




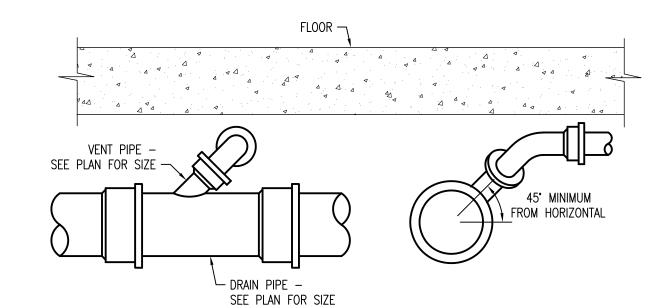



**DRAWING LIST** P1.0 SYMBOLS, ABBREVIATIONS, SCHEDULES & DETAILS P1.1 SUPPLY PIPING, WASTE AND VENT PLANS P1.2 PLUMBING ISOMETRICS

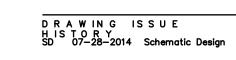


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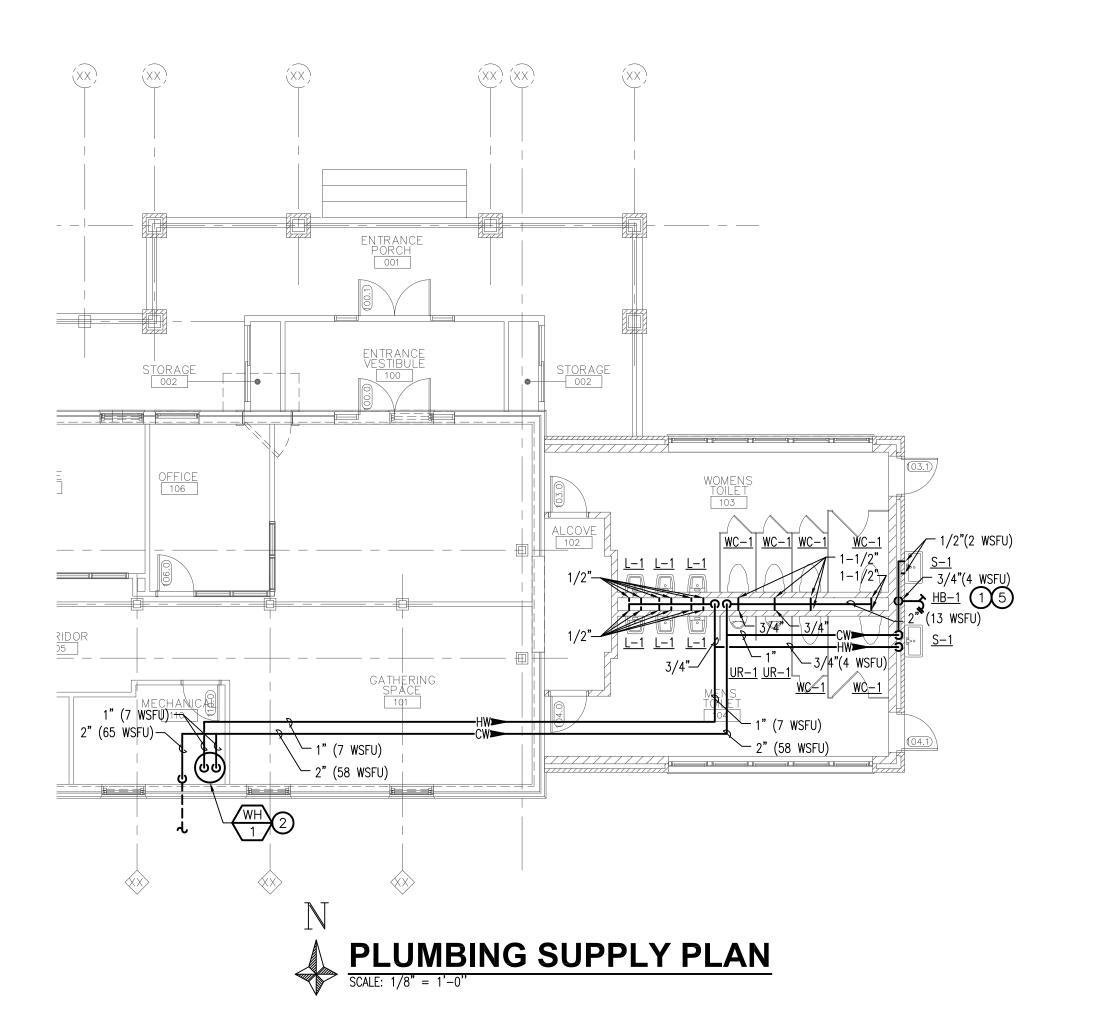
AA PROJECT NUMBER 13015

DATE 08-25-2014

SYMBOLS, ABBREVIATIONS, SCHEDULES & DETAILS SHEET NUMBER

P1.0



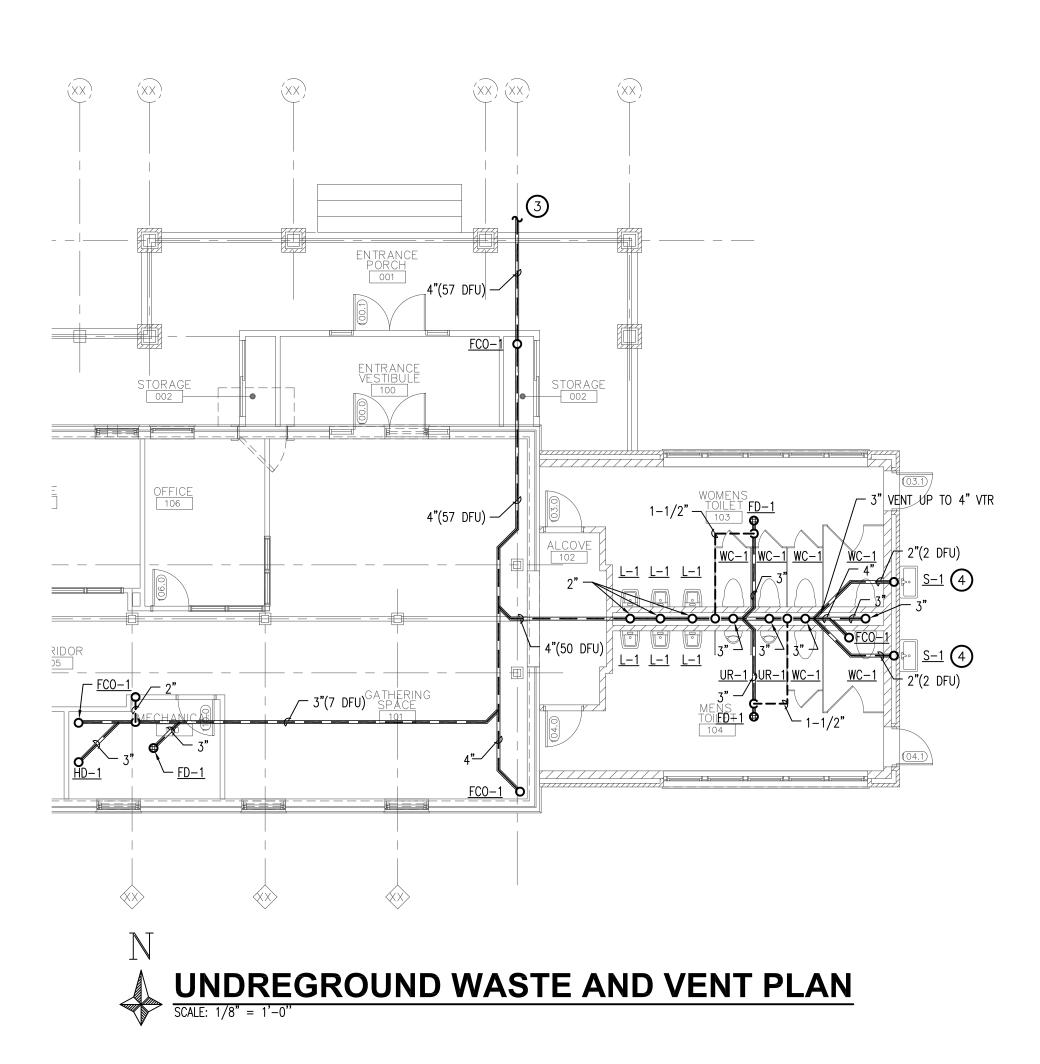

## **KEYED NOTES**

- 1 LOCATE HOSE BIBB 24 INCHES ABOVE FINISHED GRADE. HOSE BIBB PENETRATION THROUGH EXTERIOR WALL SHALL BE CAULKED WATER TIGHT.
- 2 REFER TO WATER HEATER DETAIL FOR INSTALLATION REQUIREMENTS. FURNISH WATER HEATER WITH EXPANSION TANK (ET-1).
- 3 PLUMBING CONTRACTOR SHALL BE RESPONSIBLE FOR PLUMBING SYSTEMS TO 5'-0" FROM ENTRANCE PORCH. COORDINATE PIPING INVERT REQUIREMENTS WITH SITE CIVIL CONTRACTOR.
- 4 SANITARY TRAPS OF SINKS EXPOSED TO FREEZING. PROVIDE REMOVABLE TRAPS. OWNER SHALL CAP SANITARY LINES SERVING EXTERIOR SINKS DURING FREEZING CONDITIONS.
- (HB-1) AS DRIP LEG FOR SEASONAL DRAIN DOWN. PITCH ALL HORIZONTAL SUPPLY PIPING TOWARDS HOSE BIBB TO FLUSH OUT LINE.



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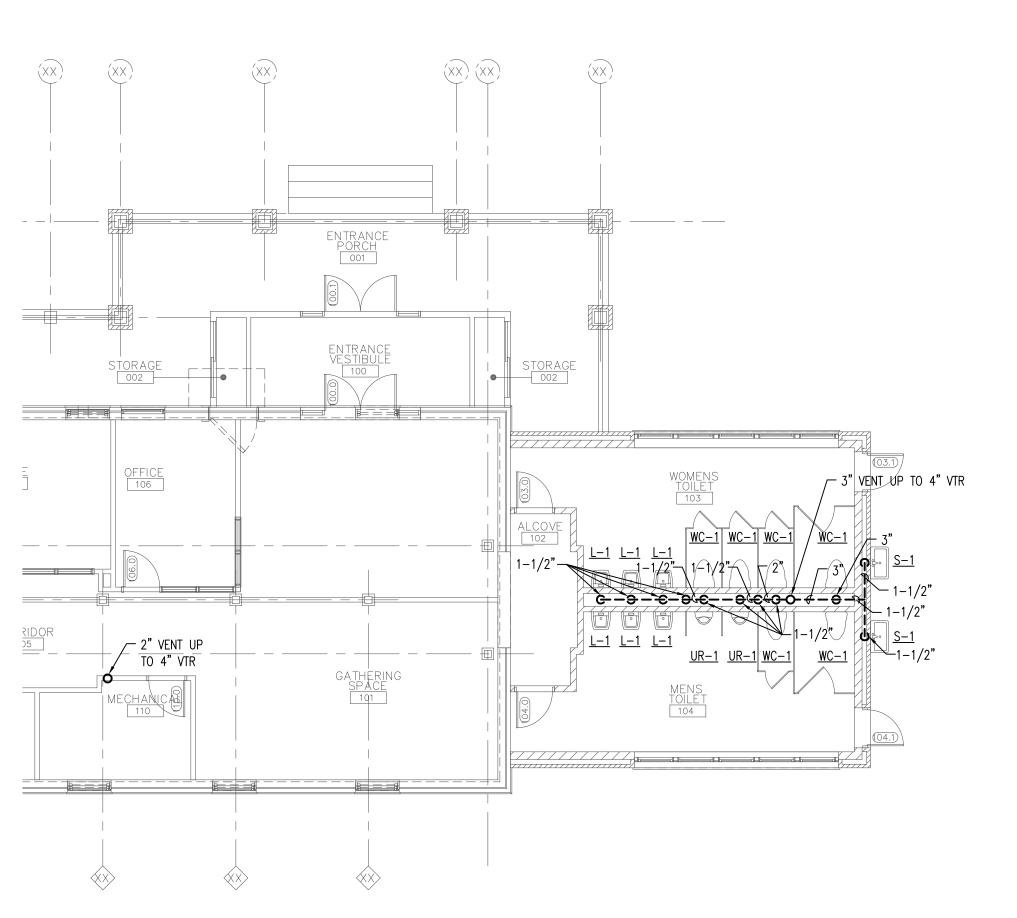
PROJECT TEAM

PROJECT NAME

HUNGER TASK FORCE GRANARY ALTERATION & ADDITION


SOUTH 68TH STREET FRANKLIN, WISCONSIN





SUSPENDED CEILING WASTE AND VENT PLAN

SCALE: 1/8" = 1'-0"

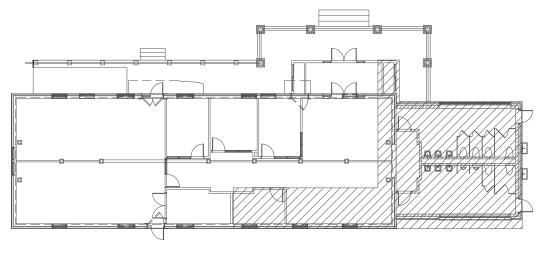

KEYPLAN

SCALE: NO SCALE

SET TYPE 50% CONSTRUCTION DOCUMENTS

D R A W IN G IS S U E H IS T O R Y SD 07-28-2014 Schematic Design

AA PROJECT NUMBER 13015

DATE 08-25-2014

SHEET TITLE
SUPPLY PIPING, WASTE
AND VENT PLANS
SHEET NUMBER


P1.1

Water Supply Fixture Unit Schedule												
		SFU .	Individual	No. Of								
Fixture	Tag	Hot	Cold	Total	Fixtures	Total						
HOSE BIBB	HB-1		3.00	3.00	1	3.00						
LAVATORY	L-1	0.50	0.50	1.00	6	6.00						
SINK	S-1	2.00	2.00	3.00	2	6.00						
URINAL	UR-1		4.00	4.00	2	8.00						
WATER CLOSET	WC-1	-	6.50	6.50	6	39.00						
TOTAL						62.00						
	*Supply systems predominately for flushometer Total Fixture Units = 54 Gallons Per Minute											


Drair Uni	nage it Scl	
Fixture	Tag	DF
FLOOR DRAIN (3")	FD-1	3.0
HUB DRAIN (3")	HD-1	4.0
LAVATORY	L-1	1.0
SINK	S-1	2.0
URINAL	UR-1	2.0
WATER CLOSET	WC-1	6.0
TOTAL		•



PROJECT TEAM

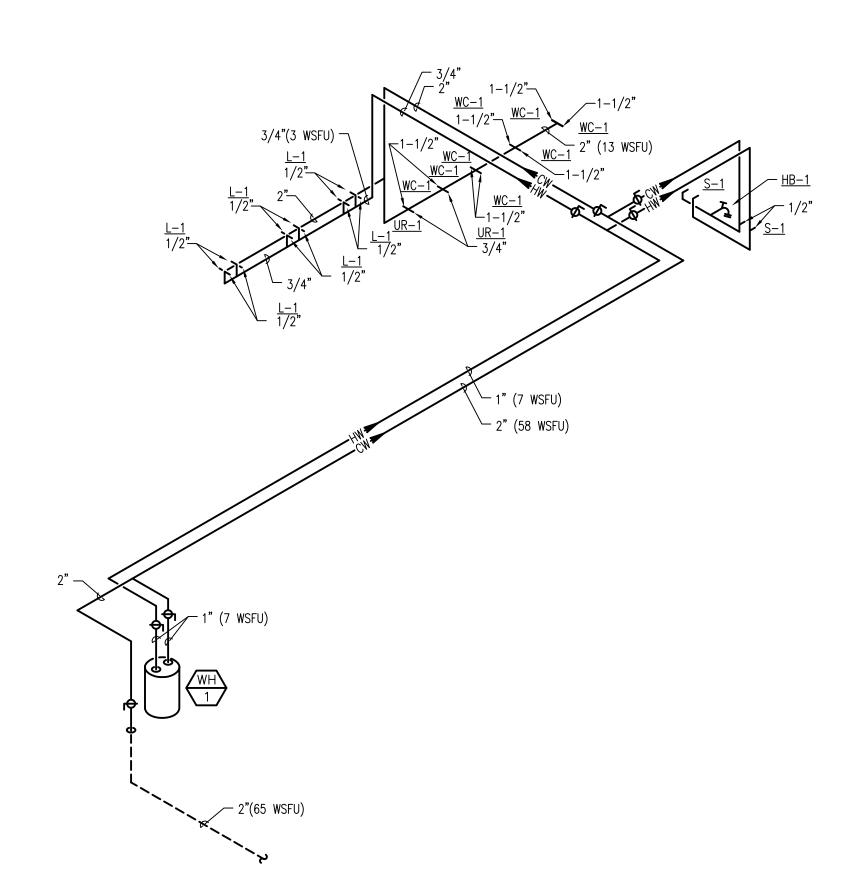

SUPPLY PIPING ISOMETRIC
SCALE: NO SCALE

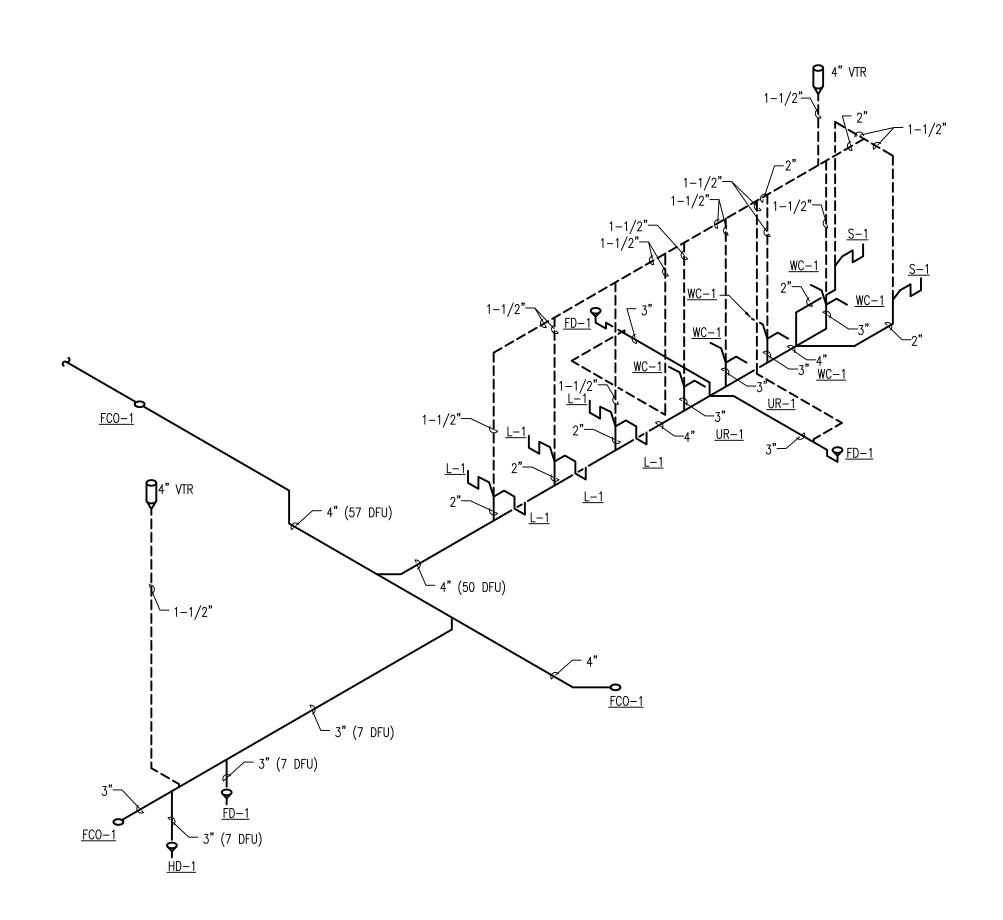

WASTE AND VENT ISOMETRIC
SCALE: NO SCALE

PROJECT NAME
HUNGER TASK FORCE
GRANARY ALTERATION
& ADDITION

SOUTH 68TH STREET FRANKLIN, WISCONSIN

D R A W IN G IS S U E H IS T O R Y SD 07-28-2014 Schematic Design

SET TYPE
50% CONSTRUCTION
DOCUMENTS

AA PROJECT NUMBER 13015

DATE 08-25-2014


SHEET TITLE
PLUMBING ISOMETRICS

SHEET NUMBER

	MECHANICAL SYMBOLS	
ITEM INDICATED	DOUBLE LINE DRAWING REPRESENTATION	SINGLE LINE DRAWING REPRESENTATION
BUTTED TAKEOFFS FLEXIBLE DUCT & VOLUME DAMPER	6X6	6X6 VD 10 8
DIFFUSERS	CD2-200 CD1-100 1	CD2-200 CD1-100 1
BUTTED TAKEOFFS TO REGISTER OR GRILLE	SG2-300 14X8 12X8	SG2-300 2 14 12 8 8
RETURN OR EXHAUST REGISTER OR GRILLE IN BOTTOM OF DUCT CENTERED ON DUCT	24X10 Z	24 7 10 L ER1-200
ECCENTRIC EXPANSION OR CONTRACTION	PER SMACNA 14X6	2 10 14 6
CONCENTRIC EXPANSION OR CONTRACTION	PER SMACNA 14X6	≥ 10 < 14
DAMPER – SMOKE, FIRE OR MOTORIZED TYPE AS NOTED	ACCESS PANEL FIRE F SMOKE S M MOTORIZED FOR FIRE DAMPER	A.P. F S M
INTERNALLY LINED DUCTWORK	SOUND INSULATION	SOUND INSULATION
SUPPLY DUCT TURNING UP AND DOWN	TURNING UP TURNING DOWN  SIDE SHOWN SIDE NOT SHOWN	N 14
RETURN OR EXHAUST DUCT TURNING UP AND DOWN	TURNING UP TURNING  14X10 DOWN  SIDE SHOWN SIDE NOT SHOWN	14 10
TURNING VANES		<u>-</u>

	ILLE, DIFFUSER, AND PIPE	SIZES AKE IN INCHES.	1 1 2	<u> </u>
SOIL OR WASTE ABOVE GROUND		N	1 2 3 4 5 6 7	8 9
SOIL OR WASTE UNDERGROUND	DI DEIONIZED WATER	NO NITROUS OXIDE		
VENT PIPE	SW SOFT WATER	—LPS— LOW PRESSURE STEAM (0–20 PSI)	10 11 12 13 14 15	16 17
RAIN WATER ABOVE GROUND	F FIRE LINE	——LPC—— LOW PRESSURE CONDENSATE	18 19 20 21 22 23 24	25 26
RAIN WATER UNDERGROUND	FS FIRE SPRINKLER	—MPS— MEDIUM PRESSURE STEAM (21-74 PSI)	1. SIDE CONNECTION 14. EXP. JOINT W 2. ELBOW DOWN 15. REDUCER	I/ PIPE GUIC
⇒ ⇒ SUBDRAIN	CA COMPRESSED AIR	MPC MEDIUM PRESSURE CONDENSATE	3. ELBOW UP 16. STRAINER 4. SHUT-OFF VALVE 17. UNION 5. BALANCING VALVE 18. DIRECTION OF	- FI OW
——D—— DRAIN	——CS—— CONDENSER WATER SUPPLY	—HPS— HIGH PRESSURE STEAM (75+ PSI)	6. CONTROL VALVE 19. STEAM TRAP 7. PRESSURE REDUCING VALVE 20. PITCH PIPE [	
—CW—— COLD WATER	CR CONDENSER WATER RETURN	—HPC— HIGH PRESSURE CONDENSATE	8. PRESSURE RELIEF VALVE 21. VALVE IN VEF 9. CHECK VALVE 22. 3-WAY CONT	ROL VALVE
HW HOT WATER	—CHWS— CHILLED WATER SUPPLY	G GAS	10. AIR VENT 23. CIRCUIT SETT 11. PRESSURE GAUGE 24. BALL VALVE 12. THERMOMETER 25. BUTTERFLY V.	
—RHW—— RECIRCULATED HOT WATER	—CHWR— CHILLED WATER RETURN	FOF FUEL OIL FILL	13. PIPE ANCHOR 26. TRIPLE DUTY	
-HW180- 180° WATER (OR TEMP. INDICATED)	RL	—FOS— FUEL OIL SUPPLY	4 NUMBER OF SECTION  M5 NUMBER OF SHEET WHERE SECTION	J APPFARS
ARV ACID RESISTANT VENT	RS	FOR FUEL OIL RETURN	2 NUMBER OF DETAIL	, ALL LANG
—ARW—— ACID RESISTANT WASTE	—HWS— HOT WATER HEATING SUPPLY	FOV FUEL OIL VENT	M3 NUMBER OF SHEET WHERE DETAIL	APPEARS
O—O OXYGEN	—HWR— HOT WATER HEATING RETURN	FOG	RTU — EQUIPMENT TYPE  3 UNIT NUMBER (SEE EQUIPMENT SCH	HEDULES)
<u> FD</u> FLOOR DRAIN	S SENSOR →	FIRE DEPT CONNECTION	) THERMOSTAT <u>LINE</u> T	YPES
(O) <u>RD</u> ROOF DRAIN	CO CLEAN OUT	PENDANT TYPE SPRINKLER HEAD W/ CEILING PLATE	CONNECT NEW TO EXISTING	<ul><li>EXISTING</li><li>DEMO</li></ul>
<u>DS</u> DOWN SPOUT	-O- CLEAN OUT O	UPRIGHT SPRINKLER HEAD	AIR FLOW ON NEGATIVE SIDE	- NEW
→ HB HOSE BIB	S.P. STAND PIPE S	SMOKE DETECTOR —	AIR FLOW ON SUPPLY SIDE	

A/C A	AIR CONDITIONER	EC	ELECTRICAL CONTRACTOR	ID	INSIDE DIAMETER	S	SINK
A/E A	ARCHITECT/ENGINEER	ELEC	ELECTRICAL	ΙE	INVERT ELEVATION	SA	SUPPLY AIR
	AIR HANDLÍNG UNIT	EL	ELEVATION	INSUL	INSULATION	SAN	SANITARY
ALT A	ALTERNATE	EQUIP	EQUIPMENT	IPS	IRON PIPE SIZE	SCH	SCHEDULE
	ACCESS PANEL	EWC	ELECTRIC WATER COOLER			SECT	SECTION
	APPROXIMATELY	EXH	EXHAUST	JAN	JANITOR	SH	SHOWER
ARCH A	ARCHITECTURAL/ARCHITECT	EXIST	EXISTING	5		SP	STATIC PRESSURE
		EXP	EXPANSION	LAV	LAVATORY	SPEC	SPECIFICATION
BDD E	BACK DRAFT DAMPER	EXT	EXTERIOR	٥		SS	STAINLESS STEEL
	BRITISH THERMAL UNIT	LAT	EXTENSION	MB	MOP BASIN	STD	STANDARD
	B.T.U. PER HOUR	F&T	FLOAT & THERMOSTATIC		THOUSAND BTUS PER HOUR	STM	STEAM
DIOII L	J.I.O. I EN HOOK	FCO	FLOOR CLEANOUT	MC	MECHANICAL CONTRACTOR		STRUCTURAL
r c	CENTER LINE	FD	FLOOR DRAIN	MECH	MECHANICAL CONTRACTOR	SUSP	SUSPEND
	CABINET	FE	FIRE EXTINGUISHER	MED	MEDIUM	SW	SWITCH
	CAPACITY	FH	FIRE HYDRANT	MH	MAN HOLE	۷۷۷	SWITCH
	CUBIC FEET PER MINUTE	FL	FLOOR	MOD		T_ CTAT	THERMOSTAT
	CAST IRON	FLEX	FLEXIBLE	MTD	MOTOR OPERATED DAMPER MOUNTED	TEMP	TEMPERATURE
		FOF		MID	MOUNTED		
	CIRCULATOR		FUEL OIL FILL	NIAT	NATUDAL		THERMOSTATIC
	COOLING MANAGER	FOG	FUEL OIL GAUGE	NAT	NATURAL	THRU	THROUGH
	CONSTRUCTION MANAGER	FOR	FUEL OIL RETURN	00	ON OFNITED	TLT	TOILET
	CLEAN OUT	FOS	FUEL OIL SUPPLY	00	ON CENTER	TYP	TYPICAL
	COMBINATION	FOV	FUEL OIL VENT		OUTSIDE DIAMETER		
	COMPRESSOR	FPM	FEET PER MINUTE	OPG	OPENING	UL	UNDERWRITERS L
	CONCRETE	FPS	FEET PER SECOND			UR	URINAL
	CONDENSATE, CONDENSOR	FT	FEET	PLBG	PLUMBING		
	CONNECTION				POUNDS PER SQ. INCH ABSOLUTE	V	VENT
	CONTINUOUS	GA	GAUGE	PSIG	POUNDS PER SQ. INCH GAUGE	VAC	VACUUM
	CONTRACTOR	GALV	GALVANIZE		PREFABRICATED	VCP	VITRIFIED CLAY P
	CONVECTOR	GC	GENERAL CONTRACTOR	PRV	PRESSURE REDUCING VALVE	VERT	VERTICAL
CUH C	CABINET UNIT HEATER	GEN	GENERAL			VOL	VOLUME
		GPH	GALLONS PER HOUR	RA	RETURN AIR	VTR	VENT THRU ROOF
	DRY BULB TEMP.	GPM	GALLONS PER MINUTE		RADIATOR		
	DRINKING FOUNTAIN			RD	ROOF DRAIN	W	WASTE
	DIAMETER	HB	HOSE BIB	REC	RECESSED	W/	WITH
	DIFFUSER	HD	HEAD	REF	REFRIGERANT	W/O	WITHOUT
DIM D	DIMENSION	HOR	HORIZONTAL	REL	RELIEF	WΒ	WET BULB TEMP.
	DISCHARGE	HP	HORSEPOWER	REQ	REQUIRED	WC	WATER CLOSET
	OOWN	HTG	HEATING	RET	RETURN	WCO	WALL CLEANOUT
	DAMPER	HTR	HEATER	REV	REVISION	WH	WATER HEATER
	DOWN SPOUT			RPM	REVOLUTIONS PER MINUTE	•	
	DIRECT EXPANSION						
υΛ L	ZINEOT ENTAITON						

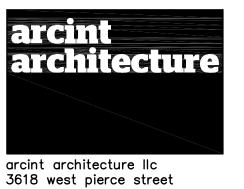

3618 west pierce street milwaukee, wisconsin 53215 arcint—architecture.com


PROJECT TEAM

PROJECT NAME


HUNGER TASK FORCE GRANARY ALTERATION & ADDITION

SOUTH 68TH STREET FRANKLIN, WISCONSIN



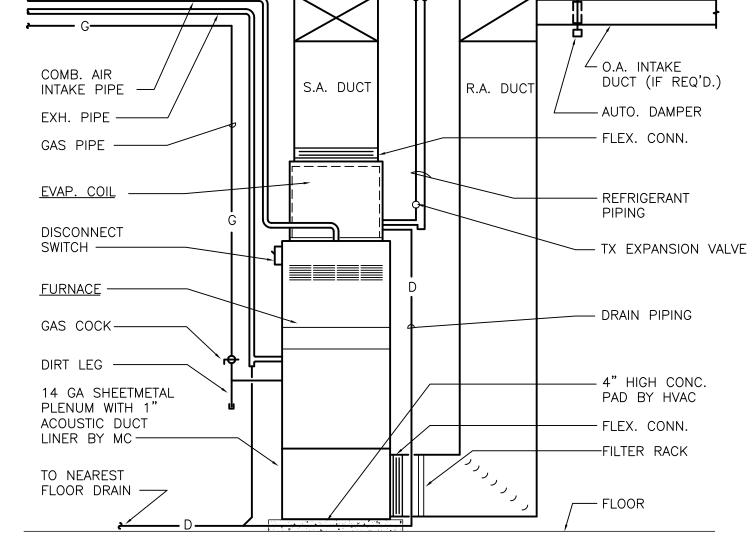


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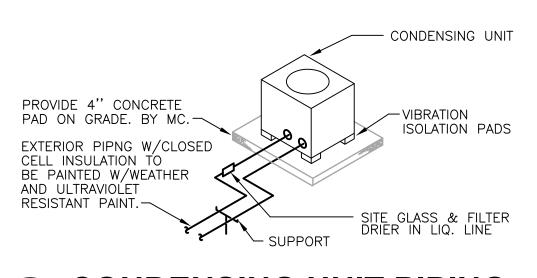

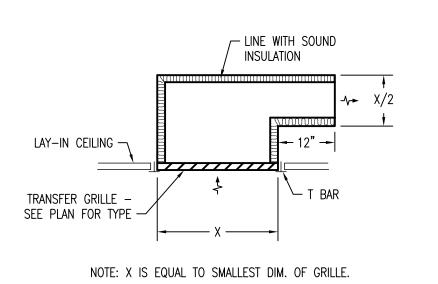
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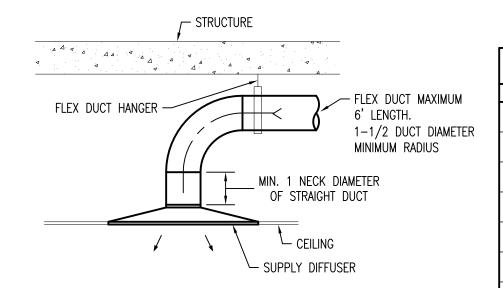






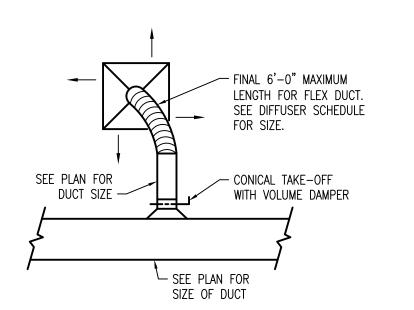

3	<b>CONDENSING UNIT PIPING</b>
M1.0	NO SCALE



		AIR	INLET	SA	ND OL	<b>ITLE</b> 1	rs s	CH	ED	ULE	
FLEX DUCT MAXIMUM	Unit Type	Manufacturer	Model No.	Finish	Туре	Material	Size	Inlet	Damper	Mounting	Remarks
FLEX DUCT HANGER  6' LENGTH.  1–1/2 DUCT DIAMETER	CD1	Titus	TMSR-AA	Mill	Ceiling Diffuser	AL	18ø	10 <b>"</b> ø	N	Duct	
MINIMUM RADIUS	CD2	Titus	TMSR-AA	Mill	Ceiling Diffuser	AL	14.75ø	8"ø	N	Duct	
MIN. 1 NECK DIAMETER OF STRAIGHT DUCT	CD3	Titus	R-OMNI	White	Ceiling Diffuser	AL	18 <b>"</b> ø	8"ø	N	Surface	
	DG	Titus	CT-700L1	White	Ceiling Diffuser	AL	18X12	18X12	N	Surface	
CEILING	RG1	Titus	80	White	Return Grillle	Aluminum	12X12	12X12	N	Surface	
SUPPLY DIFFUSER	RG2	Titus	80	White	Return Grillle	Aluminum	12X12	12X12	N	Surface	
SUPPLY DIFFUSER DETAIL	RG3	Titus	80	White	Return Grillle	Aluminum	12X12	12X12	N	Surface	
) NO SCALE	SG1	Titus	32	White	Supply Grille	Aluminum	16X8	8X6	Υ	Duct	

	AIR COOLED CONDENSING UNIT SCHEDULE																							
Unit	Service	Location	Manufacturer	Model	Nominal	SEER	Fan	Data	Compress	or Data			Refrigera	nt Data			-	EI	ectrical	I Data				
No.					Capacity		No. of	Fan	No. of	Compressor	No. of	Refrigerant	Refrigerant	Refrigerant	Operating Charge	Voltage	Phase	FLA	MCA	MOCP	Starter	Disconnect	Unit	Remarks
CU							Fans	Motor	Compressors	RLA	Circuits	Type	Vapor	Liquid	at 15 ft						Ву	Ву	Weight	
					(Btuh)			FLA					(in OD)	(in OD)	(lbs.)								(lbs.)	
1	F-1	SEE PLANS	Trane	4TTA3048D3	48,000	13	1	0.	1	6.2	1	R410A	7/8	3/8	_	208	3	_	18	30	Mfr	EC	203	1
1	F-2	SEE PLANS	Trane	4TTA3048D3	48,000	13	1	0.	1	6.2	1	R410A	7/8	3/8	_	208	3	_	18	30	Mfr	EC	203	1

Notes:	1	Provide	low	ambient	control	to	-10°	F
110103.	٠.	1 TOVIGE	1011	unibicité	COILLIO	w	10	

						F	FURN	IACE	ES	CHE	DULE										
Unit	Service	Location	Manufacturer	Model No.		Fan	Section		(	Cooling Coil S	ection	Heating	Section		Ele	ctrical Do	ata			Unit	Remarks
No.					Supply Air	Minimum	Supply	Supply Fan	Coil	Refrigerant	Refrigerant	Input	Output	Voltage	Phase	FLA	Min.	Fuse	Disconnect	Weight	
F					(CFM)	Outside Air	External SP	Motor Size	Model	Liquid Size	Suction Size	(MBH)	(MBH)				Circuit	Amps	By:		
						(CFM)	(in. of W.C.)	(HP)		(in.)	(in.)						Amp			(lbs.)	
1	Varies — See Plan	Mechanical Room	Trane	TUH1D120A9601A	1600	330	0.5"	0.75	4TXC060	7/8	3/8	120	104.5	115	1	_	12.9	20	EC		1
2	Varies — See Plan	Mechanical Room	Trane	TUH1D120A9601A	1600	330	0.5"	0.75	4TXC060	7/8	3/8	120	104.5	115	1	_	12.9	20	EC		1

3. Interlock with room lighting control.

	EXHAUST FAN SCHEDULE																
Unit No.	Service	Location	Manufacturer	Model No.	Airflow	Ext. S. P.	Motor Size	Motor Speed	Speed	Fan Type	Drive		Е	lectrical Data		Unit Weight	Remarks
EF					(CFM)	(in. of W.C.)	(HP)	(RPM)	(FRPM)			Voltage	Phase	Starter By:	Disconnect By:	(lbs.)	
1	General Exhaust	Ceiling	Greenheck	G-095 VG	700	0.50	.25	1500	1635	Cent.	Direct	115	1	Mfr.	MFR	50	1, 2, 3

Notes: 1. Provide with 12-inch pitched roof curb. 2. Furnish with speed control for balancing, locate at unit.

	ELECTRIC WALL HEATER SCHEDULE																
Unit No.																	
EWH	Voltage Phase Amps Integral Remote Recessed Semi-Rec Surface Bracket By: (lbs.)																
1	Womens Toilet 103	Q Mark	AWH - 44083	208	3	11.1	4000	13652	Х	-	Х	_	_	_	MFR	25	1, 2
2	Mens Toilet 104	Q Mark	AWH - 44083	208	3	11.1	4000	13652	Х	_	X	_	_	_	MFR	25	1, 2

Notes:	1.	Mount	units	а	min	imum	8"	AFF
	2.	Provide	nort	hei	n w	hite o	olo	-

ELECTRIC CABINET UNIT HEATER SCHEDULE																
Unit	Service	Manufacturer	Model No.	Unit	Capacity	Airflow	EAT	Fan	Recess			Ele	ctrical D	ata		
No.				Configuration				Speeds		Motor Size	KW	Voltage	Phase	Starter	Disconnect	Remarks
ECH					(MBh)	(CFM)	(°F)		(in.)	(HP)				By:	By:	
1	Entrance Vestibule 100	Q Mark	CU 935	FIFO	20.5	250	60	2	Full	1/8	6.0	208	3	Mfr.	EC	

No.	Max. APD Max. Fac	e Free Area	Remarks
	Volocity		
(051)	<b>l</b> velocity		
L (CFM) (in) (in.) (in.) (in.)	in. of W.G.) (fpm)	(sq. ft.)	
1 F-1, F-2 Greenheck ESD-635 660 36 18 6	0.05 500	1.42	Color by Architect

	ELECTRIC BASEBOARD SCHEDULE									
Unit No.	Service	Manufacturer	Model No.		Element		Watts	Btuh	Length	Remarks
EB				Voltage	Phase	Amps				
1	Office 108	Q Mark	CBD - 1008	208	1	4.8	1000	3413	46"	1
2	Office 107	Q Mark	CBD - 1008	208	1	4.8	1000	3413	46"	1
3	Office 106	Q Mark	CBD - 1008	208	1	4.8	1000	3413	46"	1

Note: 1. provide low voltage relay for OA lockout

DRAWING LIST
SYMBOLS, ABBREVIATIONS, SCHEDULES & DETAILS MECHANICAL FLOOR PLAN

D R A W IN G IS S U E H IS T O R Y SD 07-28-2014 Schematic Design

SET TYPE 50% CONSTRUCTION DOCUMENTS


AA PROJECT NUMBER 13015

DATE 08-25-2014

SHEET TITLE SYMBOLS, ABBREVIATIONS. SCHEDULES & DETAILS SHEET NUMBER

M1.0



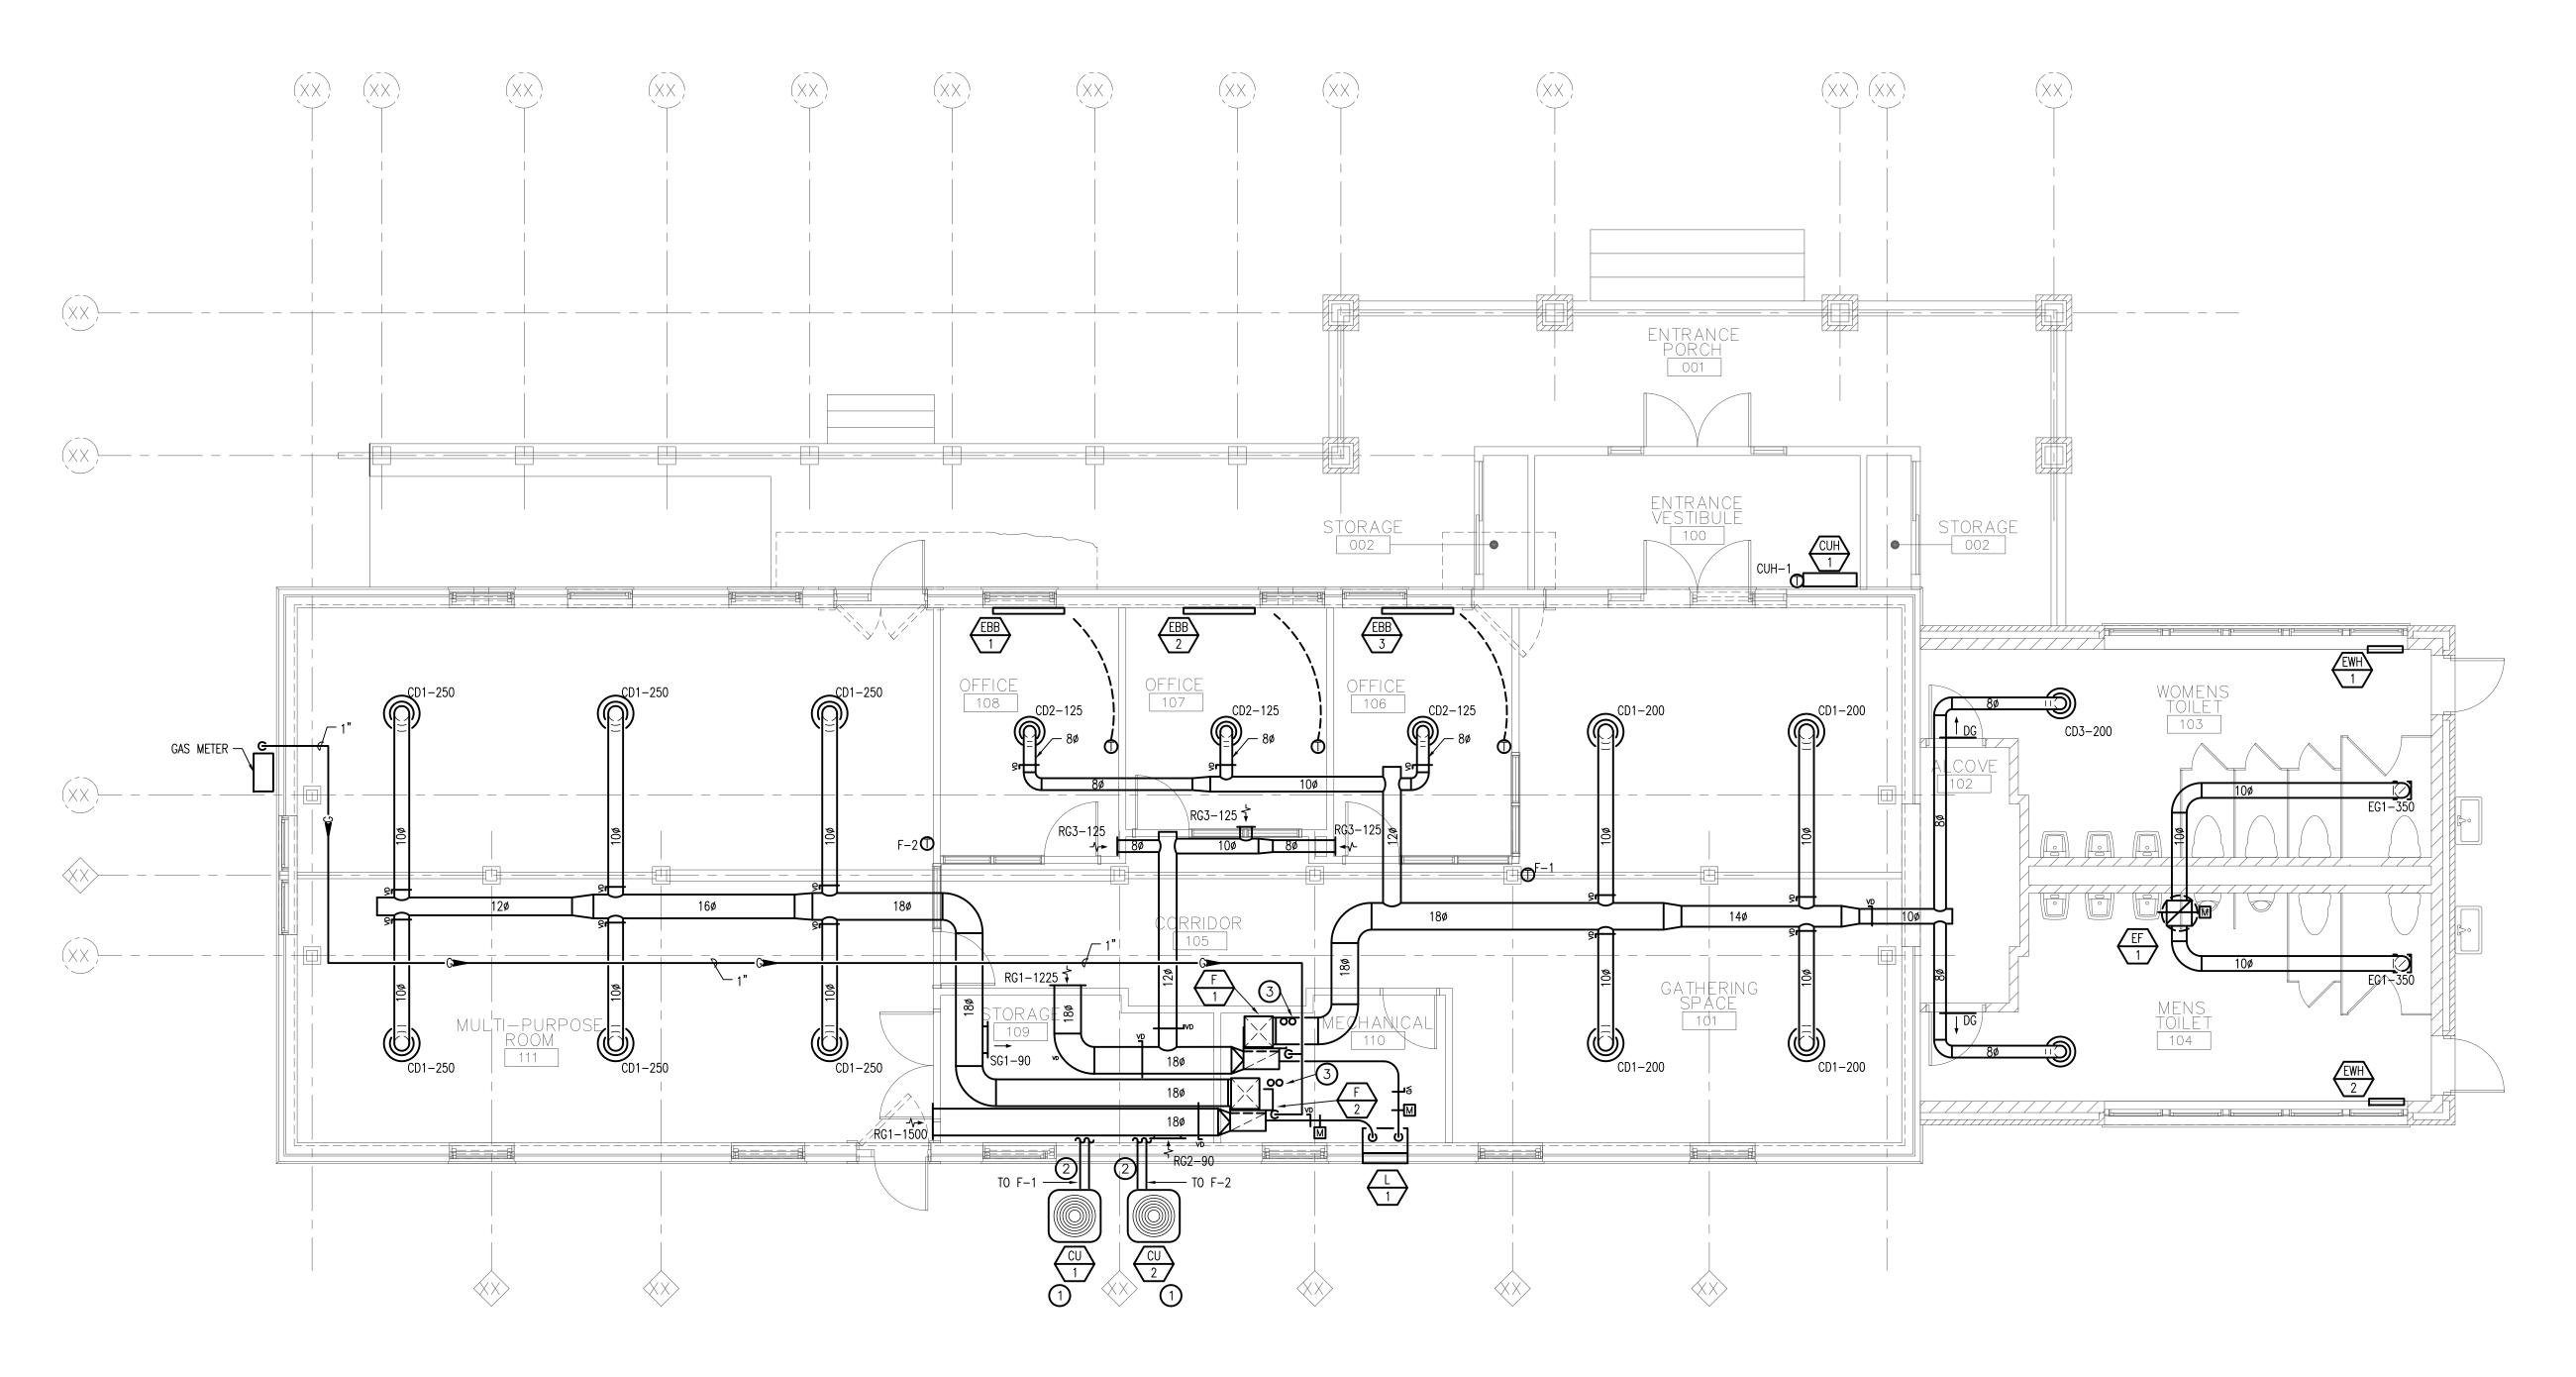

MECHANICAL FLOOR PLAN

SCALE: 3/16" = 1'-0"

# **KEY NOTES**

SET LEVEL ON 4" THICK HOUSE KEEPING PAD

2 REFRIGERATION PIPE. SIZE PER MANUFACTURER RECOMMENDATION.

3 VENT AND INTAKE PIPING UP THRU ROOF. SIZE AND INSTALL PER MANUFACTURER RECOMMENDATION

PROJECT TEAM



PROJECT NAME
HUNGER TASK FORCE
GRANARY ALTERATION
& ADDITION

SOUTH 68TH STREET FRANKLIN, WISCONSIN

D R A W IN G IS S U E H IS T O R Y SD 07-28-2014 Schematic Design

SET TYPE
50% CONSTRUCTION
DOCUMENTS


AA PROJECT NUMBER

DATE 08-25-2014

SHEET TITLE
MECHANICAL

FLOOR PLAN
SHEET NUMBER

M1.1

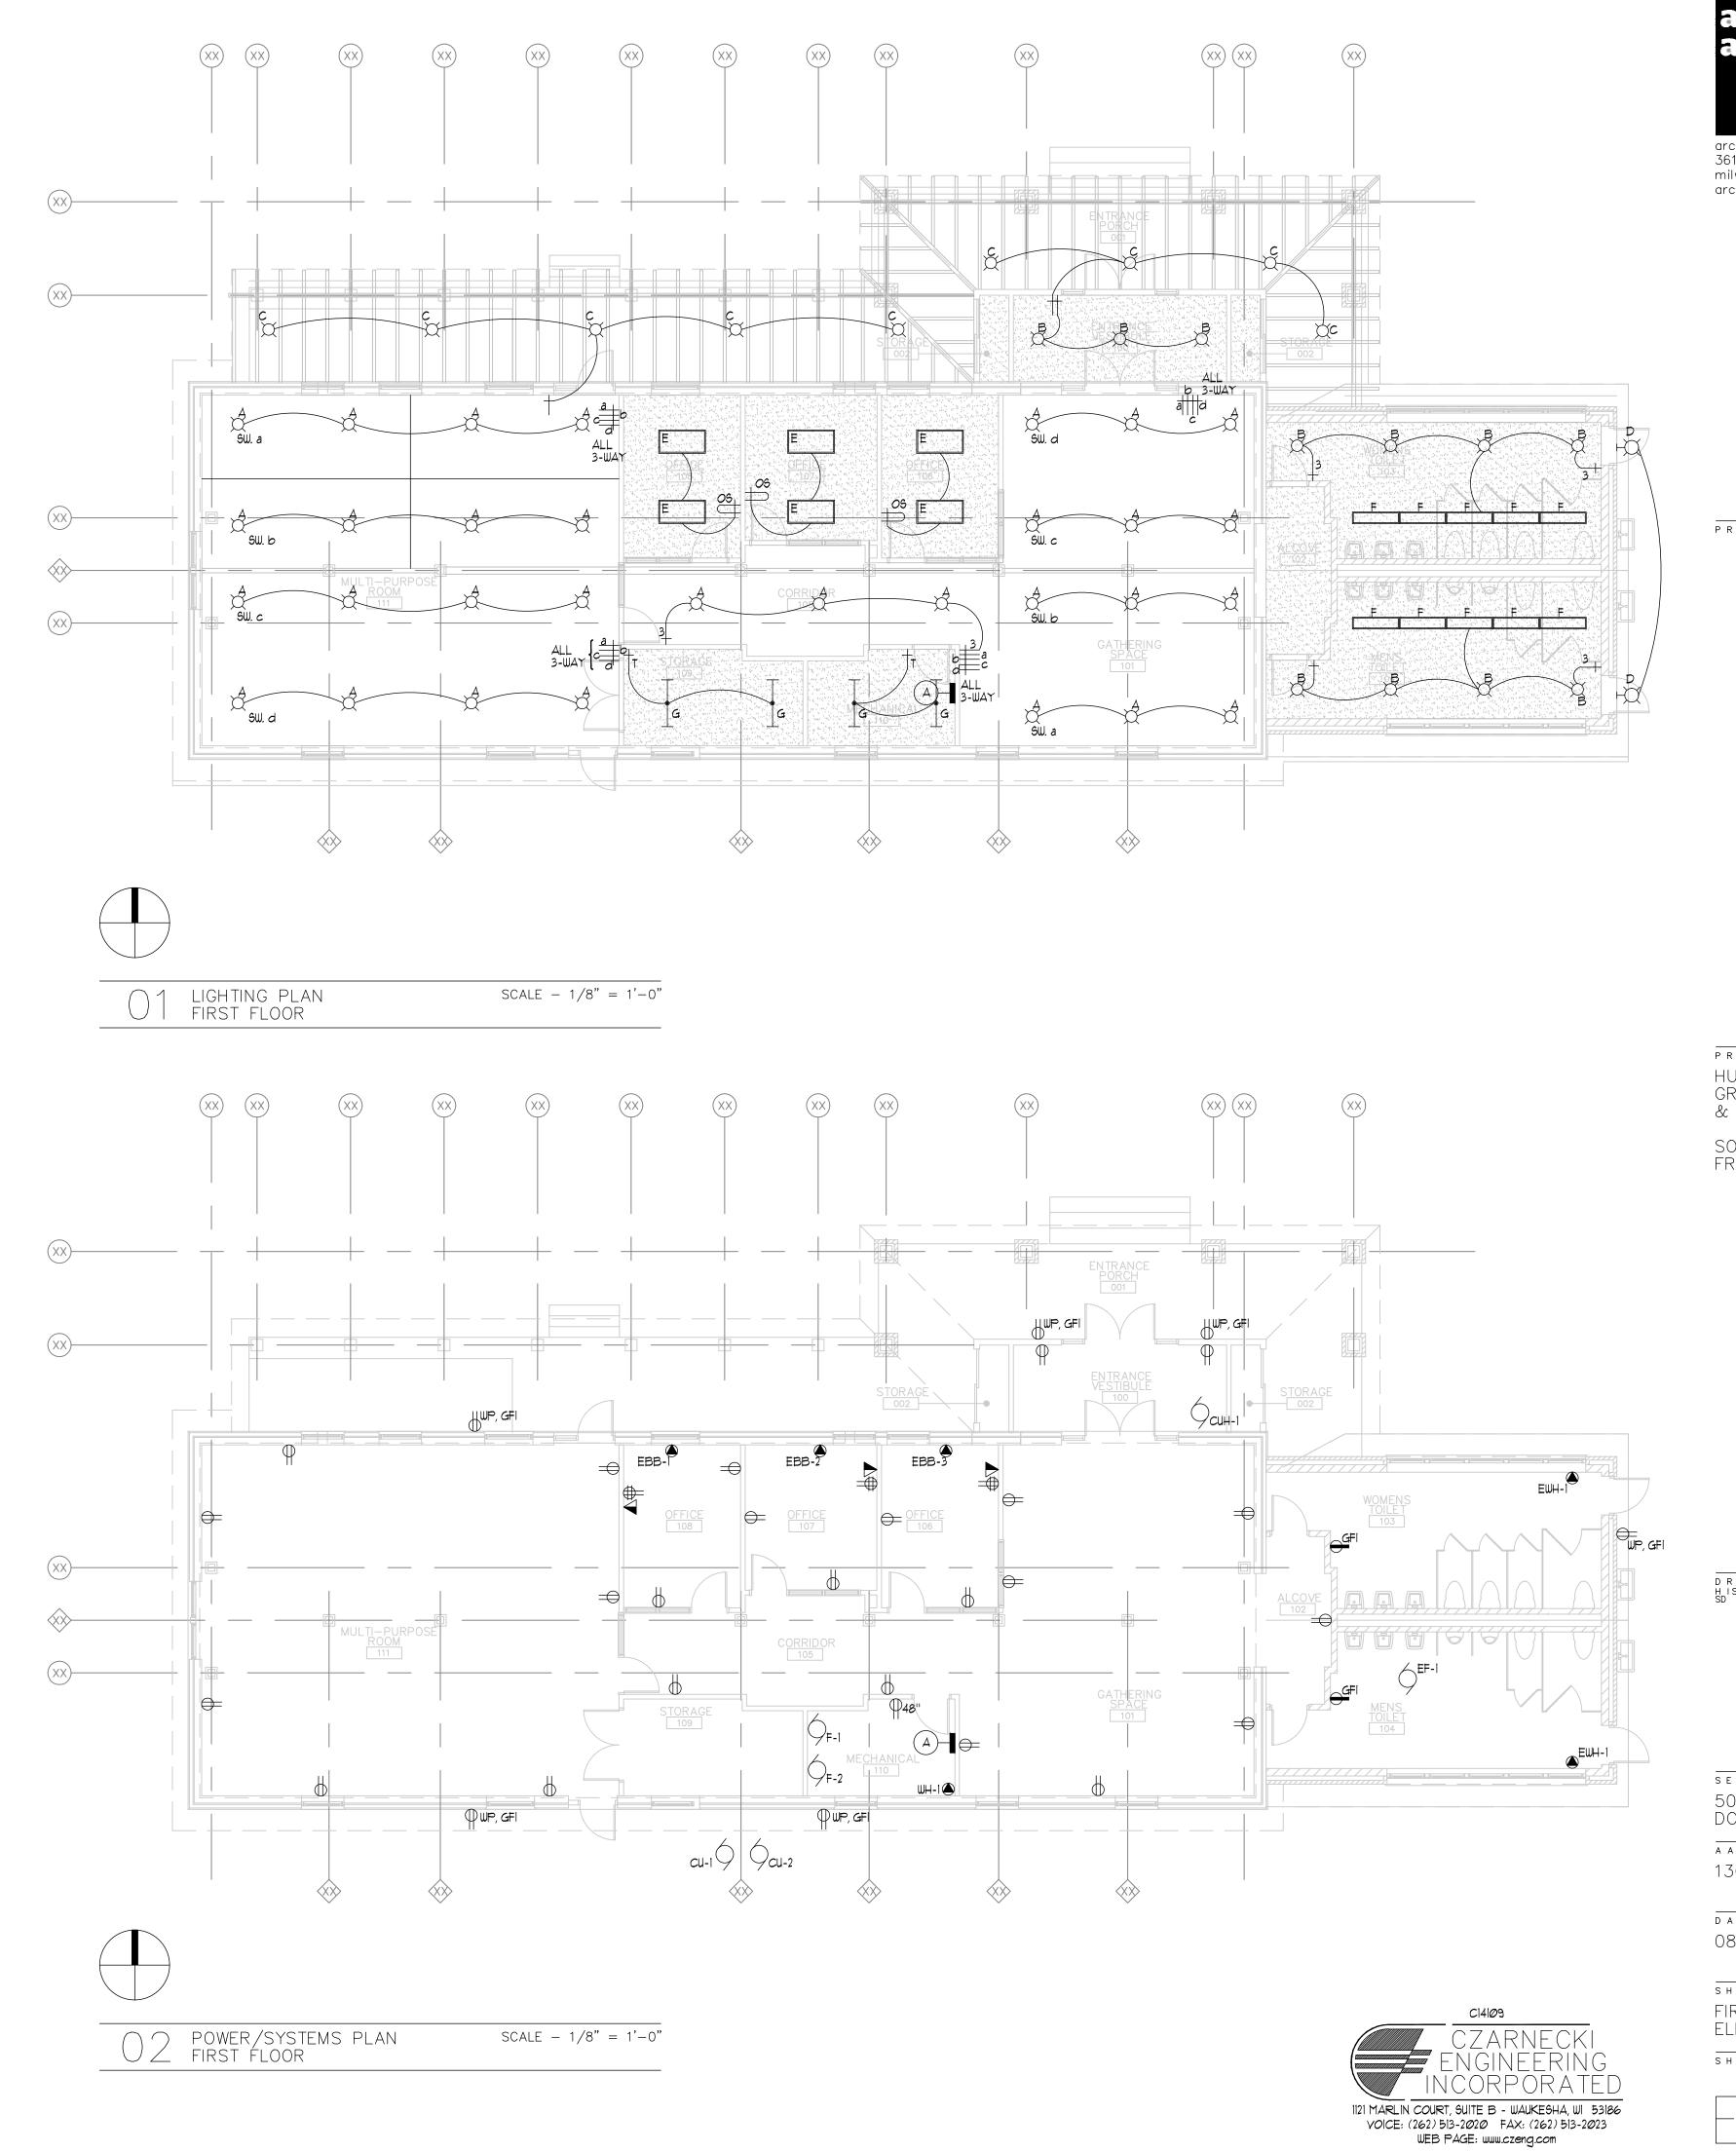



arcint architecture IIc 3618 west pierce street milwaukee, wisconsin 53215 arcint—architecture.com

PROJECT TEAM

PROJECT NAME
HUNGER TASK FORCE
GRANARY ALTERATION
& ADDITION

SOUTH 68TH STREET FRANKLIN, WISCONSIN

D R A W IN G IS S U E H IS T O R Y SD 07-28-2014 Schematic Design

set type 50% CONSTRUCTION DOCUMENTS

AA PROJECT NUMBER

DATE 08-25-2014

SHEET TITLE
FIRST FLOOR
ELECTRICAL PLAN
SHEET NUMBER



#### REPORT TO THE PLAN COMMISSION

Meeting of September 3, 2015

#### **Comprehensive Master Plan Amendment**

**RECOMMENDATION:** City Development Staff recommends approval of the proposed Comprehensive Master Plan Amendment.

**Project Name:** Horizon Resource Group, LLC CMP Amendment

**Project Address:** Approximately 9150 South 80<sup>th</sup> Street

**Applicant:** City of Franklin

Owners (property): Horizon Resource Group, LLC

Current Zoning: R-3 Suburban/Estate Single Family Residence District

Existing 2025 Future Land Use: Areas of Natural Resource Features and Institutional

Proposed 2025 Future Land Use: Residential and Areas of Natural Resource Features

Use of Surrounding Properties: Single-family residential to the north, south, east and west

**Applicant Action Requested:** Approval of the Comprehensive Master Plan Amendment

#### **Project Description:**

At their July 9, 2015 meeting, the Plan Commission recommended approval of a resolution conditionally approving a 2 lot certified survey map, being part of the Northeast 1/4 and the Northwest 1/4 of the Southeast 1/4 of Section 21, Township 5 North, Range 21 East, in the City of Franklin, Milwaukee County, Wisconsin. The Certified Survey Map (CSM) was subsequently approved by the Common Council at their July 21, 2015 meeting.

The Certified Survey Map resolution, Resolution No. 2015-7120, contained the following condition:

"The City shall amend the Comprehensive Master Plan Future Land Use Map to change the future land use designation from Institutional and Areas of Natural Resource Features to Residential and Areas of Natural Resource Features."

As such, the Department of City Development completed a Comprehensive Master Plan (CMP) Amendment Application and properly noticed a public hearing for the September 15, 2015 Common Council meeting.

The approved CSM subdivided an existing 9.4-acre property into two separate lots. Lot 1 of the CSM has an area of about 4.90 acres. Lot 2 has an area of approximately 4.51 acres. The current 2025 Future Land Use Map designates the property as Institutional and Areas of Natural Resource Features. It can be noted that the CMP envisioned that the subject property, along with the property located immediately to the west, could potentially be the site of a future public school, based upon input provided by Franklin School District representatives at that time.

However, it is staff's understanding that the School District is not interested in that property at this time.


To be consistent with the proposed residential and conservancy use of the property, staff recommended to amend the Future Land Use Map to Residential and Areas of Natural Resource Features. Please note that the existing Areas of Natural Resource Features will be amended to match the current field delineations as shown on the CSM and Conservation Easement, which were approved at the July 21, 2015 Common Council meeting.

#### **Staff Recommendation:**


City Development Staff recommends approval of the proposed Comprehensive Master Plan Amendment.



# ~9150 South 80th Street TKN 885-9996-000

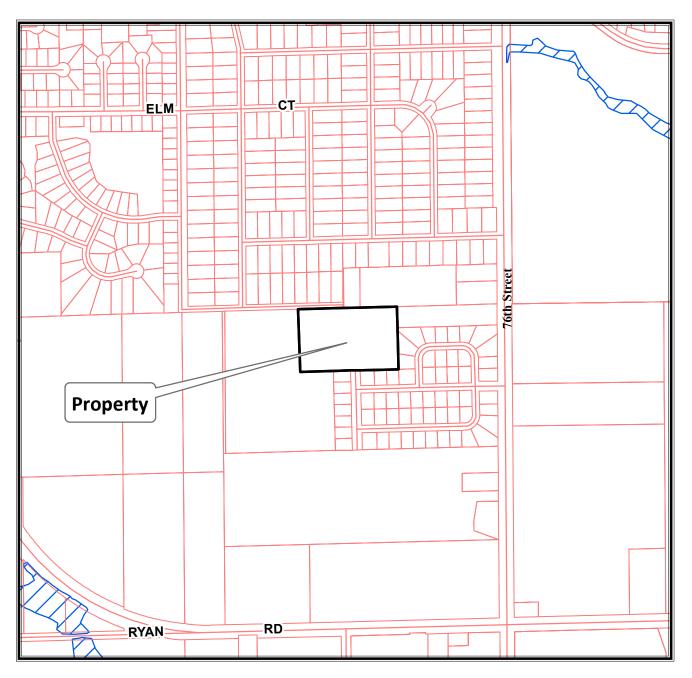

Planning Department (414) 425-4024

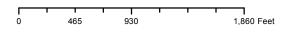


NORTH 2013 Aerial Photo


This map shows the approximate relative location of property boundaries but was not prepared by a professional land surveyor. This map is provided for informational purposes only and may not be sufficient or appropriate for legal, engineering, or surveying purposes.



# ~9150 South 80th Street TKN 885-9996-000

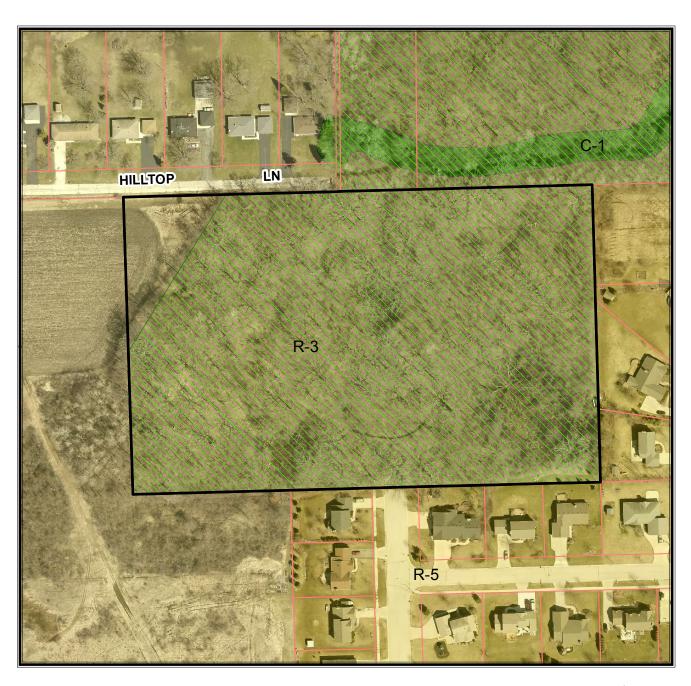

Planning Department (414) 425-4024

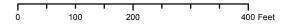

NORTH 2013 Aerial Photo

This map shows the approximate relative location of property boundaries but was not prepared by a professional land surveyor. This map is provided for informational purposes only and may not be sufficient or appropriate for legal, engineering, or surveying purposes.

#### CITY OF FRANKLIN PLAN COMMISSION

MILWAUKEE COUNTY [Draft 8-26-15]

RESOLUTION NO. 2015-\_\_\_\_

A RESOLUTION RECOMMENDING THE ADOPTION OF AN ORDINANCE TO AMEND THE CITY OF FRANKLIN 2025 COMPREHENSIVE MASTER PLAN TO CHANGE THE CITY OF FRANKLIN 2025 FUTURE LAND USE MAP FOR PROPERTY LOCATED AT APPROXIMATELY 9150 SOUTH 80TH STREET FROM INSTITUTIONAL USE AND AREAS OF NATURAL RESOURCE FEATURES USE TO RESIDENTIAL USE AND AREAS OF NATURAL RESOURCE FEATURES USE, PURSUANT TO WIS. STAT. § 66.1001(4)(b)

\_\_\_\_\_

WHEREAS, pursuant to Wis. Stat. §§ 62.23(2) and (3) and 66.1001(4), the City of Franklin is authorized to prepare and adopt and to amend a comprehensive plan as defined in Wis. Stat. §§ 66.1001(1)(a) and 66.1001(2); and

WHEREAS, pursuant to Wis. Stat. § 66.1001(4)(b), the Plan Commission may recommend the amendment of the Comprehensive Master Plan to the Common Council by adopting a resolution by a majority vote of the entire Commission, which vote shall be recorded in the official minutes of the Plan Commission; and

WHEREAS, the City of Franklin has applied for an amendment to the Comprehensive Master Plan to change the City of Franklin 2025 Future Land Use Map designation for property located at approximately 9150 South 80th Street, from Institutional Use and Areas of Natural Resource Features Use to Residential Use and Areas of Natural Resource Features Use, such property bearing Tax Key No. 885-9996-000, more particularly described as follows:

Part of the Northeast 1/4 and the Northwest 1/4 of the Southeast 1/4 of Section 21, Town 5 North, Range 21 East, in the City of Franklin, Milwaukee County, Wisconsin, bounded and described as follows:

COMMENCING at the Northeast corner of said 1/4 Section; thence South 88°27'55" West along the North line of said 1/4 Section 887.30 feet to the point of beginning of lands to be described; thence South 01°32'35" East 516.00 feet to a point on the North line of Stonewood Addition No. 1 Subdivision; thence South 88°27'25" West along said North line 816.00 feet to a point; thence North 01°32'35" West 516.00 feet to a point on the North line of said 1/4 Section; thence North 88°27'25" East along said North line 816.00 feet to the point of beginning. Containing 421,056 square feet or 9.6661 acres; and

RESOLUTION NO. 2015	
Page 2	

WHEREAS, the Plan Commission having determined that the proposed amendment, in form and content as presented to the Commission on September 3, 2015, is consistent with the Comprehensive Master Plan's goals, objectives and policies and in proper form and content for adoption by the Common Council as an amendment to the 2025 Comprehensive Master Plan, subject to such modifications the Common Council may consider reasonable and necessary, following public hearing, in order to protect and promote the health, safety and welfare of the City of Franklin.

NOW, THEREFORE, BE IT RESOLVED, by the Plan Commission of the City of Franklin, Wisconsin, that the application for and the proposed ordinance to amend the City of Franklin 2025 Comprehensive Master Plan to change the City of Franklin 2025 Future Land Use Map designation for property located at approximately 9150 South 80th Street, from Institutional Use and Areas of Natural Resource Features Use to Residential Use and Areas of Natural Resource Features Use, be and the same is hereby recommended for adoption and incorporation into the 2025 Comprehensive Master Plan by the Common Council.

day of	_, 2015.
Passed and adopted at a regular Franklin this day of	r meeting of the Plan Commission of the City of, 2015.
	APPROVED:
ATTEST:	Stephen R. Olson, Chairman
Sandra L. Wesolowski, City Clerk	
AYES NOES ABSENT	

MILWAUKEE COUNTY
[Draft 8-11-15]

ORDINANCE NO. 2015-\_\_\_\_

AN ORDINANCE TO AMEND THE CITY OF FRANKLIN 2025
COMPREHENSIVE MASTER PLAN TO CHANGE THE CITY OF FRANKLIN
2025 FUTURE LAND USE MAP FOR PROPERTY LOCATED AT APPROXIMATELY
9150 SOUTH 80TH STREET FROM INSTITUTIONAL USE AND AREAS OF NATURAL
RESOURCE FEATURES USE TO RESIDENTIAL USE AND
AREAS OF NATURAL RESOURCE FEATURES USE
(APPROXIMATELY 9.6661 ACRES)
(CITY OF FRANKLIN, APPLICANT)

WHEREAS, pursuant to Wis. Stat. §§ 62.23(2) and (3) and 66.1001(4), the City of Franklin is authorized to prepare and adopt and to amend a comprehensive plan as defined in Wis. Stat. §§ 66.1001(1)(a) and 66.1001(2); and

WHEREAS, the City of Franklin has applied for an amendment to the Comprehensive Master Plan to change the City of Franklin 2025 Future Land Use Map designation for property located at approximately 9150 South 80th Street from Institutional Use and Areas of Natural Resource Features Use to Residential Use and Areas of Natural Resource Features Use; and

WHEREAS, the Plan Commission of the City of Franklin by a majority vote of the entire Commission on September 3, 2015, recorded in its official minutes, has adopted a resolution recommending to the Common Council the adoption of the Ordinance to Amend the City of Franklin 2025 Comprehensive Master Plan to change the City of Franklin 2025 Future Land Use Map for property located at approximately 9150 South 80th Street from Institutional Use and Areas of Natural Resource Features Use to Residential Use and Areas of Natural Resource Features Use; and

WHEREAS, the City of Franklin held a public hearing upon this proposed Ordinance, in compliance with the requirements of Wis. Stat. § 66.1001(4)(d); the Common Council having received input from the public at a duly noticed public hearing on September 15, 2015; and

NOW, THEREFORE, the Mayor and Common Council of the City of Franklin, Wisconsin, do ordain as follows:

SECTION 1:

The City of Franklin 2025 Comprehensive Master Plan is hereby amended to change the City of Franklin 2025 Future Land Use Map designation for property located at approximately 9150 South 80th Street from Institutional Use and Areas of Natural Resource Features Use to Residential Use and Areas of Natural Resource Features Use.


ORDINANCE NO Page 2	D. 2015
	Such property is more particularly described as follows:
	Part of the Northeast 1/4 and the Northwest 1/4 of the Southeast 1/4 of Section 21, Town 5 North, Range 21 East, in the City of Franklin, Milwaukee County, Wisconsin, bounded and described as follows:
	COMMENCING at the Northeast corner of said 1/4 Section; thence South 88°27'55" West along the North line of said 1/4 Section 887.30 feet to the point of beginning of lands to be described; thence South 01°32'35" East 516.00 feet to a point on the North line of Stonewood Addition No. 1 Subdivision; thence South 88°27'25" West along said North line 816.00 feet to a point; thence North 01°32'35" West 516.00 feet to a point on the North line of said 1/4 Section; thence North 88°27'25" East along said North line 816.00 feet to the point of beginning. Containing 421,056 square feet or 9.6661 acres.
SECTION 2:	The terms and provisions of this ordinance are severable. Should any term or provision of this ordinance be found to be invalid by a court of competent jurisdiction, the remaining terms and provisions shall remain in full force and effect.
SECTION 3:	All ordinances and parts of ordinances in contravention to this ordinance are hereby repealed.
SECTION 4:	This ordinance shall take effect and be in force from and after its passage and publication.
	at a regular meeting of the Common Council of the City of Franklin this, 2015, by Alderman
	adopted by a majority vote of the members-elect of the Common Counciling of the Common Council of the City of Franklin this day of


\_\_\_\_\_\_, 2015.

APPROVED:

Stephen R. Olson, Mayor

ORDINAN Page 3	ICE NO. 2015- <sub>-</sub>		
ATTEST:			
Sandra L. V	Wesolowski, Ci	ty Clerk	
AYES	NOES	ABSENT	

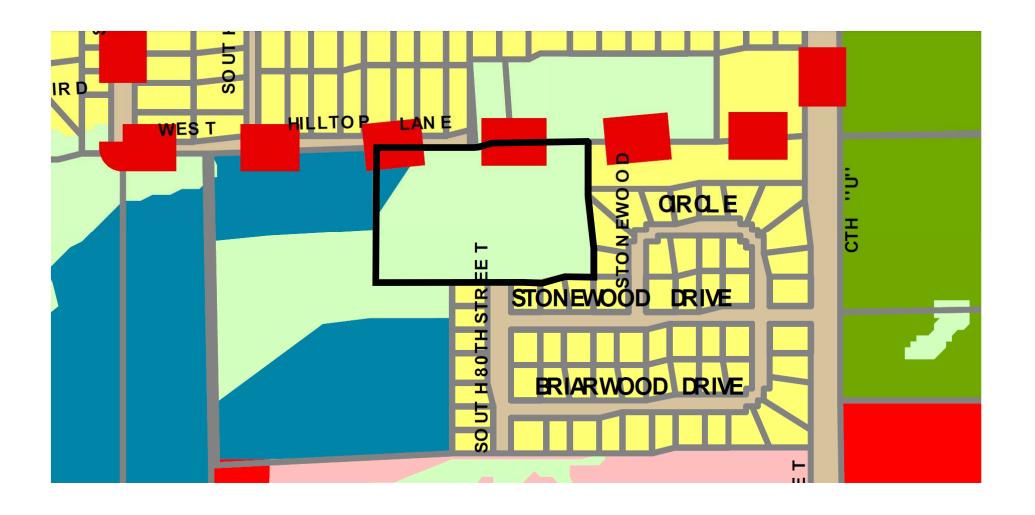

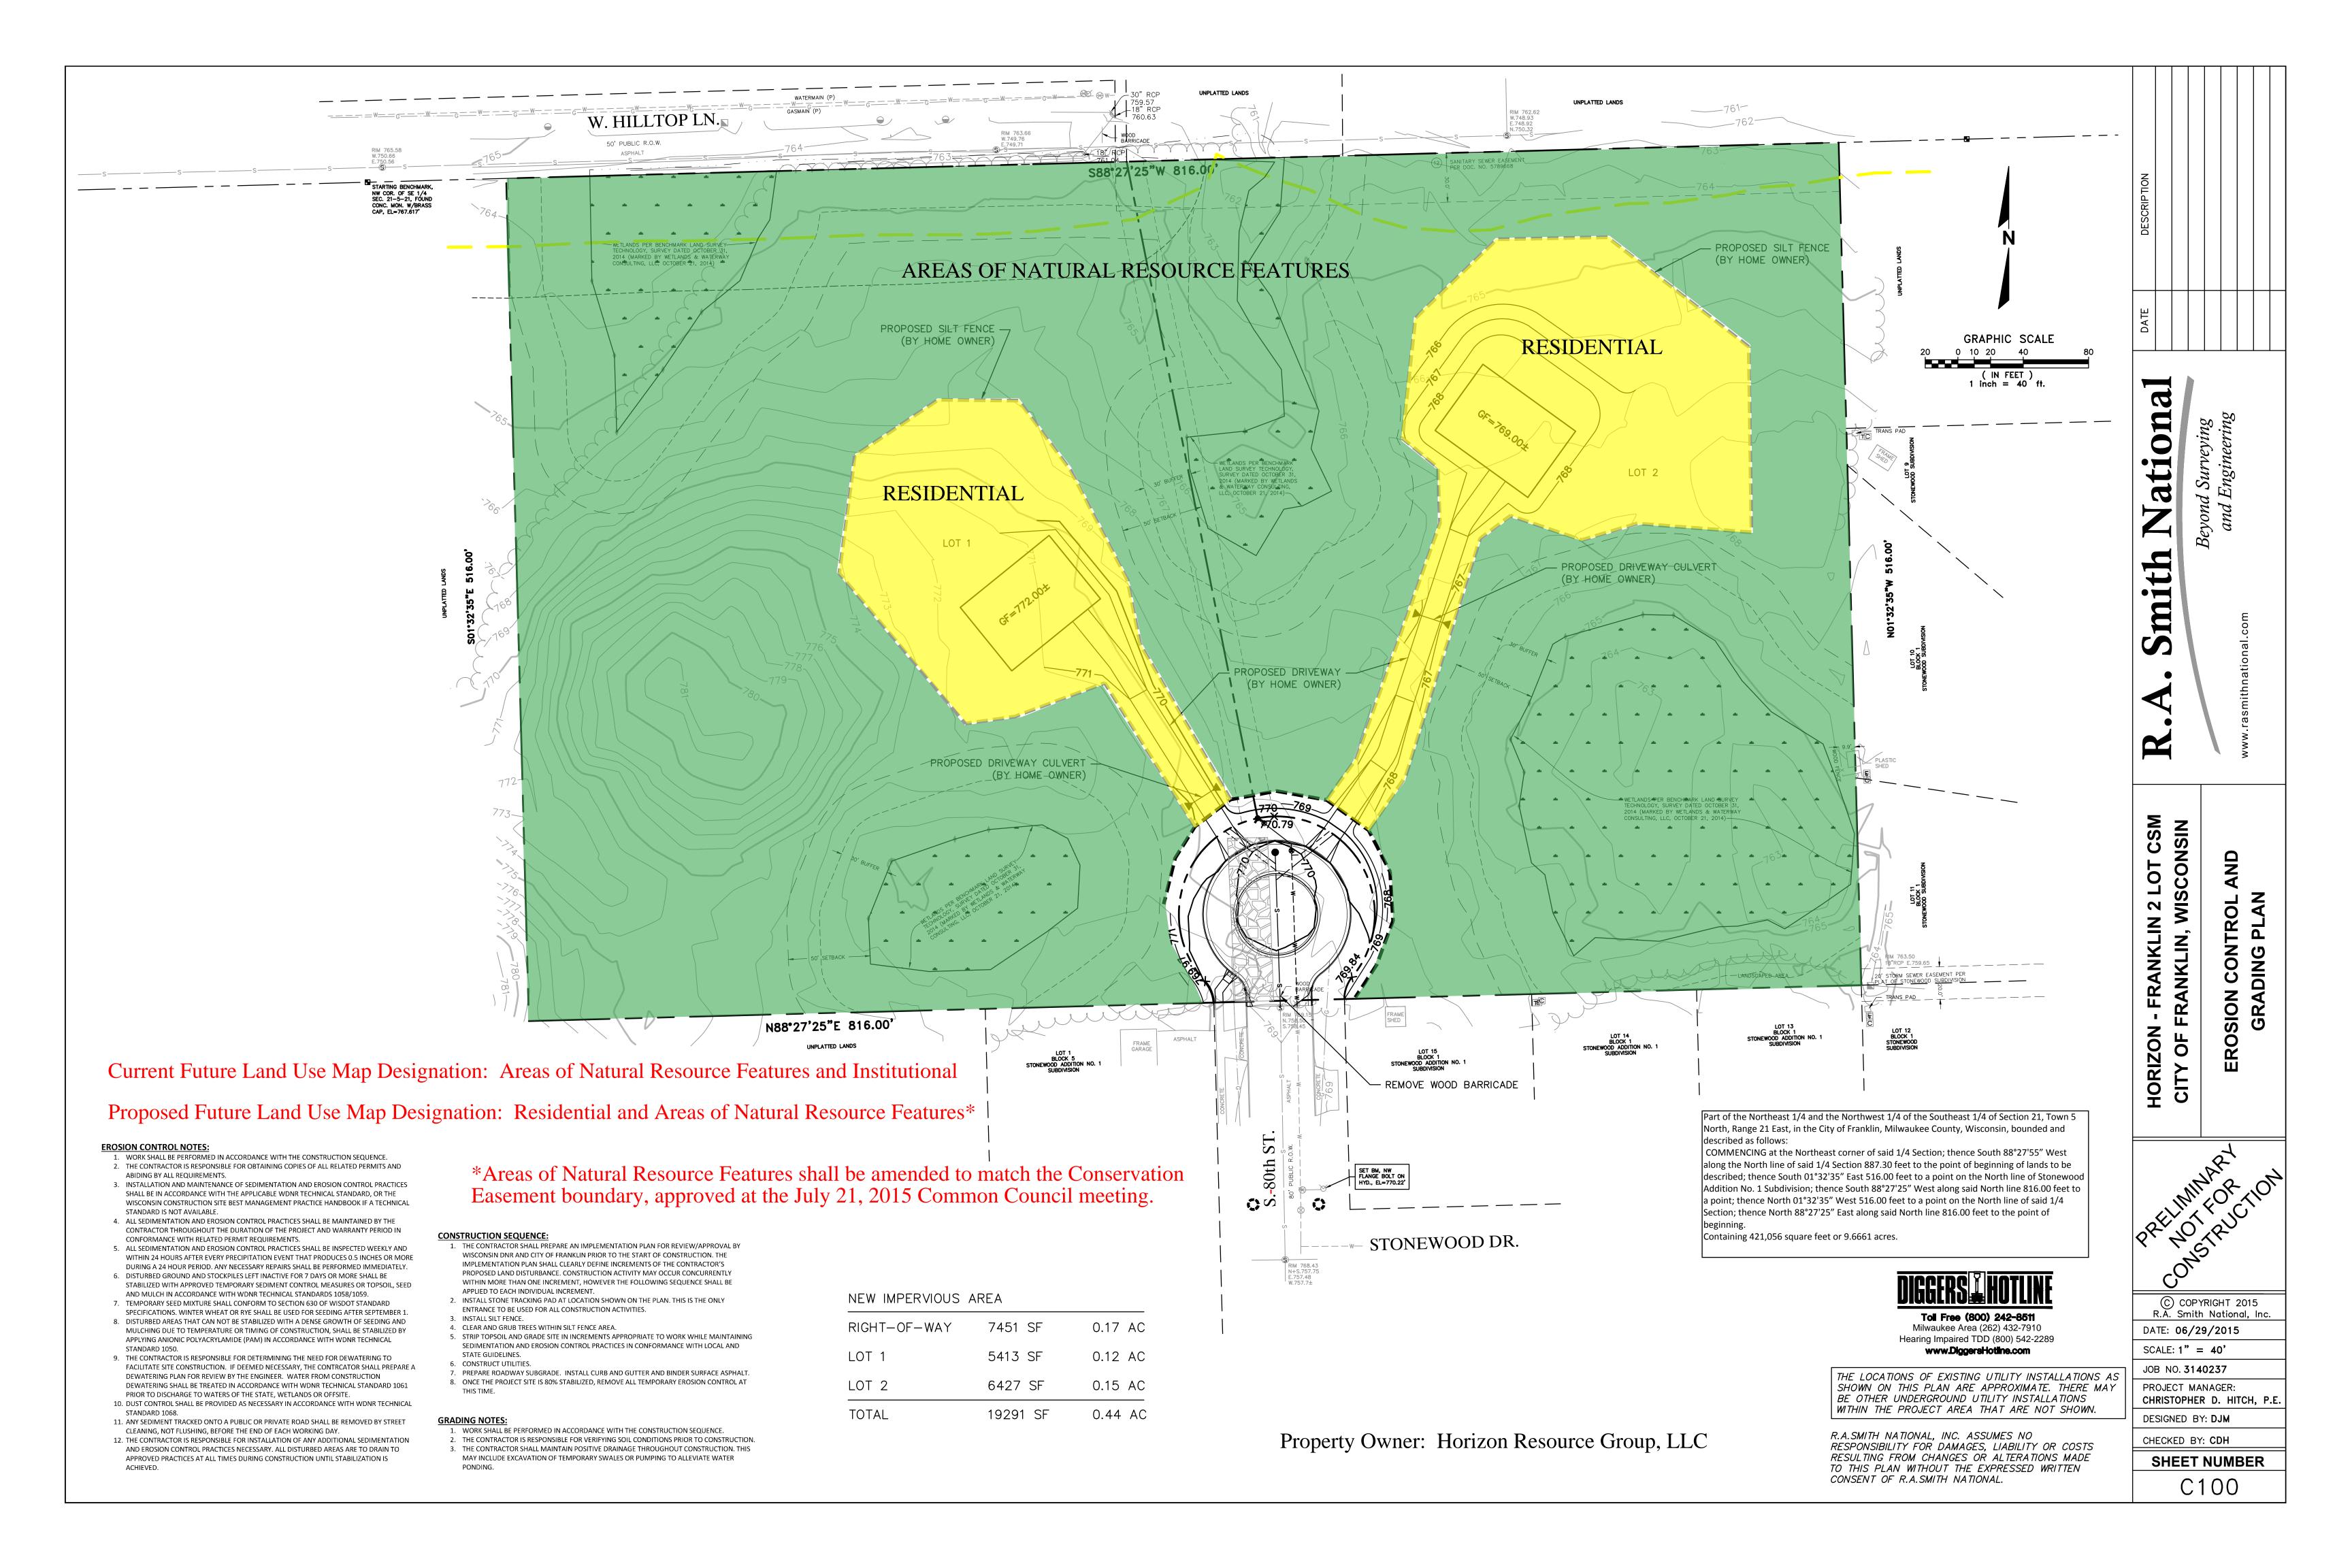


#### EXHIBIT A CONSERVATION EASEMENT

Part of the Northeast 1/4 and the Northwest 1/4 of the Southeast 1/4 of Section 21, Town 5 North, Range 21 East, in the City of Franklin, Milwaukee County, Wisconsin, bounded and described as follows:

Commencing at the Northeast corner of said 1/4 Section; thence South 88°27'55" West along the North line of said 1/4 Section 887.30 feet to the point of beginning of lands to be described; thence South 01°32'35" East 516.00 feet to a point on the North line of Stonewood Addition No. 1 Subdivision; thence South 88°27'25" West along said North line 306.52 feet to a point; thence Northeasterly 7.22 feet along the arc of a curve whose center lies to the Southeast, whose radius is 10.00 feet and whose chord bears North 19°11'02" East 7.07 feet to a point; thence Northeasterly 104.67 feet along the arc of a curve whose center lies to the Northwest, whose radius is 77.99 feet and whose chord bears North 03°24'51" East 96.99 feet to a point; thence North 33°41'14" East 37.75 feet to a point; thence North 17°50'24" East 154.02 feet to a point; thence North 52°45'09" East 19.36 feet to a point; thence South 71°45'39" East 47.25 feet to a point; thence North 73°37'04" East 33.81 feet to a point; thence South 86°20'04" East 71.80 feet to a point; thence North 00°40'40" West 116.89 feet to a point; thence North 52°05'14" West 111.02 feet to a point; thence South 88°14'51" West 69.99 feet to a point; thence South 46°51'19" West 70.01 feet to a point; thence South 05°24'14" West 76.96 feet to a point; thence South 49°22'52" East 28.14 feet to a point; thence South 02°06'43" East 33.65 feet to a point; thence South 19°43'32" West 151.95 feet to a point; thence South 36°56'49" West 27.69 feet to a point; thence Northwesterly 59.20 feet along the arc of a curve whose center lies to the South, whose radius is 102.51 feet and whose chord bears North 89°28'11" West 58.38 feet to a point; thence North 29°49'22" West 107.58 feet to a point; thence North 10°57'07" West 38.78 feet to a point; thence North 27°25'28" West 76.67 feet to a point; thence North 35°49'20" West 52.84 feet to a point; thence North 89°48'55" West 52.13 feet to a point; thence South 57°01'37" West 62.85 feet to a point; thence South 07°06'41" West 74.56 feet to a point; thence South 40°02'34" East 75.87 feet to a point; thence South 41°15'16" East 46.31 feet to a point; thence North 82°07'54" East 30.58 feet to a point; thence North 69°58'27" East 57.87 feet to a point; thence South 32°32'04" East 99.20 feet to a point; thence Southeasterly 112.14 feet along the arc of a curve whose center lies to the East, whose radius is 79.93 feet and whose chord bears South 00°52'19" East 103.17 feet to a point; thence Southeasterly 7.25 feet along the arc of a curve whose center lies to the Southwest, whose radius is 10.00 feet and whose chord bears South 22°10'01" East 7.09 feet to a point on the North line of said Subdivision; thence South 88°27'25" West along said North line 409.48 feet to a point; thence North 01°32'35" West 516.00 feet to a point on the North line of said 1/4 Section; thence North 88°27'25" East along said North line 816.00 feet to the point of

Containing 335,547 square feet or 7.7031 acres.

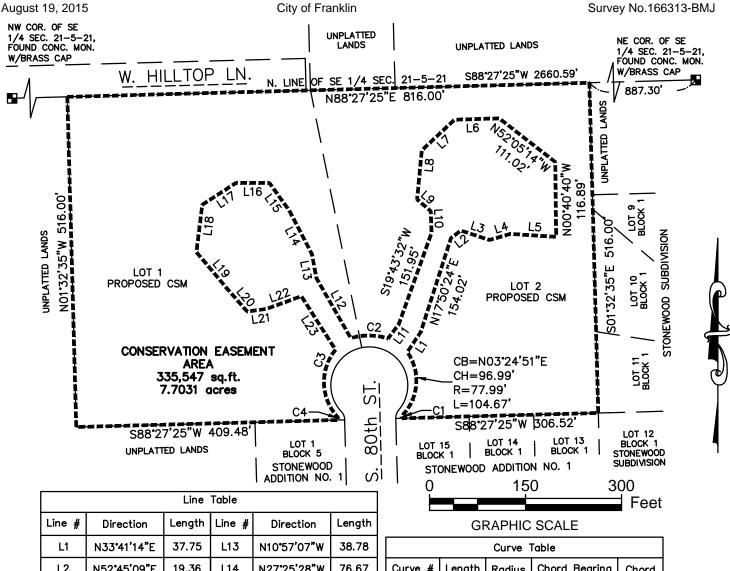

		Line	lable		
Line #	Direction	Length	Line #	Direction	Length
L1	N33°41'14"E	37.75	L13	N10°57'07"W	38.78
L2	N52°45'09"E	19.36	L14	N27°25'28"W	76.67
L3	S71°45'39"E	47.25	L15	N35°49'20"W	52.84
L4	N73°37'04"E	33.81	L16	N89°48'55"W	52.13
L5	S86°20'04"E	71.80	L17	S57°01'37"W	62.85
L6	S8814'51"W	69.99	L18	S7°06'41"W	74.56
L7	S46°51'19"W	70.01	L19	S40°02'34"E	75.87
L8	S5°24'14"W	76.96	L20	S41°15'16"E	46.31
L9	S49°22'52"E	28.14	L21	N82°07'54"E	30.58
L10	S2°06'43"E	33.65	L22	N69*58'27"E	57.87
L11	S36°56'49"W	27.69	L23	S32*32'04"E	99.20
L12	N29°49'22"W	107.58			

#### Chord Bearing Curve # Length Radius Chord C1 7.22 10.00 N19"11'02"E 7.07 C2 59.20 102.51 N89°28'11"W 58.38 **C3** 112.14 79.93 103.17 S0°52'19"E 7.09 7.25 10.00 S2210'01"E C4

#### R.A. Smith National, Inc.

Beyond Surveying and Engineering

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SHEET 1 OF 1 EX211L15.dwg\SHEET 1



#### **Conservation Easement**

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