

SALES & SERVICE BLDG.



ABBREVIATIONS

AB	ANCHOR BOLT	DW	DISHWASHER	IHM	INSULATED HOLLOW METAL	REINF	REINFORCE
AC	AIR CONDITIONING	EA	EACH	INSUL	INSULATION	RO	ROUGH OPENING
ACT	ACOUSTIC CEILING TILE	EXST	EXISTING	INT	INTERIOR	Sŧ∨	STAIN & VARNISH
ACWD	ALUMINUM CLAD WOOD DOOR	EIFS	EXTERIOR INSULATION FINISH SYSTEM	JNT	JOINT	SC	SOLID CORE
ADJ	ADJUSTABLE / ADJACENT	EXP	EXPANSION or EXPOSED	JST	JOIST	SECT	SECTION
AFF	ABOVE FINISH FLOOR	ELECT	ELECTRICAL	LAM	LAMINATE	SF <i>o</i> r #	SQUARE FEET
ALUM	ALUMINUM	ELEY	ELEVATION	LAY	LAVATORY	SIM	SIMILAR
ALT	ALTERNATE	EQUIP	EQUIPMENT	MAT'L	MATERIAL	SPEC	SPECIFICATION
APPROX	APPROXIMATE	EQUIV	EQUIVALENT	MAX	MAXIMUM	STL	STEEL
ARCH	ARCHITECTURAL	ETR	EXISTING TO REMAIN	MECH	MECHANICAL	STN	STAIN
a	ΑŤ	EXT	EXTERIOR	MED	MEDIUM	STOR	STORAGE
BD	BOARD	EW	EACH WAY	MFG	MANUFACTURER	STRUCT	STRUCTURAL
BI	BUILT-IN	FD	FLOOR DRAIN	MIN	MINIMUM	SV	SHEET VINYL
BLDG	BUILDING	Ħ	FINISH FLOOR	MISC	MISCELLANEOUS	SW	STRIP WOOD
BOT	BOTTOM	FIN	FINISH	MO	MASONRY OPENING	TBD	TO BE DETERMINED
B/0	BOTTOM OF	FIXT	FIXTURE	MTL	METAL	T4B	TOP & BOTTOM
BRG	BEARING	FLR	FLOOR	MW	MICROWAVE	T/O	TOP OF
BRG PL	BEARING PLATE	FDN	FOUNDATION	NIC	NOT IN CONTRACT	TEL	TELEPHONE
CPT	CARPET	FO	FACE OF	NO	NUMBER	T\$G	TONGUE & GROOVE
CABT	CABINET	FS	FLOOR SEAL	NOM	NOMINAL	TJI	TRUSS JOIST
CJ	CONSTRUCTION JOINTS	FTG	FOOTING	NTS	NOT TO SCALE	TOP	TOP OF PLATE
¢.	CENTER LINE	FURN	FURNACE	OA	OVER ALL	TYP	TYPICAL
CLG	CEILNG	GA	GAUGE	oc	ON CENTER	uc	UNDER COUNTER
CLO	CL06ET	GALV	GALVANIZED	OHD	OVERHEAD DOOR	UON	UNLESS OTHERWISE NOTE
CMU	CONCRETE MASONRY UNIT	GLU-LAM	GLUE LAMINATED BEAM	<i>o</i> PT	OPTIONAL	VΒ	COVED VINYL BASE
COL	COLUMN	GT	GROUT	PERF	PERFORATED	VCT	VINYL COMPOSITION TILE
CONC	CONCRETE	GWB	GYPSUM WALL BOARD	#E	PLATE	VERT	VERTICAL
CONST	CONSTRUCTION	H	HARDWARE	PLAM	PLASTIC LAMINATE	VIF	VERIFY IN FIELD
CONT	CONTINUOUS	HC	HOLLOW CORE	PLYWD	PLYWOOD	VIIIC	VINYL WALL BASE
CT	CERAMIC TILE	HD	HEAD	PREFIN	PREFINISHED	W/	WITH
CTB	CERAMIC TILE BASE	HDR	HEADER	PSF	POUNDS PER SQUARE FOOT	WB	WOOD BASE
DEMO	DEMOLITION	HT	HEIGHT	PSI	POUNDS PER SQUARE INCH	WIC	WALK-IN CLOSET
DIA ¢	DIAMETER	HM	HOLLOW METAL	PŤ	PAINT	WD	WOOD
DIM	DIMENSION	HORZ	HORIZONTAL	PVC	POLYVINYLCHLORIDE	WDO	MINDOM
DIV	DIVISION	HR	HOUR	R/T	REFER TO	W/O	WITHOUT
DWGS	DRAWINGS	HTG	HEATING	R4S	ROD & SHELF	ШP	WATERPROOF
DS DS	DOWNSPOUT	HVAC	HEAT, VENTILATE, AIR CONDITIONING	REC	RECESSED	шшF	WELDED WIRE FABRIC

A		П		П	A				
\boldsymbol{A}	K		(()	- 1	\boldsymbol{A}		I	The same of the sa	
/ 1	11.7		W .		/ \	1 1			

OWNER:

Hiller Ford, Inc 6455 South 108 Street Franklin, Wisconsin 53132 Tele: (414) 425-1000 Contact: Jay Hiller

ARCHITECT:

Perspective Design, Inc. 11525 W. North Avenue Wauwatosa, WI 53226 Tele: (414) 302-1780 x 201 Contact: William H. Conine E-Mail: bconine@pdi-arch.com

GENERAL CONTRACTOR/ CONSTRUCTION MANAGER:

Mark Carstensen Developments, LLC. 9130 W. Loomis Road - Suite 950 Franklin, WI 53132 Tele: (414) 235-3571 Fax: (414) 235-3572 Contact: Mark Carstensen E-Mail: mark@meccd.com

CIVIL ENGINEER: ELECTRICAL ENG./DESIGN BUILD:

JSD Professional Services, Inc. T.B.D. N22 W22931 Nancy Court - Suite #3 Waukesha, WI 53186 Tele: (262) 513-0666 Fax: (262) 513-1232 Contact: Justin L. Johnson E-Mail: justin.johnson@jsdinc.com

STRUCTURAL ENGINEER: PLUMBING ENG./DESIGN BUILD:

Pierce Engineers 241 N. Broadway, #500 Milwaukee, WI 53202 Tele: (414) 278-6020 Fax: (414) 278-6061 Contact: Randy Elliott E-mail: rseapierceengineers.com

MECHANICAL ENG./DESIGN BUILD: FIRE PROTECTION DESIGN BUILD:

DRAWING INDEX | CODE REFERENCE

ARC	I II I LC I ONAL.	SUBJECT TO THE MODIFICATION SPECIFIED BY WI DEPTMARTMENT OF SAFETY & PROFESSIONAL SERVICES, CHAPTER 361-366	
<u>†1</u>	TITLE SHEET	INTERNATIONAL BUILDING CODE - 2009	
''		INTERNATIONAL ENERGY CONSERVATION CODE - 2009	
		COMCHECK: 3.9.03 • INTERNATIONAL MECHANICAL CODE - 2009	
		INTERNATIONAL FUEL GAS CODE - 2009	
A1.1	DIMENSIONED FLOOR PLAN	INTERNATIONAL EXISTING BUILDING CODE - 2009	
' ' ' ' ' '		ACCESSIBILITY CODES:	
		INTERNATIONAL BUILDING CODE- 2009, CHAPTER II	
		ICC/ANSI AIIT.I - 2003 D.O.J 2010 ADA STANDARDS FOR ACCESSIBLE DESIGN	
		DOJ 2010 ADA STANDARDS FOR ACCESSIBLE DESIGN MECHANICAL CODE:	l (=
1 1 ts	DOOF DI ANI	REFER TO WI COMMERCIAL BUILDING CODE	$\parallel \parallel \parallel$
A1.5	ROOF PLAN	ELECTRICAL CODE:	$\parallel \parallel \parallel$
A2.1	BUILDING ELEVATIONS	INTERNATIONAL BUILDING CODE - 2009, CHAPTER 21	$\parallel \parallel \parallel$
A2.2	BUILDING ELEVATIONS WITH COLOR	WI SAFETY & PROFESSIONAL SERVICES, CHAPTER 316	$\parallel \parallel \parallel$
74.6		REF. NATIONAL ELECTRIC CODE, NATIONAL ELECTRIC CODE (NEC) - 2008	$\parallel \parallel \parallel$
		SUBJECT TO THE CHANGES.	$\parallel \parallel \parallel$
		ADDITIONS OR OMISSIONS SPECIFIED	$\parallel \parallel \parallel$
		IN SUB CH. III. OF CHAPTER 316	$\parallel \parallel \parallel$
		PLUMBING CODE:	$\parallel \parallel \parallel$
		INTERNATIONAL BUILDING CODE - 2009, CHAPTER 29	$\parallel \parallel \parallel$
		WI SAFETY & PROFESSIONAL SERVICES, CHAPTER 381-381 FIRE PREVENTION:	$\parallel \parallel \parallel$
		WI SAFETY & PROFESSIONAL SERVICES, CHAPTER 314	$\parallel \parallel \parallel$
		REFERENCE NFPA	$\parallel \parallel \parallel$
		NFPA I, FIRE CODE - 2009 AND/OR LOCAL FIRE ORDINANCE IF APPLICABLE	$\parallel \parallel \parallel$
		SUBJECT TO THE MODIFICATIONS	$\parallel \parallel \parallel$
		AS SPECIFIED IN CHAPTER 314	$\parallel \parallel \parallel$
		CIVIL ENGINEER: CIVIL ENGINEER IS RESPONSIBLE FOR ALL FEDERAL. STATE AND LOCAL CODES	$\parallel \parallel \parallel$
		RELATED TO STORM WATER MANAGEMENT, EROSION CONTROL, SOIL DISTURBANCE,	$\parallel \parallel \parallel$
		AND NATURAL RESOURCE PROTECTION.	
		EMEDOENCY ECDEGG LIGHTING	
		EMERGENCY EGRESS LIGHTING: -THESE DOCUMENTS DENOTE AN EGRESS PLAN SHOWING THE PATH WHERE EXIT	
		LIGHTS & EMERGENCY EGRESS LIGHTING MAY BE REQUIRED.	
		- FOR NEW BUILDINGS, ADDITIONS OR ALTERATIONS THAT CREATE NEW EGRESS	
		PATHS, THE ELECTRICAL DESIGNER SHALL PROVIDE, AT THE PROJECT SITE DURING	
		CONSTRUCTION, EMERGENCY LIGHTING CUT-SHEETS, CALCULATIONS, PHOTOMETERICS	
CTD	ICTUD AL	OR OTHER MEANS TO SHOW COMPLIANCE WITH APPLICABLE CODES.	
			1 11

STRUCTURAL:

ARCHITECTURAL:

ELECTRICAL DESIGNER SHALL PREPARE A LIGHTING PLAN AND PROVIDE, AT THE PROJECT SITE DURING CONSTRUCTION, LIGHTING PLANS AS WELL AS FIXTURE T.B.D. CUT-SHEETS AND ENERGY CALCULATIONS TO SHOW COMPLIANCE WITH THE ENERGY ACCESSIBILITY NOTES:
-THIS PROJECT INCLUDES AN ALTERATION TO AN AREA OF PRIMARY FUNCTION. AS

DENOTED IN THESE DOCUMENTS, ACCESSIBILITY UPGRADES ARE BEING PROVIDED TO THE ACCESSIBLE ROUTE, INCLUDING TOILET AND DRINKING FACILITIES, AS REQUIRED BY THE EXISTING BUILDING CODE. THESE UPGRADES ARE LIMITED TO BUILDING DATA

PROJECT DESCRIPTION TYPE OF WORK BUILDING CODE CLASS: **MECHANICAL:** <u>AREA OF WORK</u> USE & OCCUPANCY: 5-1 (Motor Vehicle Repair) ACCESSORY OCCUPANCY: T.B.D. GENERAL BUILDING DATA: <u>ACTUAL:</u> 24'-0" APPROX HEIGHT: PROPOSED NEW GROSS AREA EXISTING BLDG: 48,967 SF 38,216 SF. 6,914 SF. DEMO AREA WITH CANOPY BLDG ADDITION (Front) BLDG ADDITION (Rear) % OF WORK AREA **ELECTRICAL:** 2 - (UNMODIFIED) NUMBER OF FLOORS: TYPE OF CONSTRUCTION: 2 - (UNMODIFIED) 2-B (METAL FRAME - UNPROTECTED) T.B.D. FIRE RESISTANCE RATED CONST.: NOT REQUIRED

FIRE PROTECTION SYSTEMS AUTOMATIC SPRINKLER:

AUTOMATIC SPRINKLER:

PLUMBING:	CLASS: NFPA STANDARD: FIRE ALARM & DETECTION:	AUTOMATIC NFPA 13 FULL AUTOMATIC FULL AUTOMATIC	
T.B.D.	MONITOR TYPE: SMOKE ALARM & DETECTION: MONITOR TYPE:		
	MEANS OF EGRESS IN AREA OF U. OCCUPANT LOAD:		
	EGRESS WIDTH:	T.B.D.	


	EXIT TRAVEL DISTANCE: PLUMBING SYSTEMS: MENS:	1.5.D. 250'-0" MAX † REQUIRED
PROTECTION:	WATERCLOGETS: URINAL LAYATORIES	
),	WOMENS: WATERCLOSETS LAVATORIES: DRINKING FOUNTAINS:	T.B.D. T.B.D. T.B.D.

BOTTLED WATER SHALL BE SUPPLIED FREE OF CHARGE FOR ALL OCCUPANTS. OTHER - SERVICE/PREP SINKS: T.B.D.

FULL - ENTIRE STRUCTURE

AUTOMATIC

AUTOMATIC FULL AUTOMATIC

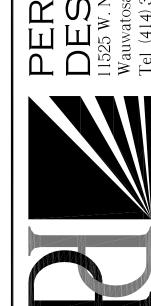



03/09/15 Scale: Job: 14-124

Sheet:

Project: Hiller THESE

Drawing Title: DIMENSIONED FLOOR PLAN

THIS BOX IS ½" x ½" Date: 03/09/15 Scale: A.N. Drawn:

14-124 **A1.1**

NOT USED SCALE: 1/16" = 1'-0" 60'-0" 90'-9 3/8" 97'-5 1/2" 64'-Ø" PERIMETER LINE OF EXISTING BLDG. 5 4 A2.l 64'-0" 360'-0" 35'-1" PLAN NORTH DIMENSIONED FLOOR PLAN
SCALE: 1" = 20'-0"

- PRELIMINARY -ESTIMATING AND REVIEW FOR

THIS BOX IS


A.N.

WHC

14-124

A1.5

SCALE: 1" = 20'-0"

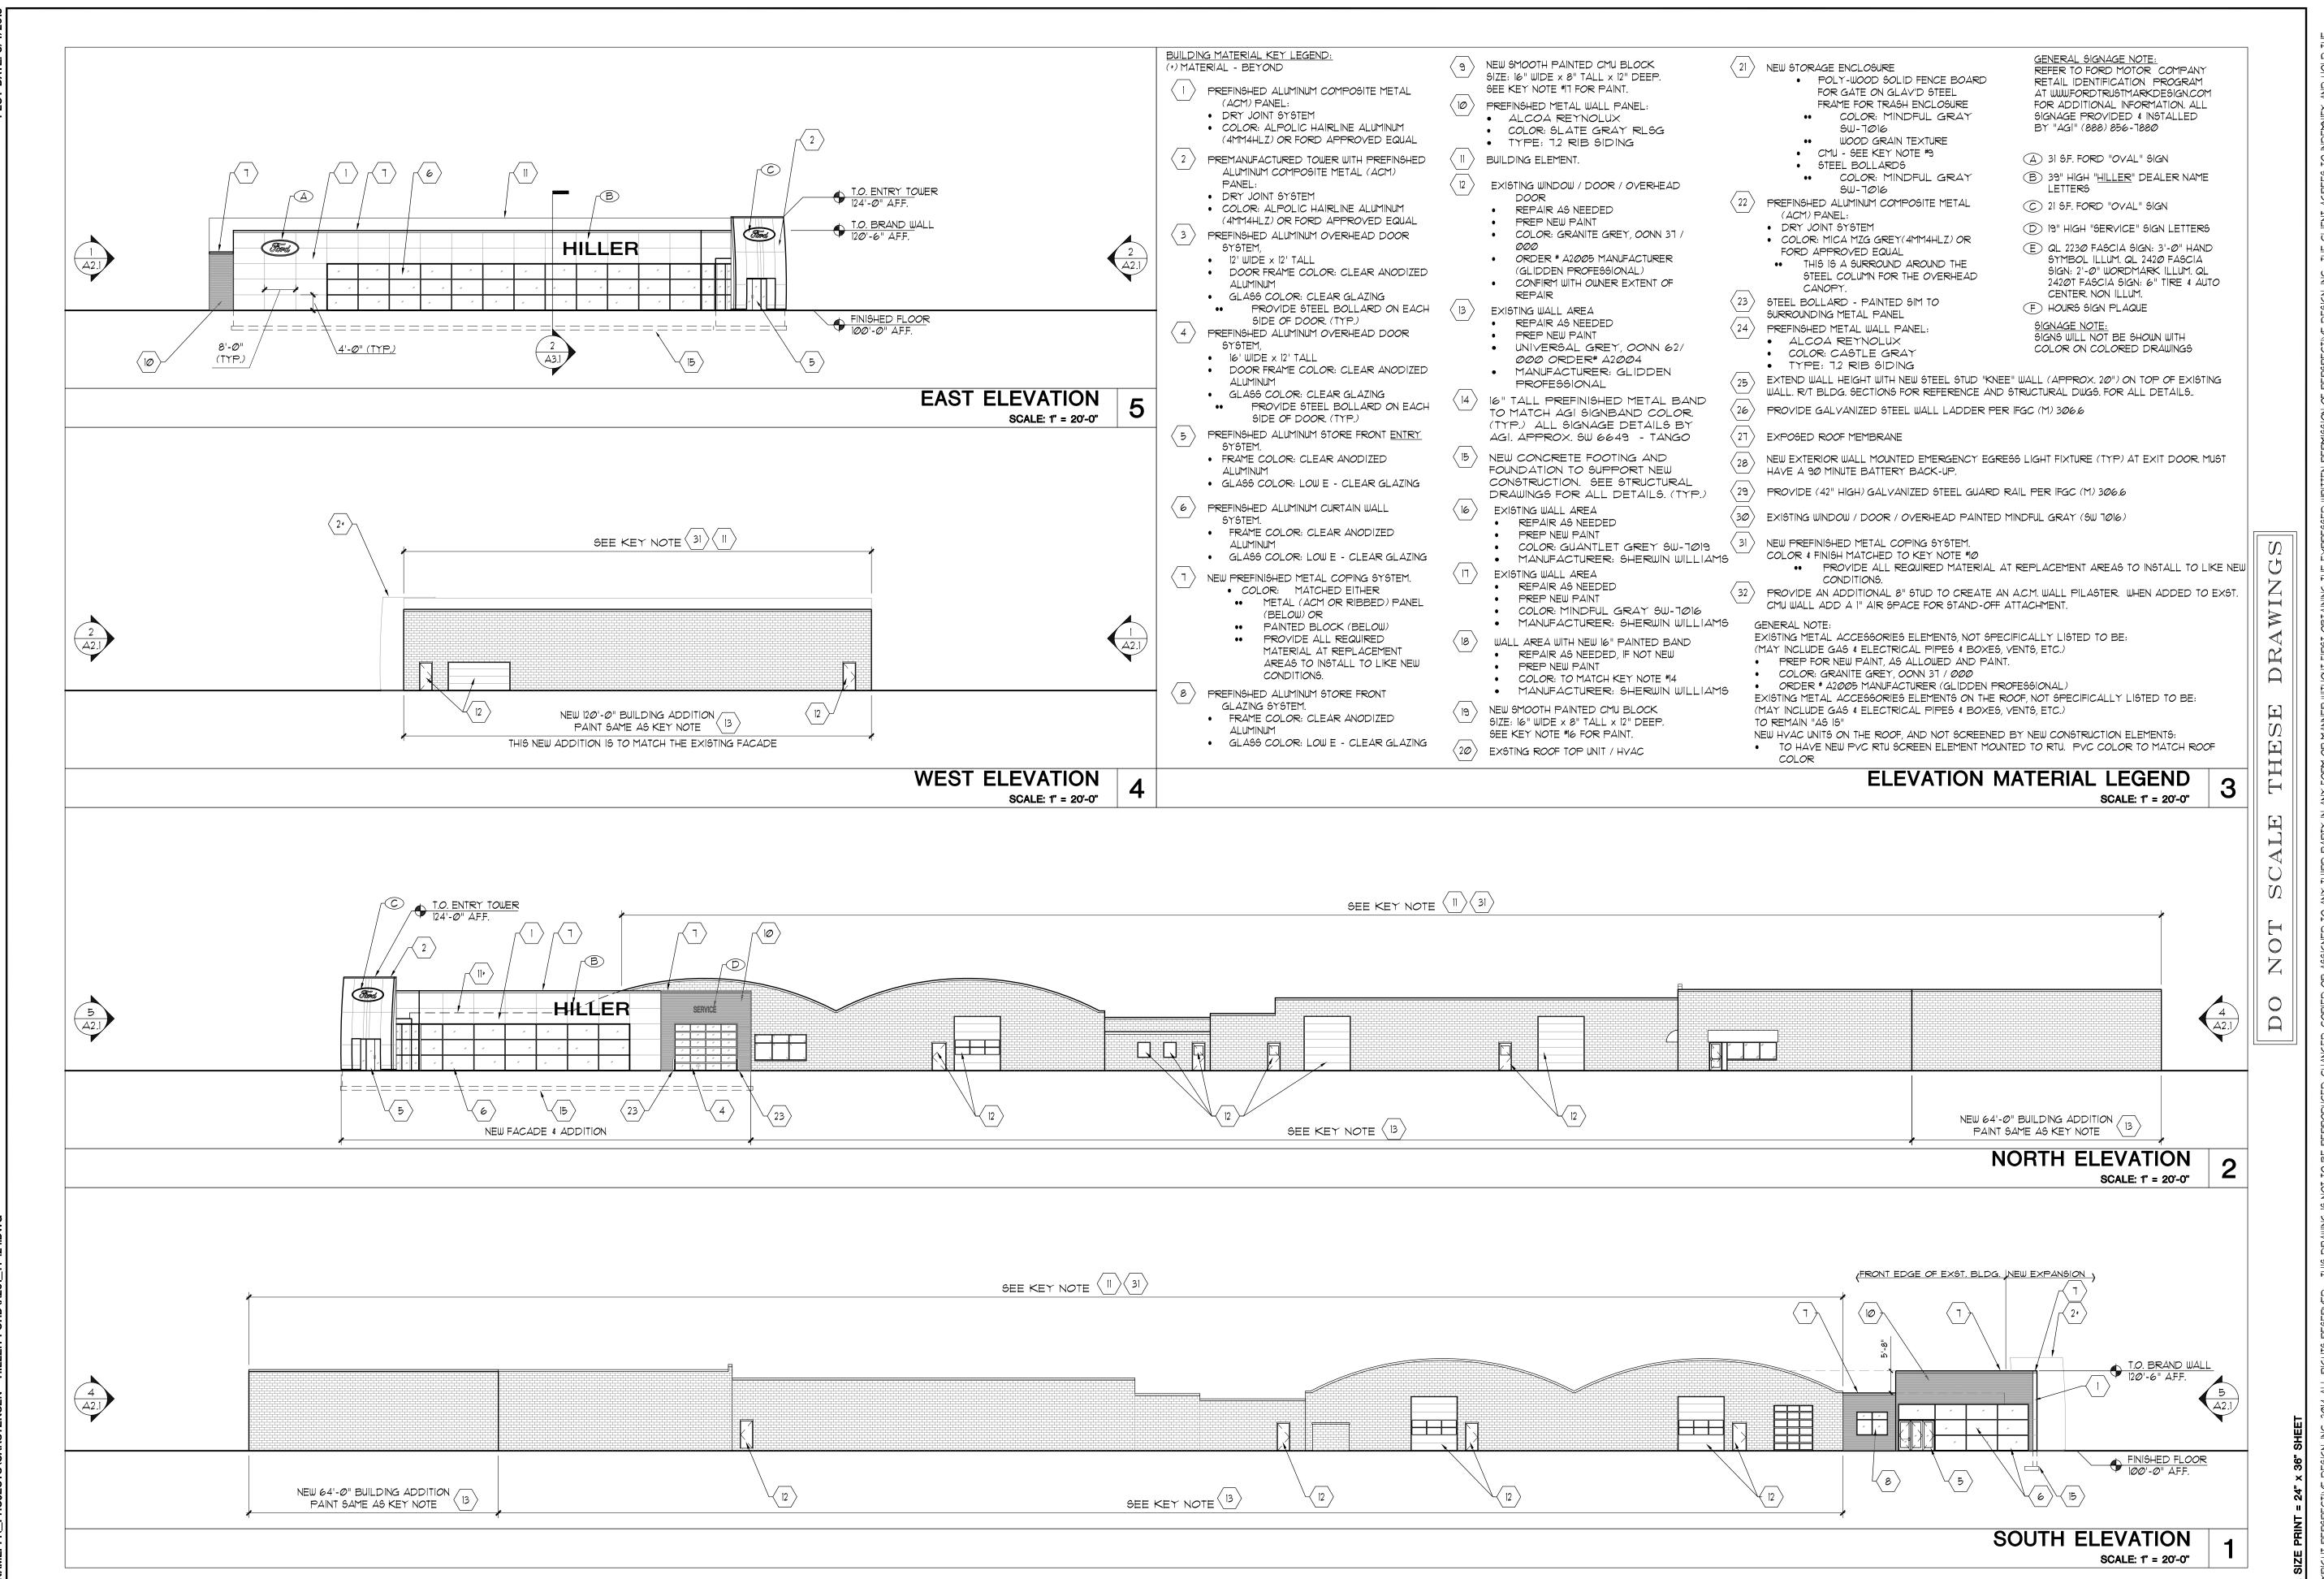


벌 Project: ord **Drawing Title:** Building Elevations Scale: Job:

1/2" x 1/2"

14-124

A2.1


03/09/15

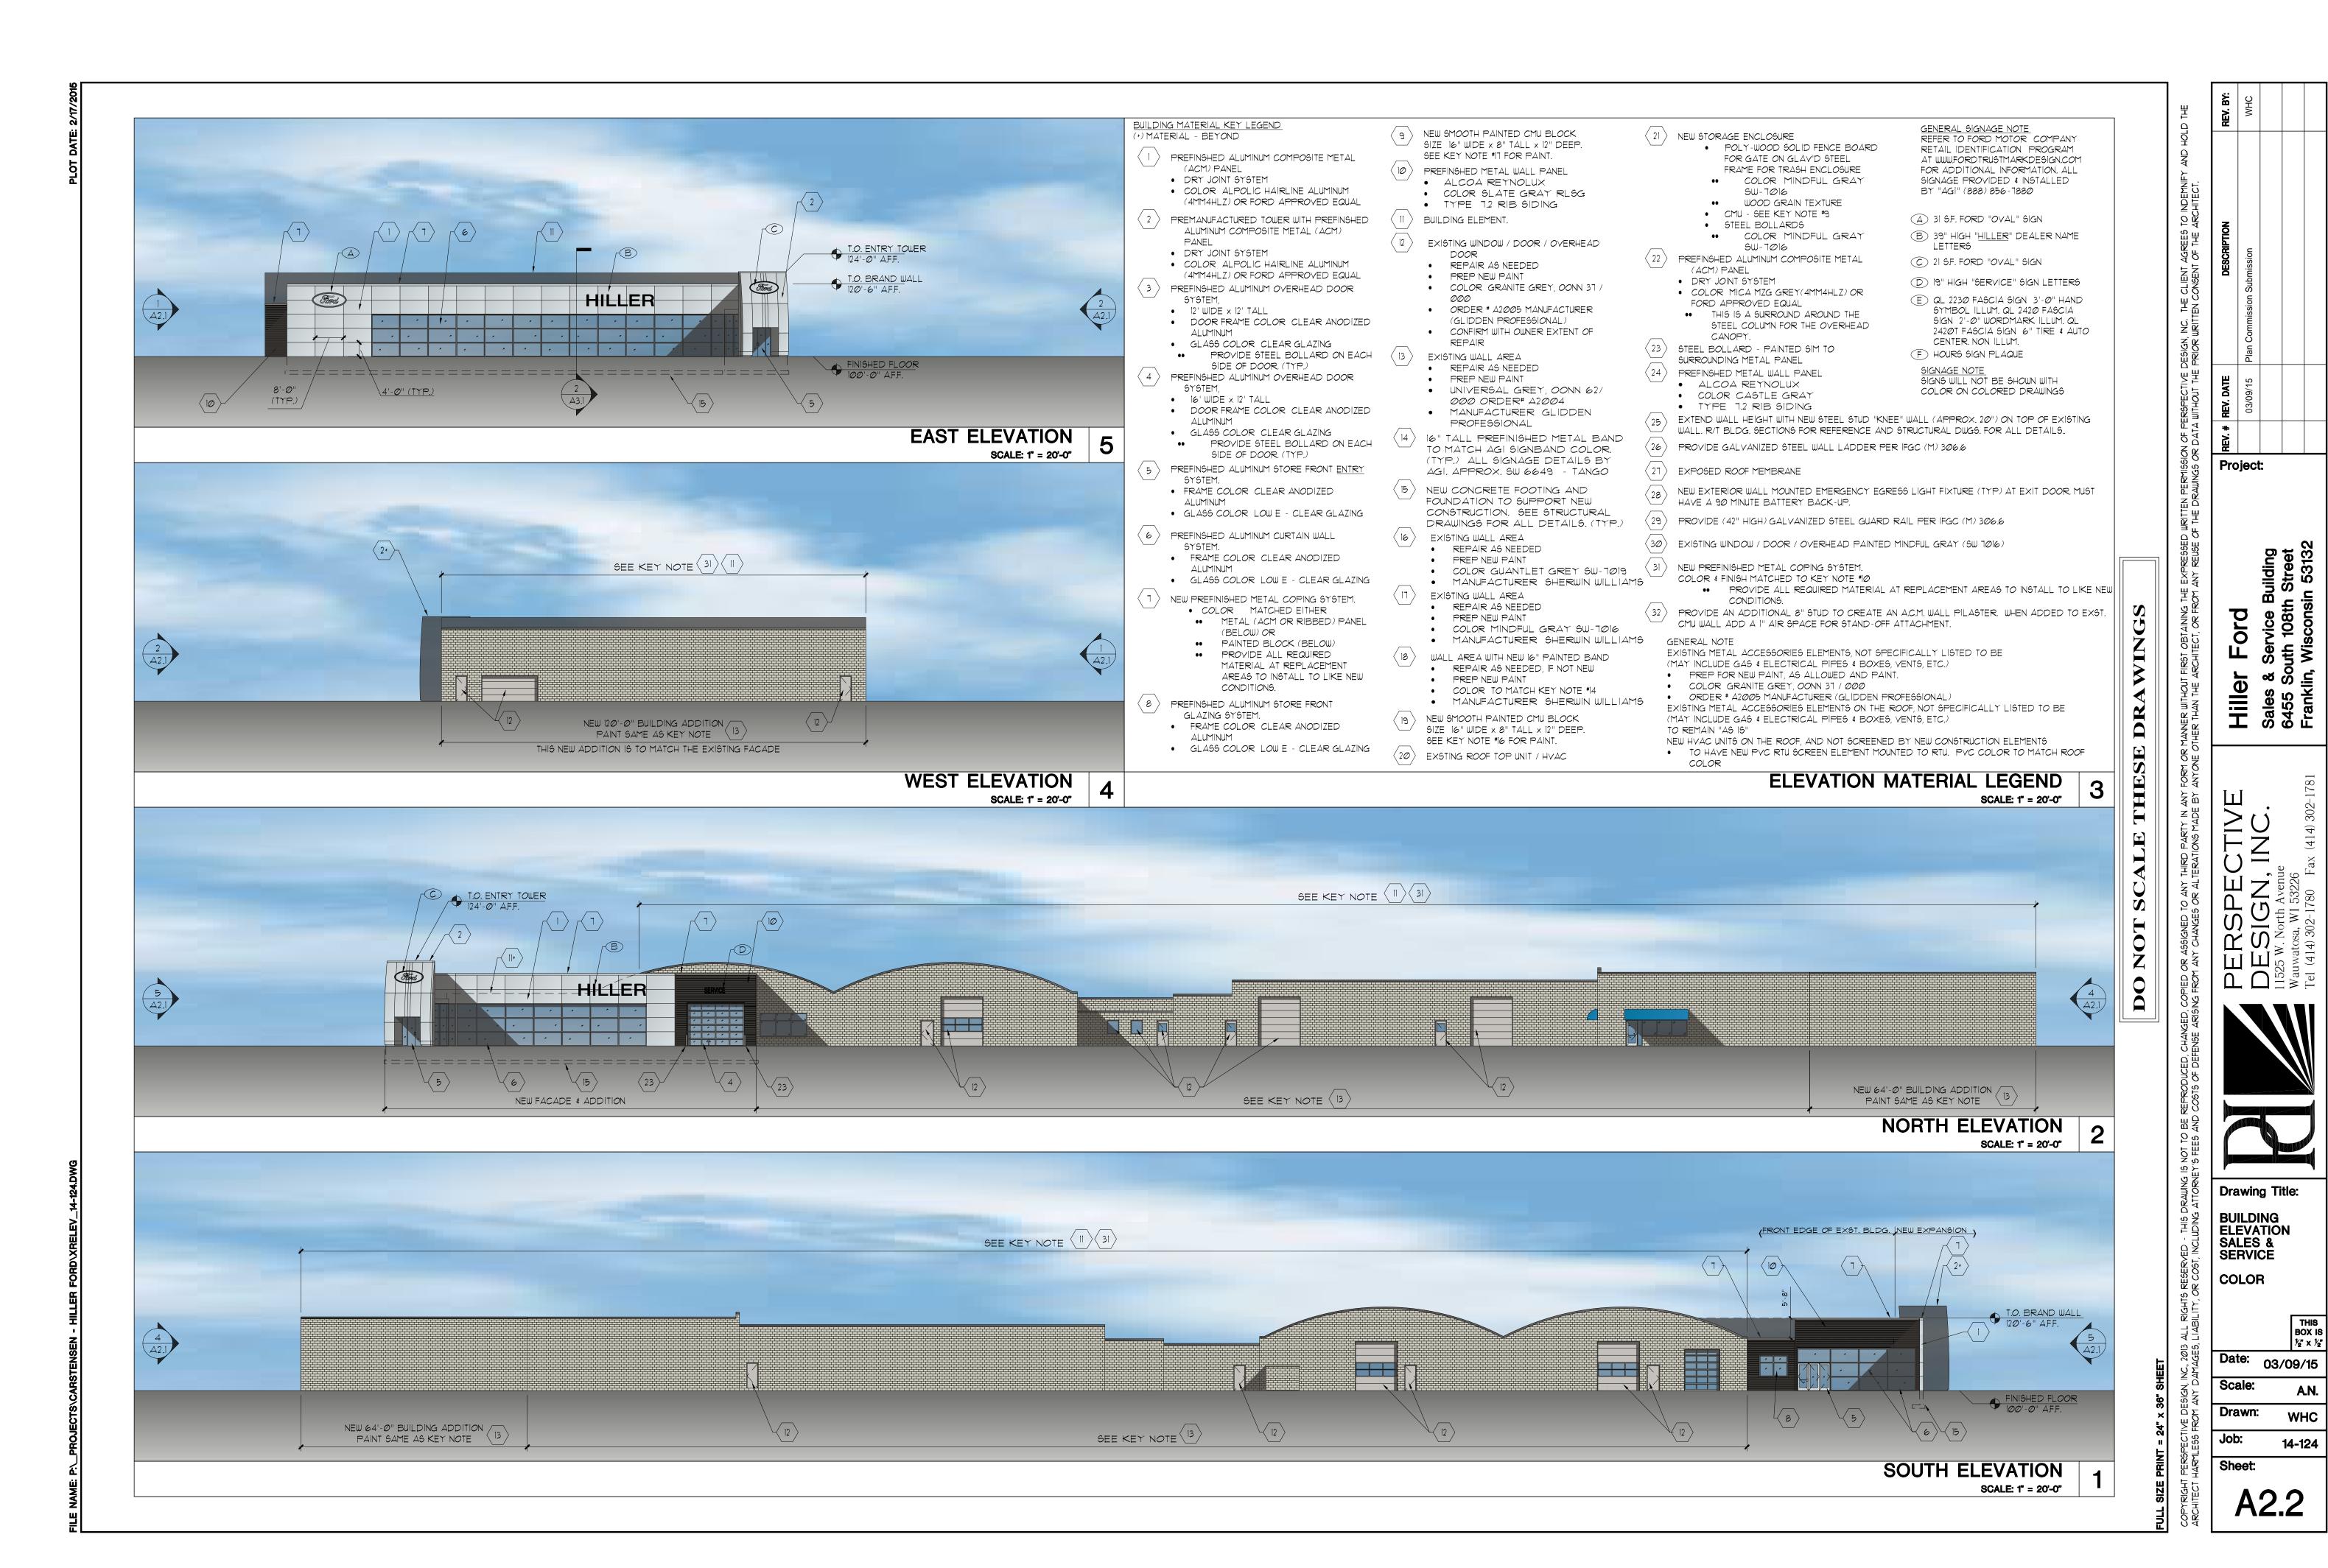

Hiller Ford - Quick Lane Blds.

6455 South 108th Street Franklin, Wisconsin 53132 (Milwaukee County)

VICINITY MAP

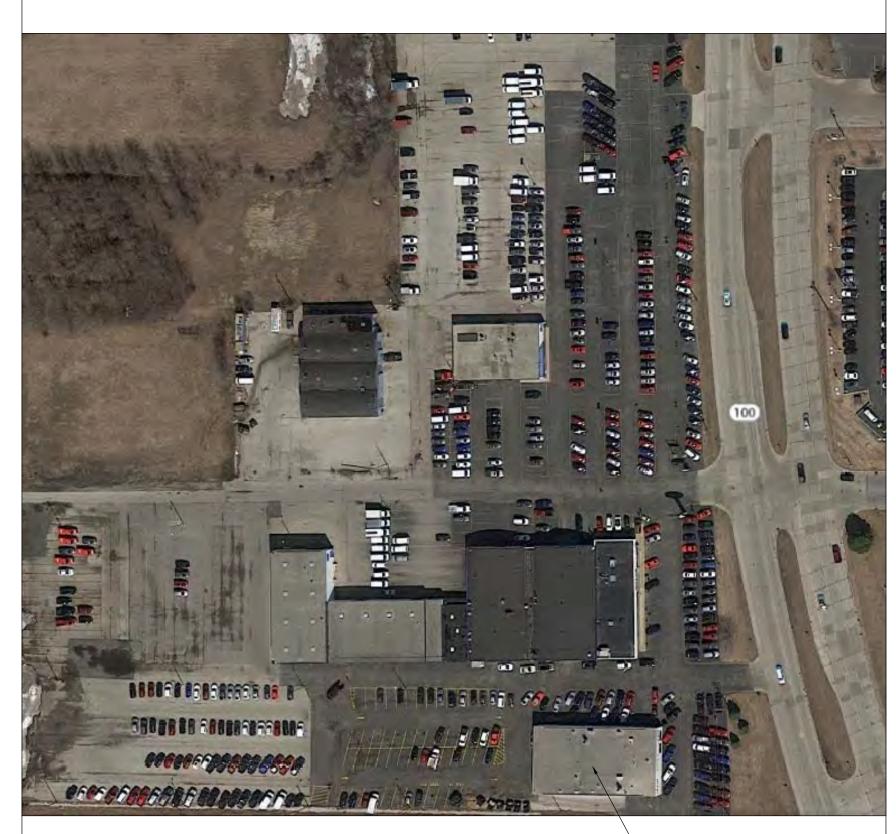

PLAN NORTH

ABBREVIATIONS

AB	ANCHOR BOLT	DW	DISHWASHER	IHM	INSULATED HOLLOW METAL	REINF	REINFORCE
AC	AIR CONDITIONING	EA	EACH	INSUL	INSULATION	RO	ROUGH OPENING
ACT	ACOUSTIC CEILING TILE	EXST	EXISTING	INT	INTERIOR	SŧV	STAIN & VARNISH
4CWD	ALUMINUM CLAD WOOD DOOR	EIFS	EXTERIOR INSULATION FINISH SYSTEM	JNT	JOINT	SC	SOLID CORE
4DJ	ADJUSTABLE / ADJACENT	EXP	EXPANSION or EXPOSED	JST	JOIST	SECT	SECTION
AFF	ABOVE FINISH FLOOR	ELECT	ELECTRICAL	L <i>A</i> M	LAMINATE		SQUARE FEET
ALUM	ALUMINUM	ELEY	ELEVATION	LAV	LAVATORY	SIM	SIMILAR
ALT	ALTERNATE	EQUIP	EQUIPMENT	MAT'L	MATERIAL	SPEC	SPECIFICATION
APPROX	APPROXIMATE	EQUIY	EQUIVALENT	MAX	MAXIMUM	STL	STEEL
ARCH	ARCHITECTURAL	ETR	EXISTING TO REMAIN	MECH	MECHANICAL	STN	STAIN
9	AT	EXT	EXTERIOR	MED	MEDIUM	STOR	STORAGE
- 3D	BOARD	EW	EACH WAY	MEG	MANUFACTURER		STRUCTURAL
31	BUILT-IN	FD FD	FLOOR DRAIN	MIN	MINIMUM	SY	SHEET VINYL
SLDG	BUILDING	F	FINISH FLOOR	MISC	MISCELLANEOUS	SW	STRIP WOOD
30T	BOTTOM	FIN	FINISH	MO	MASONRY OPENING	TBD	TO BE DETERMINED
3/ 0	BOTTOM OF	FIXT	FIXTURE	MTL	METAL	T4B	TOP & BOTTOM
BRG	BEARING	FLR	FLOOR	MW	MICROWAVE	T/O	TOP OF
SRGPL	BEARING PLATE	FDN	FOUNDATION	NIC	NOT IN CONTRACT	TEL	TELEPHONE
SPT	CARPET	FO	FACE OF	NO	NUMBER	TéG	TONGUE & GROOVE
SABT	CABINET	F6	FLOOR SEAL	NOM	NOMINAL	TJI	TRUSS JOIST
SJ.	CONSTRUCTION JOINTS	FTG	FOOTING	NTS	NOT TO SCALE	TOP	TOP OF PLATE
	CENTER LINE	FURN	FURNACE	OA	OVER ALL	TYP	TYPICAL
CLG	CEILING	GA	GANGE	oc oc	ON CENTER	ůc'	UNDER COUNTER
SLO SLO	CLOSET	GALV	GALVANIZED	OHD	OVERHEAD DOOR	UON	UNLESS OTHERWISE NOTE
SMU	CONCRETE MASONRY UNIT	GLU-LAM	GLUE LAMINATED BEAM	OPT	OPTIONAL	VB	COVED VINYL BASE
SOL	COLUMN	GT GT	GROUT	PERF	PERFORATED	VCT	VINYL COMPOSITION TILE
SONG	CONCRETE	GWB	GYPSUM WALL BOARD	E E E	PLATE	VERT	VERTICAL
CONST	CONSTRUCTION	H	HARDWARE	PLAM	PLASTIC LAMINATE	VIF	VERIFY IN FIELD
CONT	CONTINUOUS	HC	HOLLOW CORE	PLYWD	PLYWOOD	VIIIC	VINYL WALL BASE
ON I	CERAMIC TILE	HD HD	HEAD	PREFIN	PREFINISHED	W/	WITH
TB	CERAMIC TILE BASE	HDR	HEADER	PSF	POUNDS PER SQUARE FOOT	WB	WOOD BASE
DEMO	DEMOLITION	HDR HT	HEADER HEIGHT	P51	POUNDS PER SQUARE NOCH	WIC WID	WALK-IN CLOSET
DEMO DIA ø	DIAMETER	HM	HOLLOW METAL	P51	PAINT	WD	WALK-IN CLOSET
DIM	DIAMETER DIMENSION	HM HORZ	HORIZONTAL	PVC		WD0	WINDOW
	DIVISION	HORZ HR	HOUR		POLYVINYLCHLORIDE	W/O	WITHOUT
DIV DWGS		HR HTG	HEATING:	R/T R\$5	REFER TO ROD & SHELF	W/O	WATERPROOF
	DRAWINGS	₩16+					

PARTICIPANTS

OWNER:

Hiller Ford, Inc 6455 South 108 Street Franklin, Wisconsin 53132 Tele: (414) 425-1000 Fax: n/a Contact: Jay Hiller

ARCHITECT:

Perspective Design, Inc. Tele: $(4|4) 302 - 1780 \times 201$ Contact: William H. Conine E-Mail: bconine@pdi-arch.com


GENERAL CONTRACTOR/ CONSTRUCTION MANAGER:

Mark Carstensen Developments, LLC. 9130 W. Loomis Road - Suite 950 Tele: (414) 235-3571 Fax: (414) 235-3572 Contact: Mark Carstensen E-Mail: mark@meccd.com

CIVIL ENGINEER:	ELECTRICAL ENG./DESIGN BUILD:
JSD Professional Services, Inc. N22 W22931 Nancy Court - Suite #3 Waukesha, WI 53186 Tele: (262) 513-0666 Fax: (262) 513-1232 Contact: Justin L. Johnson E-Mail: justin.johnson@jsdinc.com	T.B.D.
STRUCTURAL ENGINEER:	PLUMBING ENG./DESIGN BUILD:


	,
Pierce Engineers 241 N. Broadway, #500 Milwaukee, WI 53202 Tele: (414) 278-6020 Fax: (414) 278-6061 Contact: Randy Elliott E-mail: rse@pierceengineers.com	T.B.D.
MECHANICAL ENG./DESIGN BUILD:	FIRE PROTECTION DESIGN BUILD
T.B.D.	T.B.D.

ARC	CHITECTURAL:	BUILDING CODE: WI COMMERCIAL BUILDING CODE ADOPTION OF THE INTERNATIONAL CODES SUBJECT TO THE MODIFICATION SPECIFIED BY WI DEPTMARTMENT OF SAFETY \$
†1	TITLE SHEET	PROFESSIONAL SERVICES, CHAPTER 361-366 INTERNATIONAL BUILDING CODE - 2009 INTERNATIONAL ENERGY CONSERVATION CODE - 2009
		COMCHECK: 3,9,003 INTERNATIONAL MECHANICAL CODE - 2009 INTERNATIONAL FUEL GAS CODE - 2009
41.1	DIMENSIONED FLOOR PLAN	INTERNATIONAL EXISTING BUILDING CODE - 2009 ACCESSIBILITY CODES:
		INTERNATIONAL BUILDING CODE- 2009, CHAPTER 11 ICC/ANSI AII7.1 - 2003 DOJ 2010 ADA STANDARDS FOR ACCESSIBLE DESIGN
41.5	ROOF PLAN	MECHANICAL CODE: REFER TO WI COMMERCIAL BUILDING CODE
42.1	BUILDING ELEVATIONS	ELECTRICAL CODE: • INTERNATIONAL BUILDING CODE - 2009, CHAPTER 27 • WI SAFETY & PROFESSIONAL SERVICES, CHAPTER 316
42.2	BUILDING ELEVATIONS WITH COLOR	REF. NATIONAL ELECTRIC CODE, • NATIONAL ELECTRIC CODE (NEC) - 2008 SUBJECT TO THE CHANGES,
		ADDITIONS OR OMISSIONS SPECIFIED IN SUB CH. III. OF CHAPTER 316
		PLUMBING CODE: INTERNATIONAL BUILDING CODE - 2009, CHAPTER 29 WI SAFETY & PROFESSIONAL SERVICES, CHAPTER 381-387
		FIRE PREVENTION: • WI SAFETY & PROFESSIONAL SERVICES, CHAPTER 314 REFERENCE NFPA
		NFPA 1, FIRE CODE - 2009 AND/OR LOCAL FIRE ORDINANCE IF APPLICABLE SUBJECT TO THE MODIFICATIONS
		AS SPECIFIED IN CHAPTER 314 <u>CIVIL ENGINEER:</u> CIVIL ENGINEER IS RESPONSIBLE FOR ALL FEDERAL, STATE AND LOCAL CODES
		RELATED TO STORM WATER MANAGEMENT, EROSION CONTROL, SOIL DISTURBANCE, AND NATURAL RESOURCE PROTECTION.
		EMERGENCY EGRESS LIGHTING: -THESE DOCUMENTS DENOTE AN EGRESS PLAN SHOWING THE PATH WHERE EXIT
		LIGHTS & EMERGENCY EGRESS LIGHTING MAY BE REQUIRED FOR NEW BUILDINGS, ADDITIONS OR ALTERATIONS THAT CREATE NEW EGRESS PATHS, THE ELECTRICAL DESIGNER SHALL PROVIDE, AT THE PROJECT SITE DURING
		CONSTRUCTION, EMERGENCY LIGHTING CUT-SHEETS, CALCULATIONS, PHOTOMETERICS OR OTHER MEANS TO SHOW COMPLIANCE WITH APPLICABLE CODES.
		LIGHTING & ENERGY CONSERVATION: ELECTRICAL DESIGNER SHALL PREPARE A LIGHTING PLAN AND PROVIDE, AT THE
		PROJECT SITE DURING CONSTRUCTION, LIGHTING PLANS AS WELL AS FIXTURE CUT-SHEETS AND ENERGY CALCULATIONS TO SHOW COMPLIANCE WITH THE ENERGY CODE.
		ACCESSIBILITY NOTES: -THIS PROJECT INCLUDES AN ALTERATION TO AN AREA OF PRIMARY FUNCTION. AS
		DENOTED IN THESE DOCUMENTS, ACCESSIBILITY UPGRADES ARE BEING PROVIDED TO THE ACCESSIBLE ROUTE, INCLUDING TOILET AND DRINKING FACILITIES, AS
		REQUIRED BY THE EXISTING BUILDING CODE. THESE UPGRADES ARE LIMITED TO 20% OF THE PROJECT COST AS ALLOWED BY THE EXISTING BUILDING CODE.
		BUILDING DATA PROJECT DESCRIPTION:
		TYPE OF WORK ALTERATION & ADDITON BUILDING CODE CLASS: LEVEL 3
		AREA OF WORK 4,106 SQ. FT. USE & OCCUPANCY: MAJOR USE: 5-1 (Motor Vehicle Repair)
		ACCESSORY OCCUPANCY: B (Office Area) — GENERAL BUILDING DATA: ALLOWED: ACTUAL:
STRU	UCTURAL:	APPROX HEIGHT: 55'-0" 20'-6" PROSED NEW GROSS AREA: 11,500 - (UNMODIFIED) 13,658 SF. EXISTING BLDG: 9360 SF.
T.B.D.		DEMOLITION AREA: 408 S.F. BLDG ADDITION: 3,661 S.F.
		CANOPY AREA: 636 SF. % OF WORK AREA 50/28% NUMBER OF STORIES: 2 - (UNMODIFIED) 1
		NUMBER OF FLOORS: 2 - (UNMODIFIED) 1 TYPE OF CONSTRUCTION: 2-B (METAL FRAME - UNPROTECTED)
		FIRE RESISTANCE RATED CONST.: NOT REQUIRED
		FIRE PROTECTION SYSTEMS: AUTOMATIC SPRINKLER: REQUIRED & EXISTING TO BE EXTENDED
		TO NEW AREAS INCLUDING CANOPY TYPE: COMPLETE CLASS: WET & DRY (UNDER CANOPY)
MEC	CHANICAL & ELECTRICAL	NEPA STANDARD: NEPA 13 FIRE ALARM & DETECTION: REQUIRED & EXISTING TO BE EXTENDED MONITOR TYPE: AUTOMATIC
T.B.D.		- SMOKE ALARM & DETECTION: REQUIRED & EXISTING TO BE EXTENDED MONITOR TYPE: AUTOMATIC
·		MEANS OF EGRESS IN AREA OF WORK: OCCUPANT LOAD: EGRESS WIDTH: -
		STAIRWAYS: N/A EXIT TRAVEL DISTANCE: 250'-0" MAX PER 1016.1 (6-1)
		PLUMBING: SYSTEMS: REQUIRED ACTUAL MENS: WATERCLOSETS: 1 1
PLUN	MBING & FIRE PROTECTION	URINAL Ø Ø LAVATORIES I I WOMENS:
		WATERCLOSETS 1 1

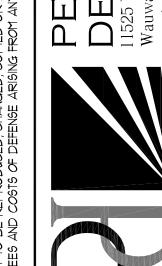

Project:



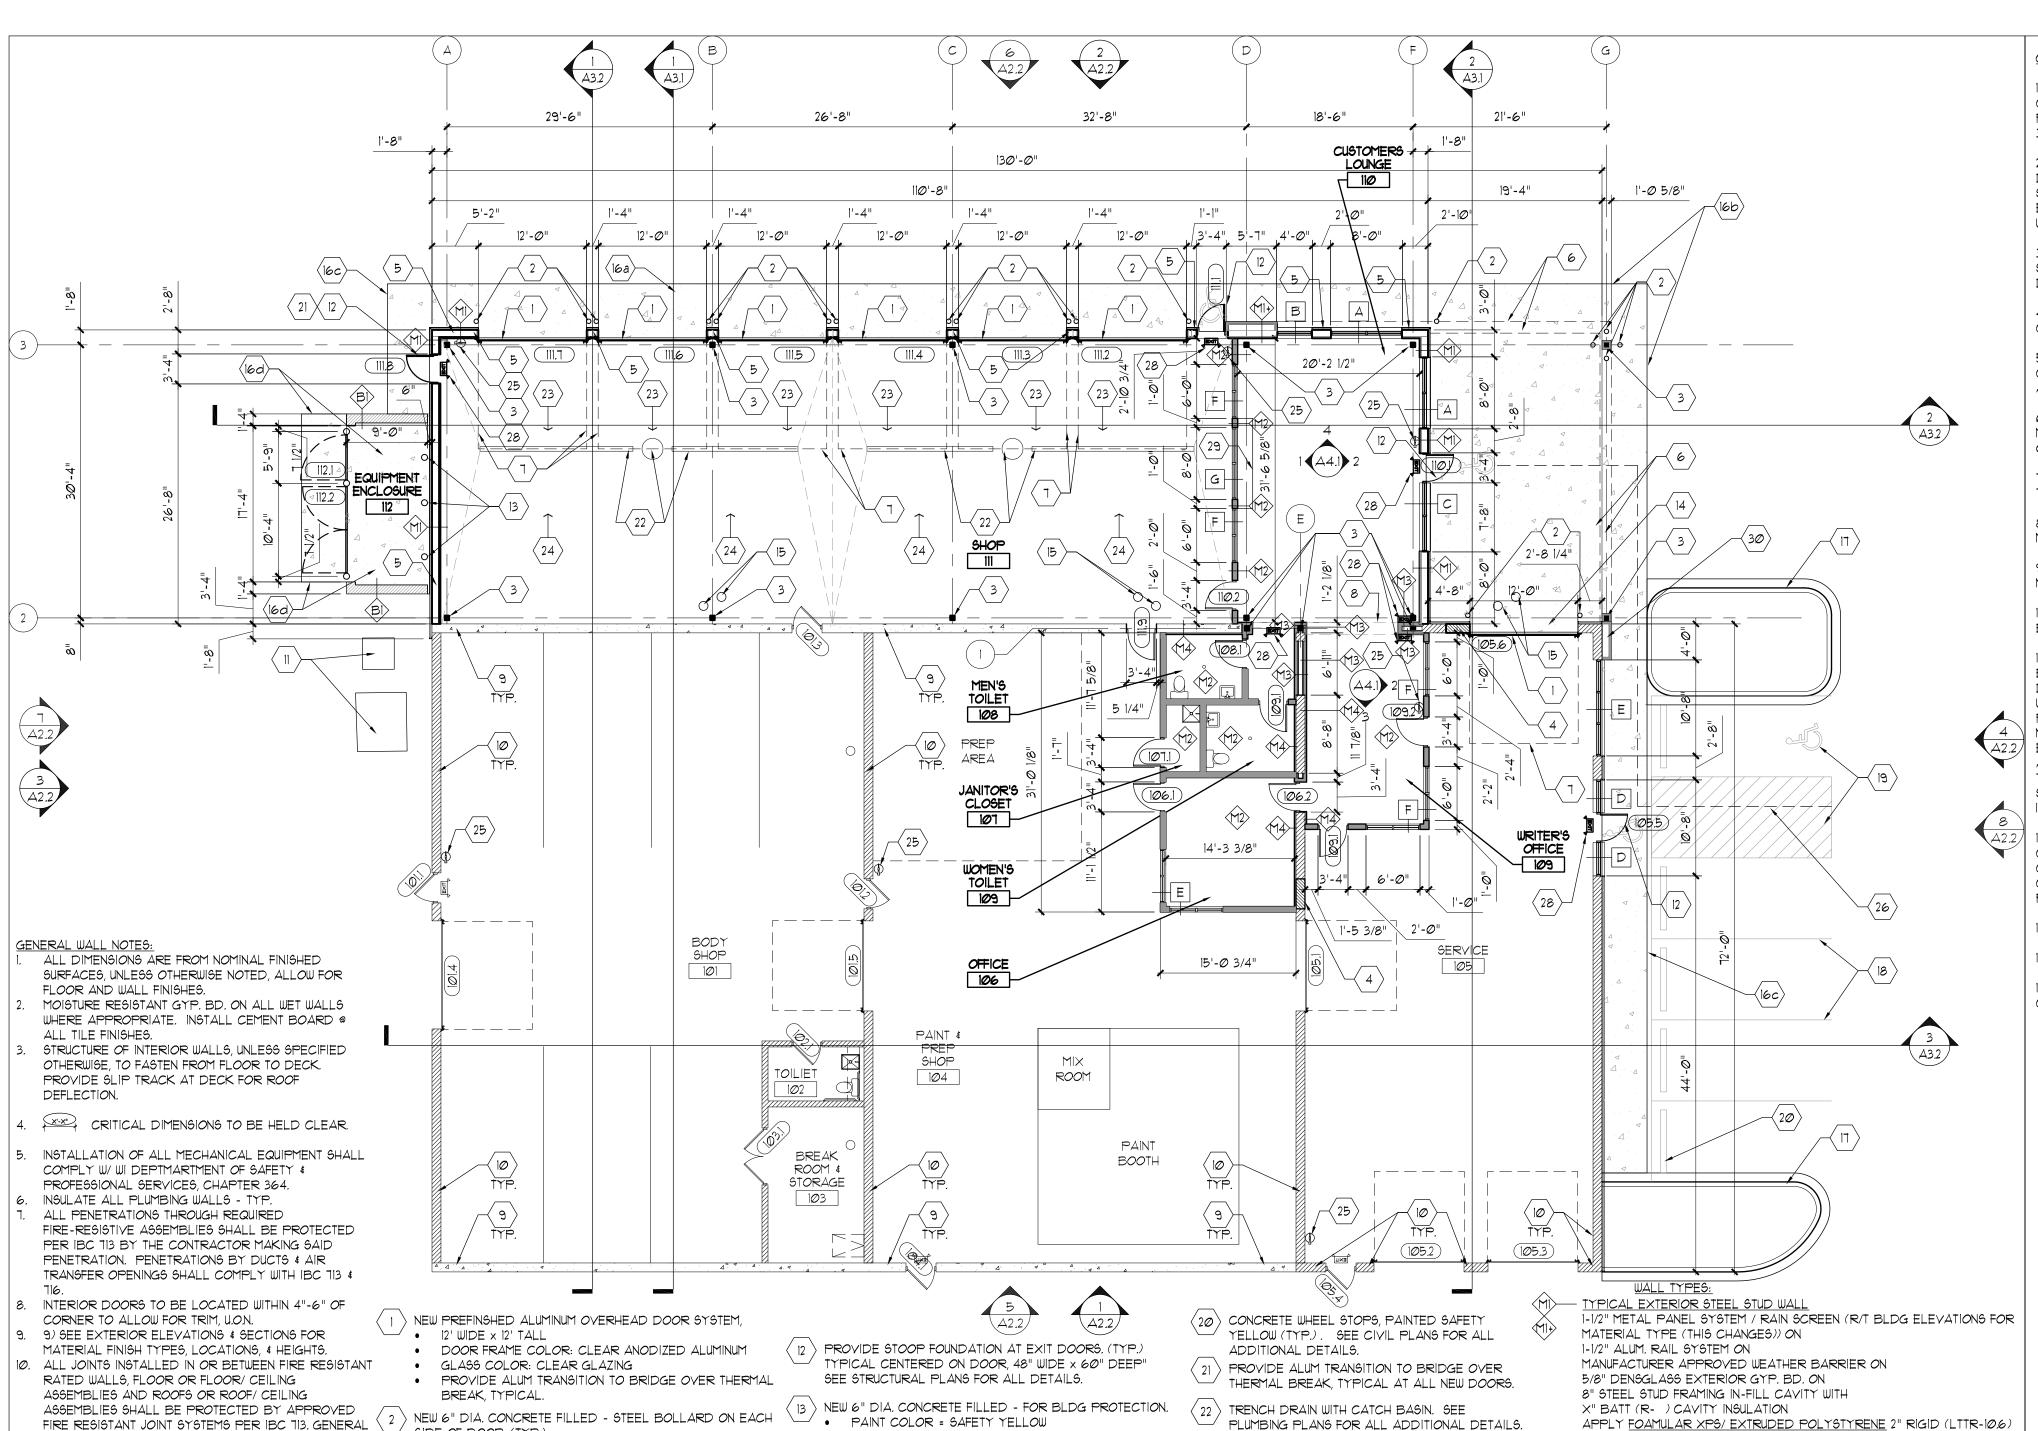

NEW 6" DIA. CONCRETE FILLED - STEEL BOLLARD ON EACH SIDE OF DOOR, (TYP.) CONFIRM PAINT COLOR WITH BLDG ELEVATION.

 $\left(\begin{array}{c} 3 \end{array}
ight)$ NEW STEEL COLUMN. SEE STRUCTURAL DRAWINGS FOR ALL DETAILS. (TYP.) $_{
m I}$ angle NEW CMU WALL TO MATCH SURROUNDING AND IN-FILL WALL.

SPECIFICATIONS FOR SPECIFIC INSTALLATION DETAILS. NEW STEEL STUD EXTERIOR WALL. SEE WALL TYPE MI FOR SPECIFICATIONS AND UNDERWRITERS LABORATORIES MORE DETAILS.

GYP. BD. TO BE INSTALLED FLOOR TO DECK OR TOP \langle 6 \rangle LINE OF OVERHEAD CANOPY. (ABOVE)

 \langle 1 \rangle Line of overhead door, in the open position, (above)

(8) LINE OF GYP. BD. SOFFIT. (ABOVE)

CONTRACTOR TO SCHEDULE JOINT PROTECTION PRIOR

TO INSTALLATION OF FINISHES.

REFER TO AND FOLLOW MANUFACTURERS

REFER TO AND FOLLOW MANUFACTURERS

DIRECTORY FOR SPECIFIC INSTALLATION DETAILS.

OF STUD WALL, UNLESS OTHERWISE NOTED. DO NOT

GAUGE OF STUD SHALL BE ENGINEERED BY THE

SOUND BATT TO BE INSTALLED FLOOR TO DECK,

TOILET ROOM WALLS SHALL HAVE 2 COATS OIL

GYP. BOARD FINISH TO BE OMITTED AT

GYP. BOARD IS PHYSICALLY IMPOSSIBLE.

BASED, SEMI-GLOSS PAINT WITH PRIMER, UNLESS

ALL INTERIOR WALLS TO BE TAPED AND SANDED

UNOCCUPIABLE SPACES WHERE THE APPLICATION OF

ARCHITECT FOR RECORDS ONLY.

UNLESS OTHERWISE NOTED.

READY FOR TENANT'S FINISH.

OTHERWISE NOTED.

APPLY GYP. BD. TO SLIP TRACK, UNLESS OTHERWISE

MATERIAL SUPPLIER. SUBMIT ENGINEERING DATA TO

WALL NOTES:

 \langle 9 \rangle EXISTING PRE-CAST WALL TO REMAIN.

(10) EXISTING CMU WALL TO REMAIN.

NEW ELECTRICAL TRANSFORMER AND UTILITY CONNECTIONS. SEE CIVIL PLANS FOR ALL DETAILS.

(10) EXISTING CMU WALL TO REMAIN.

 \langle 11 angle NEW ELECTRICAL TRANSFORMER AND UTILITY CONNECTIONS. SEE CIVIL PLANS FOR ALL DETAILS.

 PAINT COLOR = SAFETY YELLOW PROVIDE NEW STEEL LINTEL TO CARRY FROM EXISTING

OPENING OVER NEW (EXPANDED) OPENING. SEE STRUCTURAL PLANS FOR ALL DETAILS. > ROOF DRAIN & OVERFLOW DRAINS (ABOVE). R/T PLUMBING PLANS FOR ALL DETAILS. FINAL SIZING, QUANTITY & LOCATIONS TO BE ROOFING

SUBCONTRACTOR AND PLUMBING DESIGNER. (16) EDGE OF CONCRETE APRON - TYPICALLY 60" DEEP FROM OUTSIDE FACE FOUNDATION WALL

DRIVE - TYPICALLY UNDER CANOPY SIDEWALK - TYPICALLY 60" DEEP FROM OUTSIDE FACE FOUNDATION WALL PAD - ENTIRE INSIDE FACE OF TRASH ENCLOSURE \(\) 27

AND EXTENDED 60" FROM FRONT FACE. SLOPE NOT LESS THAN 1% AWAY FROM BLDG. (TYP.) SEE CIVIL PLANS FOR ALL ADDITIONAL DETAILS.

CONCRETE CURB. SEE CIVIL PLANS FOR ALL ADDITIONAL DETAILS. (18) PAVEMENT PAINT (TYP.). SEE CIVIL PLANS FOR ALL ADDITIONAL DETAILS.

(19) VAN ACCESSIBLE PARKING STALL WITH ASSOCIATED LOADING AREA AND POST MOUNTED SIGNAGE. (TYP.). SEE CIVIL PLANS FOR ALL ADDITIONAL DETAILS.

PLUMBING PLANS FOR ALL ADDITIONAL DETAILS.

(23) SLOPE FLOOR DOWN TOWARDS TRENCH DRAIN AT 1/4" PER FOOT.

 \langle 24 \rangle SLOPE FLOOR DOWN TOWARDS TRENCH DRAIN.

 \langle 25 \rangle FIRE EXTINGUISHER LOCATION (SUGGESTED). TYPE SHALL BE DETERMINED BY SUBCONTRACTOR. FINAL LOCATIONS AND QUANTITIES SHALL BE DETERMINED BY LOCAL

AUTHORITIES. (26) ACCESSIBLE PATH FROM PARKING TO MAIN PLANS FOR ALL ADDITIONAL DETAILS.

> ACCESSIBLE PATH FROM PARKING TO MAIN (28) EMERGENCY EXIT LIGHT W/ FLOOD LAMPS (90)

/ MIN. MINIMUM BATTERY BACKUP), ADDITIONAL EXTERIOR EXITS TO HAVE EXTERIOR MOUNTED FLOOD LAMPS FOR EXITING, FINAL LOCATIONS, QUANTITY AND FIXTURE TYPE TO BE BY ELECTRICAL DESIGNER / CONTRACTOR. (29) WALL MOUNTED COUNTER TOP. R/T 5/A4.1 FOR

ADDITIONAL INFORMATION. PROVIDE 8" STUD (SIM WALL TYPE MI) TO PROVIDE WALL PILASTER PROVIDE ADDITION FOUNDATION WALL AND FOOTING.

APPLY FOAMULAR XPS/ EXTRUDED POLYSTYRENE 2" RIGID (LTTR-10.6) CON'T INSULATION TO INSIDE FACE OF STUD. THIS IS TO RUN CON'T FROM T/O FOOTING TO BOTTOM OF DECK. (TYP.)

ENCLOSE WITH CON'T 6 MIL. VAPOR BARRIER PROVIDE 5/8" (M.R.) GYP. BD. TO FROM FLOOR TO ROOF DECK. R/T WALL TYPE CI FOR BELOW GRADE WALL CONST. (+) PROVIDE ADDITIONAL 8" STUD TO BUMP WALL OUT TO CREATE PILASTER, R/T ELEVATION.

TYPICAL STEEL STUD WALL (INTERIOR) TYP TO ALL WALLS IN THIS ROOM U.O.N. PROVIDE 5/8" GYP. BD. TO FROM FLOOR TO ROOF DECK (BOTH SIDES) ON

5" STEEL STUD FRAMING IN-FILL CAVITY WITH SOUND BATT. 149 TYPICAL STEEL STUD WALL (INTERIOR): PROVIDE 5/8" GYP. BD. TO FROM FLOOR TO ROOF DECK ON 3-5/8" STEEL STUD FRAMING. ENTRY. SEE CIVIL PLANS FOR ALL ADDITIONAL TYPICAL STEEL STUD FURRING TO EXISTING WALL (INTERIOR):

> PROVIDE 5/8" GYP. BD. TO FROM FLOOR TO ROOF DECK ON 1-1/2 STEEL STUD FRAMING. (ci)—10" CONCRETE FOUNDATION WALL - (TYP BELOW MI) APPLY FOAMULAR XPS / EXTRUDED POLYSTYRENE 2" RIGID (LTTR-10.6) CON'T INSULATION TO INSIDE FACE OF WALL. THIS IS TO RUN CON'T FROM T/O FOOTING TO BOTTOM OF DECK. (TYP.) R/T WALL TYPE MI FOR ABOVE GRADE WALL CONST.

12" CMU WALL TO 8'-0" A.F.F. CAP WITH METAL COPING. R/T BLDG FOR CMU TYPE &R/T BLDG FOR ALL COLORS.

12" CMU WALL WITH 12" CONCRETE FOUNDATION BELOW

NORTH

GENERAL PROJECT NOTES:

) CONSTRUCTION IS TO BE IN COMPLIANCE W/ ALL GOVERNING CODES, ORDINANCES, & STANDARDS. THE CONTRACTOR(6) SHALL BE RESPONSIBLE FOR INITIATING, MAINTAINING & SUPERVISING ALL SAFETY PRECAUTIONS & PROGRAMS IN CONNECTION W/ THE PERFORMANCE OF THIS CONTRACT. REFER TO IBC CH. 33 (SAFEGUARDS DURING CONSTRUCTION) FOR SPECIFIC CODE RELATED SAFETY REQUIREMENTS.

2) ARCHITECT SHALL NOT BE RESPONSIBLE FOR ANY COST, SCHEDULE, OR CONSTRUCTION ISSUES ARISING DO TO GENERAL CONTRACTORS/ OWNERS FAILURE TO DISTRIBUTE ALL DOCUMENTS TO EACH SUBCONTRACTOR OR MATERIAL SUPPLIER. SUBCONTRACTORS & MATERIAL SUPPLIERS SHOULD ENDEAVOR TO REVIEW A COMPLETE SET OF DOCUMENTS BEFORE BIDDING, FABRICATING, OR INSTALLING

3) ALL CONTRACTORS SHALL BECOME FAMILIAR WITH SITE PRIOR TO BIDDING. GENERAL CONTRACTOR, SUBCONTRACTORS, AND MATERIAL SUPPLIERS MUST NOTIFY ARCHITECT OF ANY ERRORS, OMISSIONS, OR DEFECTS IN THE CONSTRUCTION DOCUMENTS PRIOR TO BIDDING, FABRICATING, OR INSTALLING WORK.

4) ALL MEANS & METHODS OF CONSTRUCTION TO BE THE SOLE RESPONSIBILITY OF THE GENERAL

5) MECH., ELEC., PLUMB & FIRE PROTECTION ARE TO BE DESIGN BUILT, COMPLYING W/ ALL GOVERNING CODES, ORDINANCES & STANDARDS, WHICH WILL BE THE FULL RESPONSIBILITY OF THE CONTRACTOR, THE ARCHITECT ASSUMES NO LIABILITY.

6) ALL MECH., ELEC., PLUMB & FIRE PROTECTION SYSTEMS/ EQUIP. SHALL BE MAINTAINED ACCORDING TO MANUFACTURER'S STANDARDS. BLDG. OWNER ASSUME FULL RESPONSIBILITY FOR MAINTENANCE/ OPERATION AFTER OCCUPANCY.

1) THE INSTALLATION AND EXECUTION OF ALL PRODUCTS & MATERIALS SHALL BE IN ACCORDANCE WITH THE MANUFACTURER'S STANDARDS, INSTRUCTIONS AND SPECIFICATIONS.

8) ALL SUBCONTRACTORS SHALL BE RESPONSIBLE FOR LIMITING THE ACCUMULATION OF WASTE MATERIALS AND RUBBISH. WASTE MATERIALS SHALL BE REMOVED FROM PREMISES DAILY.

9) DIMENSIONS ARE TO BE FIELD VERIFIED & ADJUSTED ACCORDINGLY. THE ARCHITECT SHALL BE NOTIFIED OF ANY VARIANCES BEFORE CONTRACTOR BEGINS OR PROCEEDS WITH WORK

10) HAZARDOUS MATERIAL (INCLUDING ASBESTOS) ASSESSMENT AND ABATEMENT WILL BE COORDINATED

11) PORTABLE FIRE EXTINGUISHERS SHALL BE PROVIDED IN OCCUPANCIES AND LOCATIONS AS REQUIRED BY THE INTERNATIONAL FIRE CODE CH. 906. INSTALLATION LOCATIONS SHALL HAVE A MAXIMUM TRAVEL DISTANCE OF 15' TO ANY EXTINGUISHER. EXTINGUISHERS SHALL BE LOCATED IN CONSPICUOUS LOCATIONS WERE THEY WILL BE READILY ACCESSIBLE AND IMMEDIATELY AVAILABLE FOR USE, TYPICALLY ALONG PATHS OF TRAVEL. EXTINGUISHERS SHALL NOT BE OBSTRUCTED FROM VIEW, IF VISUAL OBSTRUCTION CAN NOT BE AVOIDED AN OTHER MEANS SHALL BE PROVIDED TO INDICATE THE EXTINGUISHER LOCATIONS. EXTINGUISHERS NOT EXCEEDING 40* SHALL BE INSTALLED SO THAT ITS TOP IS NOT MORE THAN 5'-0" ABOVE THE FLOOR, EXTINGUISHERS EXCEEDING 40* SHALL BE INSTALLED SO THAT ITS TOP IS NOT MORE THAN 3'-6" ABOVE THE FLOOR. THE CLEARANCE BETWEEN THE FLOOR & BOTTOM OF HAND HELD UNITS SHALL NOT BE LESS THAN 4". VERIFY EXTINGUISHER LOCATIONS W/ LOCAL FIRE DEPT. 4 OWNER PRIOR TO INSTALLATION.

12) ALL CONCRETE FLATWORK MUST BE WET CURED PER ACI REQUIREMENTS AND/OR CURED USING A CURING COMPOUND. REFER TO STRUCTURAL DRAWINGS FOR CURING COMPOUND SPECIFICATIONS (SUBMIT CURING COMPOUND TECHNICAL DATA TO ARCHITECT FOR APPROVAL BEFORE PLACING CONCRETE). CONTRACTOR IS RESPONSIBLE FOR APPLYING CURING COMPOUNDS PER THE MANUFACTURER'S

13) LEAD PAINT ASSESSMENT, TESTING, AND ABATEMENT WILL BE COORDINATED BY GC.

14) DO NOT SCALE THESE DRAWINGS.

15) REVIEW ALL DRAWINGS INCLUDING DRAWING DIMENSIONS PRIOR TO BIDDING, FABRICATING OR CONSTRUCTING ANY WORK..

GENERAL FLOOR PLAN NOTES:

1) VERIFY ALL FINISHES WITH OWNER PRIOR TO INSTALLATION.

2) GC/ SUPPLIERS TO SUBMIT (5) SETS OF ALL SUBMITTALS

3) ACCOMMODATE EXISTING OUTLETS, FIXTURES, AND MECHANICAL SYSTEMS TO REMAIN. ADJUST LAYOUT AS NECESSARY W/ OWNER & ARCHITECT APPROVAL.

4) PER WISCONSIN COMMERCIAL CODE - TOILET ROOMS MUST BE DIRECTLY ACCESSIBLE TO TENANT'S CUSTOMERS. LOCATION MAY YARY DEPENDENT UPON FUTURE TENANT LAYOUT.

5) THE FOLLOWING CLEARANCES SHALL APPLY TO ALL AREAS OF THE GENERAL SALES AREA. THE MIN. CLEAR AIGLE WIDTH SHALL BE 36" WHERE SEATS, TABLES, FURNISHINGS, DISPLAYS, & SIMILAR FIXTURES OR EQUIPT. ARE PLACED ON ONLY ONE SIDE OF THE AISLE \$ 44" WHERE SUCH FIXTURES OR EQUIPT. ARE PLACED ON BOTH SIDES OF THE AISLE.

6) INSTALL SELF ADHERING ADDRESS SIGN @ FRONT DOOR AS NEC. - VERIFY ADDRESS SIGNAGE LOCATION W/ OWNER PRIOR TO INSTALLATION

7) CARE SHOULD BE TAKEN TO LEAVE EXISTING ITEMS UNDISTURBED AND STILL ACCOMMODATE NEW WORK, EXISTING AREAS TO BE PROTECTED DURING CONSTRUCTION.

8) VERIFY RECESSED EQUIPMENT WITH OWNER PRIOR TO FRAMING WALLS. ADJUST WALL THICKNESS ACCORDINGLY.

9) COORDINATE W/ PLUMBING CONTRACTOR FOR ALL UNDER-SLAB PIPING PRIOR TO SLAB POUR. 10) CARPENTER TO PROVIDE ALL WALL BLOCKING AS NECESSARY FOR OWNER'S EQUIPMENT - VERIFY

I) PER IBC 1017.3 AN AISLE ACCESSWAY SHALL BE PROVIDED ON AT LEAST ONE SIDE OF EACH ELEMENT WITHIN THE MERCHANDISE PAD. THE MINIMUM CLEAR WIDTH FOR AN AISLE ACCESSWAY NOT REQUIRED TO BE ACCESSIBLE SHALL BE 30 INCHES. THE REQUIRED CLEAR WIDTH OF THE AISLE ACCESSWAY SHALL BE MEASURED PERPENDICULAR TO THE ELEMENTS AND MERCHANDISE WITHIN THE MERCHANDISE PAD. THE 30 INCH MINIMUM CLEAR WIDTH SHALL BE MAINTAINED TO PROVIDE A PATH TO AN ADJACENT AISLE OR AISLE ACCESSWAY. THE COMMON PATH OF TRAVEL SHALL NOT EXCEED 30 FEET FROM ANY POINT IN THE MERCHANDISE PAD. <u>EXCEPTION</u>: FOR AREAS SERVING NOT MORE THAN 50 OCCUPANTS, THE COMMON PATH OF TRAVEL SHALL NOT EXCEED 15 FEET.

12) THE ENTIRE BUILDING WILL REMAIN OCCUPIED & OPERATIONAL DURING ALL PHASES OF CONSTRUCTION. ACCOMMODATIONS MUST BE MADE TO ENSURE CONTINUED OPERATION, CUSTOMER ACCESS, TENANT ACCESS, HEATING, COOLING, FIRE PROTECTION, & SECURITY. ACCOMMODATIONS SHALL ALSO BE MADE TO PROTECT THE TENANTS, CUSTOMERS & TENANT'S PROPERTY/MERCHANDISE AS REQ'D. THIS INCLUDES BUT IS NOT LIMITED TO THE FOLLOWING: DUST PROTECTION, NOISE PROTECTION, & FALLING CONSTRUCTION

13) PER IBC 1011.3, A TACTILE SIGN STATING "EXIT" AND COMPLYING WITH ICC A117.1 SHALL BE PROVIDED ADJACENT TO EACH DOOR TO AN AREA OF REFUGE, AN EXTERIOR AREA FOR ASSISTED RESCUE, AN EXIT STAIRWAY, AN EXIT RAMP, AN EXIT PASSAGE AND THE EXIT DISCHARGE.

14) TENANT TO PROVIDE BOTTLED WATER DISPENSER W/ ADJACENT CUP DISPENSER.

LOCATION W/ EQUIP. SUPPLIER.

SEE STRUCTURAL PLANS FOR ALL ADDITIONAL DETAILS. DIMENSIONED FLOOR PLAN SCALE: 3/32" = 1'-0"

NOTES SCALE: 3/32" = 1'-0"

 \Box

Date: 03/09/15 Scale: A.N. Drawn: **WHC**


Drawing Title:

DIMENSIONED

FLOOR


PLAN

Job: 14-125 Sheet:

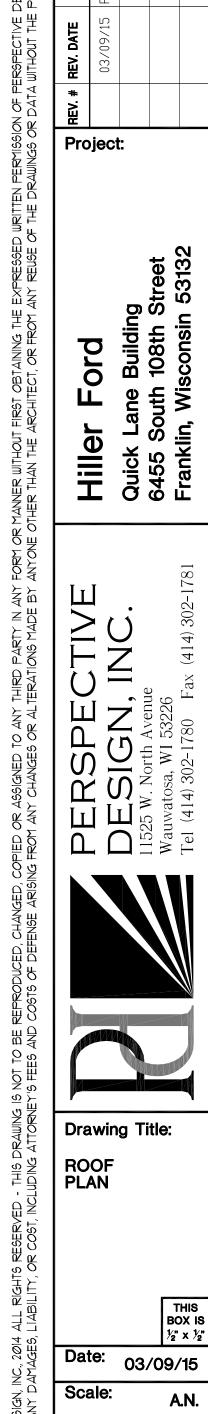

5 <u>₹</u>

AGREES OF THE A

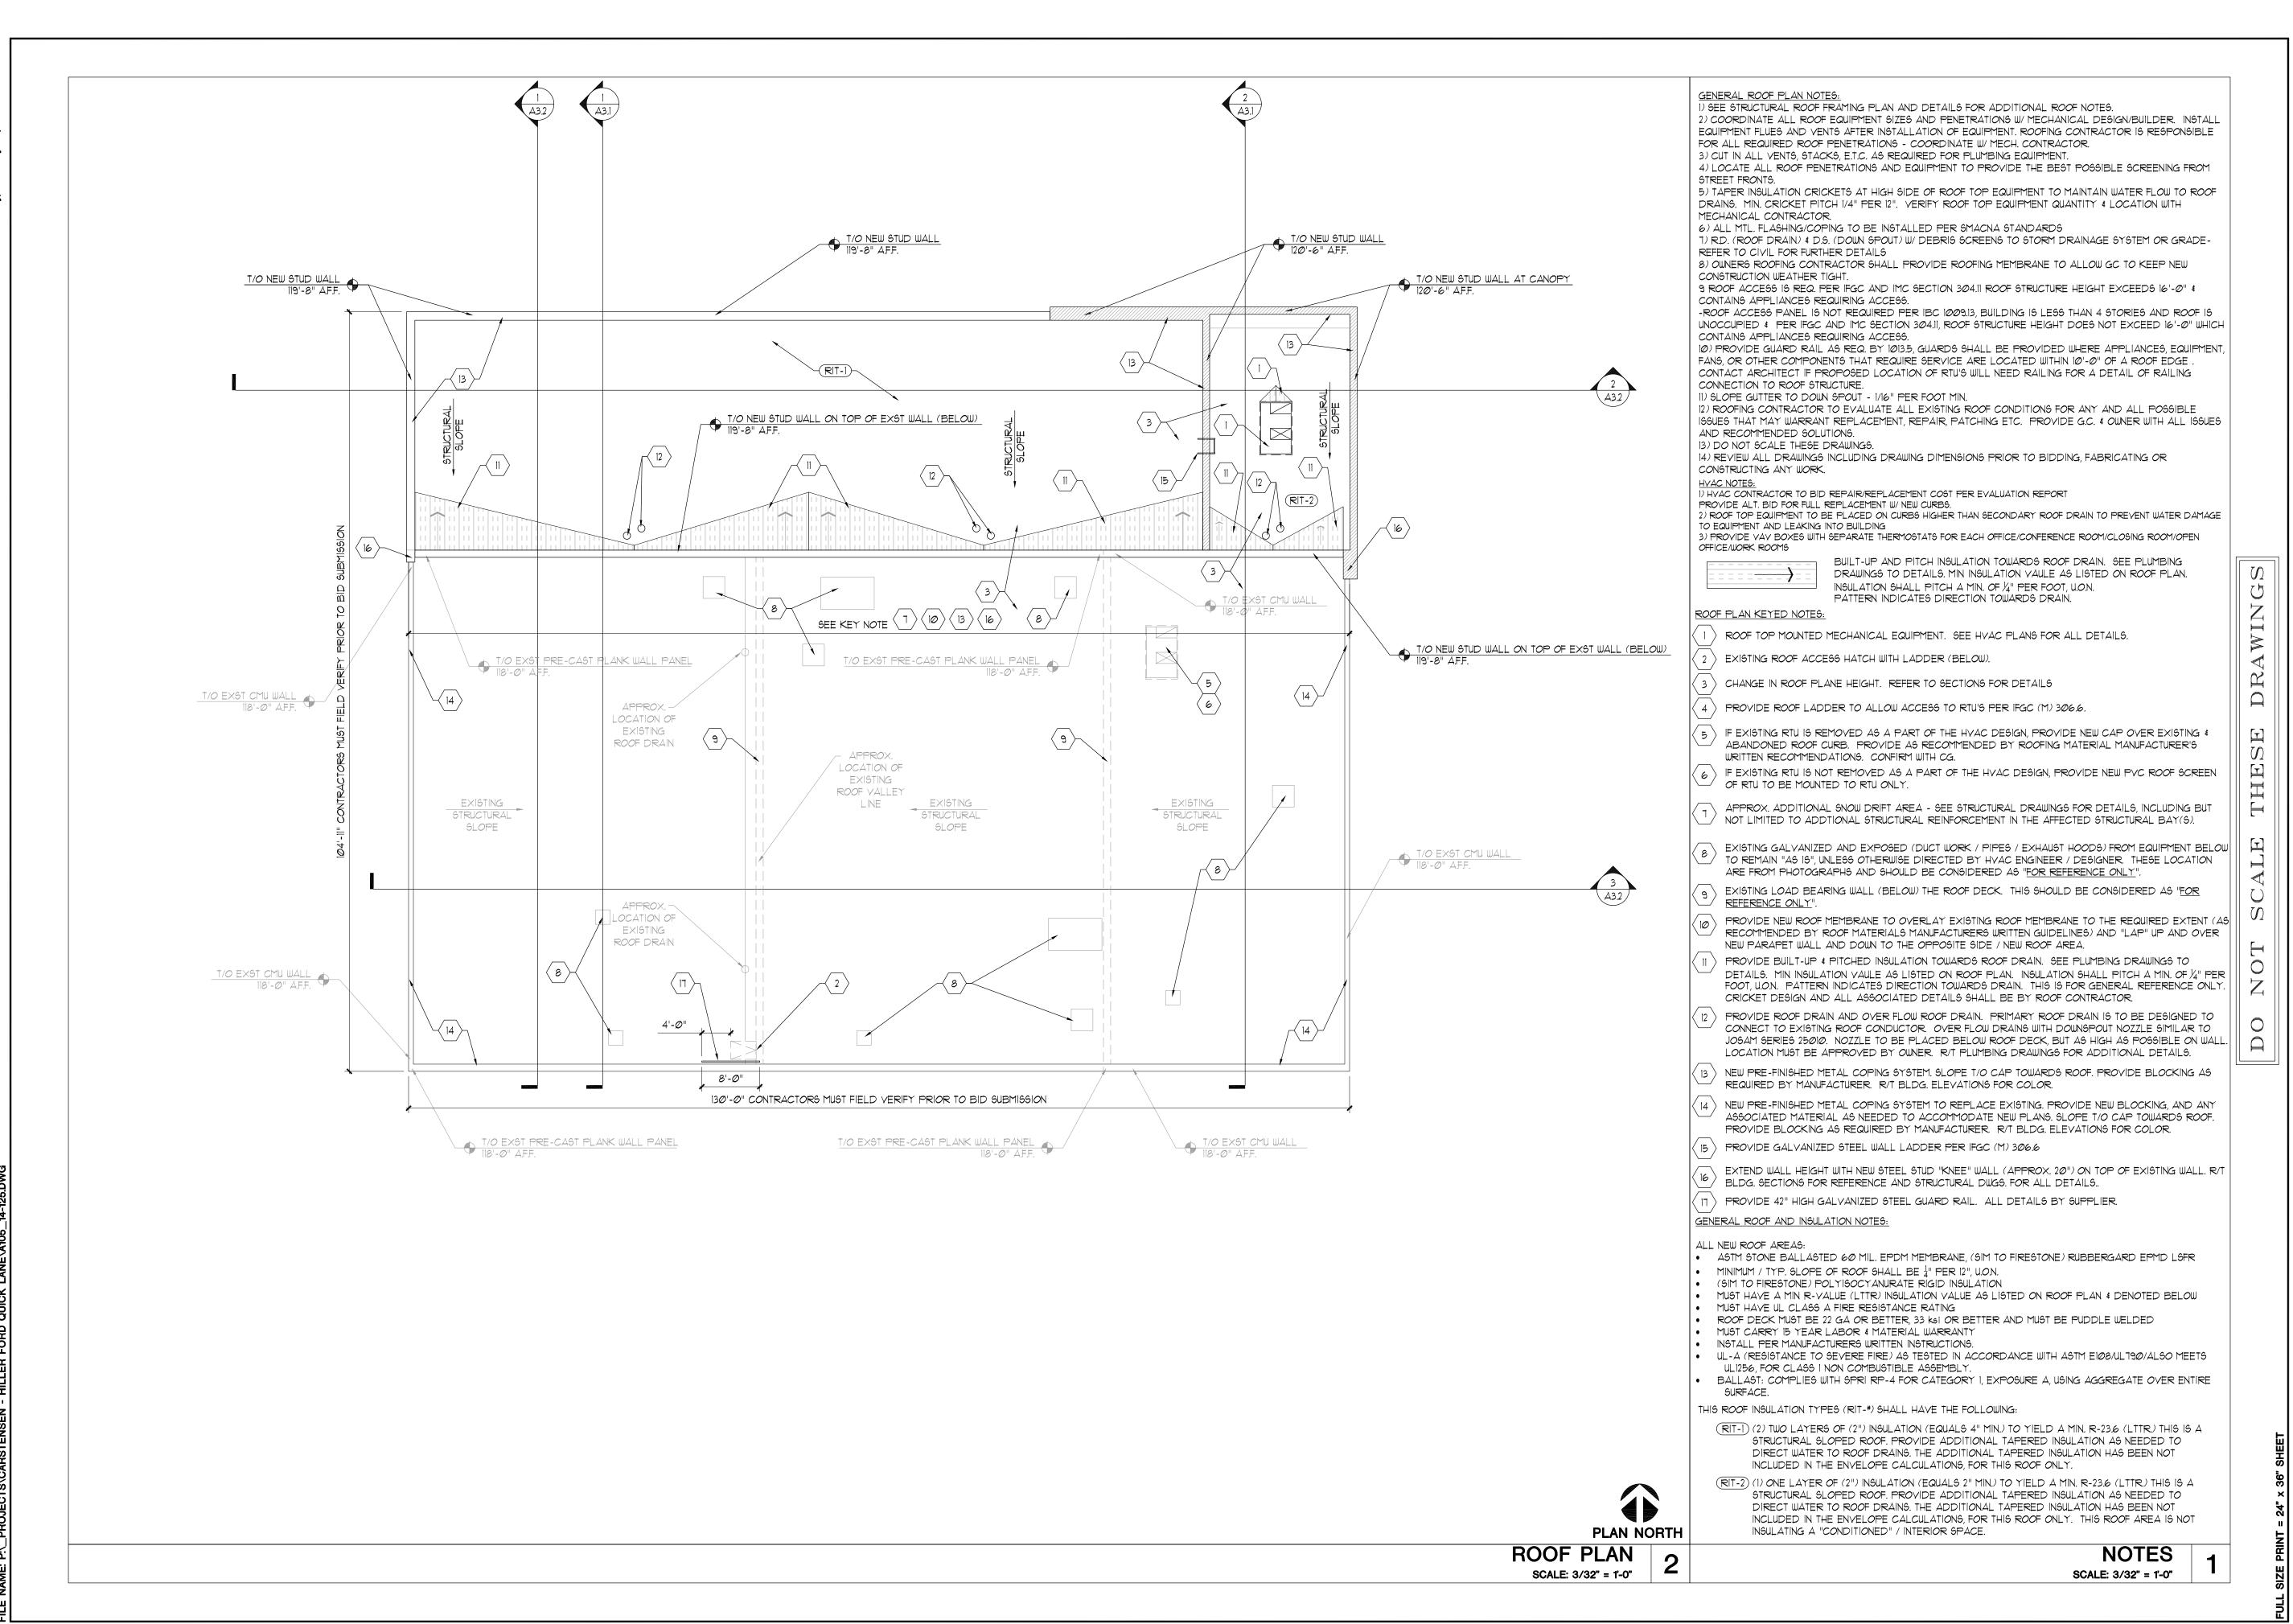

Drawing Title: ROOF PLAN

Drawn:

Sheet:

14-125

SCALE: N/A

Drawing Title:

BUILDING ELEVATIONS

Date:

Scale:

Drawn:

Sheet:

Job:

SCALE: 1/16" = 1'-0"

THIS BOX IS

1/2" x 1/2"

A.N.

WHC

14-125

A2.1

03/09/15

5 <u>₹</u>

AGREES OF THE,

벌뿔

Project:

Drawing Title:

THIS BOX IS

1/2" x 1/2"

A.N.

WHC

14-125

A2.2

03/09/15

BUILDING ELEVATION

COLOR

Date:

Drawn:

Project:


Hille

Hiller Ford - Used Car Bldg.

6455 South 108th Street Franklin, Wisconsin 53132 (Milwaukee County)



BLDG.

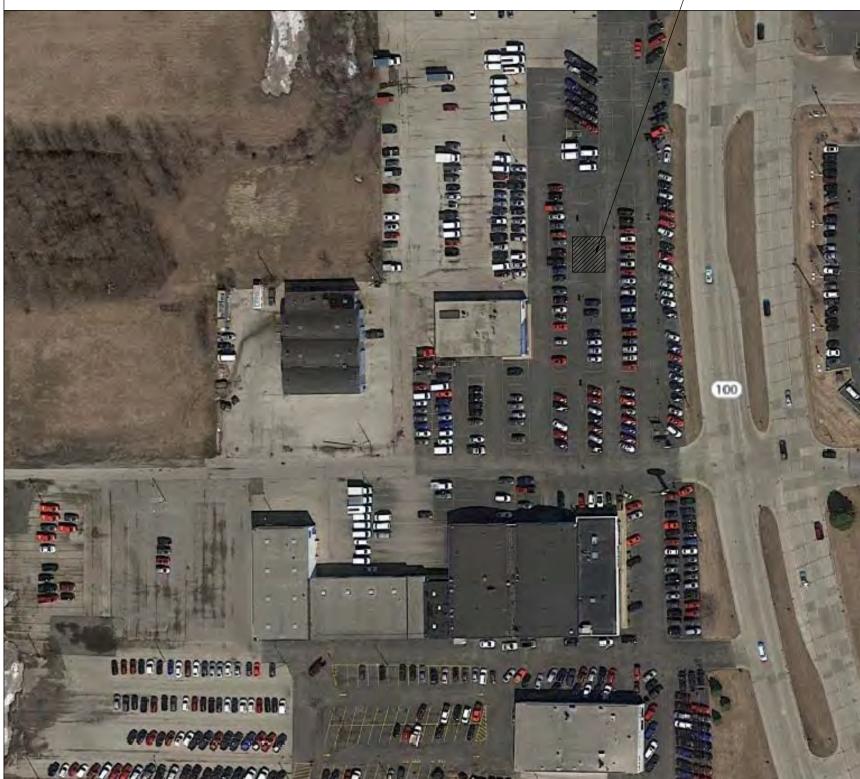



ABBREVIATIONS

AB	ANCHOR BOLT	DW	DISHWASHER	ΙΗΜ	INSULATED HOLLOW METAL	REINF	REINFORCE
AC	AIR CONDITIONING	EA	EACH	INSUL	INSULATION	RO	ROUGH OPENING
ACT	ACOUSTIC CEILING TILE	EXST	EXISTING	INT	INTERIOR	S≰V	STAIN & VARNISH
ACWD	ALUMINUM CLAD WOOD DOOR	EIFS	EXTERIOR INSULATION FINISH SYSTEM	JNT	JOINT	SC	SOLID CORE
ADJ	ADJUSTABLE / ADJACENT	EXP	EXPANSION or EXPOSED	JST	JOIST	SECT	SECTION
AFF	ABOVE FINISH FLOOR	ELECT	ELECTRICAL	LAM	LAMINATE	9F <i>o</i> r #	SQUARE FEET
ALUM	ALUMINUM	ELEY	ELEVATI O N	LAY	LAVATORY	SIM	SIMILAR
A LŤ	ALTERNATE	EQUIP	EQUIPMENT	MAT'L	MATERIAL	SPEC	SPECIFICATION
APPROX	APPROXIMATE	EQUIV	EQUIVALENT	MAX	MAXIMUM	STL	STEEL
ARCH	ARCHITECTURAL	ETR	EXISTING TO REMAIN	MECH	MECHANICAL	STN	STAIN
a	ΑT	EXT	EXTERIOR	MED	MEDIUM	STOR	STORAGE
BD	BOARD	ΕW	EACH WAY	MFG	MANUFACTURER	STRUCT	STRUCTURAL
ВІ	BUILT-IN	FD	FLOOR DRAIN	MIN	MINIMUM	S∨	SHEET VINYL
BLDG	BUILDING	Ħ	FINISH FLOOR	MISC	MISCELLANEOUS	SW	STRIP WOOD
BOT	BOTTOM .	FIN	FINISH	MO	MASONRY OPENING	TBD	TO BE DETERMINED
B/0	BOTTOM OF	FIXT	FIXTURE	MTL	METAL	T#B	TOP & BOTTOM
BRG	BEARING	FLR	FL <i>OO</i> R	MW	MICROWAVE	Ť/ O	TOP OF
BRG PL	BEARING PLATE	FDN	FOUNDATION	NIC	NOT IN CONTRACT	TEL	TELEPHONE
CPT	CARPET	FO	FACE OF	NO	NUMBER	T#G:	TONGUE & GROOVE
CABT	CABINET	FS	FLOOR SEAL	NOM	NOMINAL	TJI	TRUSS JOIST
CJ	CONSTRUCTION JOINTS	FTG	FOOTING	NTS	NOT TO SCALE	TOP	TOP OF PLATE
¢.	CENTER LINE	FURN	FURNACE	OΑ	OVER ALL	TYP	TYPICAL
CLG	CEILNG	GΑ	GAUGE	oc	ON CENTER	uc	UNDER COUNTER
CLO	CLOSET	GALY	GALVANIZED	OHD	OVERHEAD DOOR	UON	UNLESS OTHERWISE NOTED
CMU	CONCRETE MASONRY UNIT	GLU-LAM	GLUE LAMINATED BEAM	<i>o</i> pt	OPTIONAL .	VΒ	COVED VINYL BASE
COL	COLUMN	GŤ	GROUT	PERF	PERFORATED	VCT	VINYL COMPOSITION TILE
CONC	CONCRETE	GWB	GYPSUM WALL BOARD	Æ	PLATE	VERT	VERTICAL
CONST	CONSTRUCTION	H	HARDWARE	PLAM	PLASTIC LAMINATE	VIF	VERIFY IN FIELD
CONT	CONTINUOUS	HC	HOLLOW CORE	PLYWD	PLYWOOD	VWC	VINYL WALL BASE
CT	CERAMIC TILE	HD	HEAD	PREFIN	PREFINISHED	W/	WITH
CTB	CERAMIC TILE BASE	HDR	HEADER	PSF	POUNDS PER SQUARE FOOT	WB	WOOD BASE
DEMO	DEMOLITION	HT	HEIGHT	PSI	POUNDS PER SQUARE INCH	WIC	WALK-IN CLOSET
DIA +	DIAMETER	HM	HOLLOW METAL	PT	PAINT	WD	WOOD
DIM	DIMENSION	HORZ	HORIZONTAL	PVC	POLYVINYLCHLORIDE	WDO	WINDOW
DIV	DIVISION	HR	HOUR	R/T	REFER TO	W/O	WITHOUT
DWGS	DRAWINGS	HTG	HEATING:	R45	ROD & SHELF	WP	WATERPROOF
DS	DOWNSPOUT	HVAC	HEAT, VENTILATE, AIR CONDITIONING	REC	RECESSED	ww⊨	WELDED WIRE FABRIC

PARTICIPANTS

OWNER:

Hiller Ford, Inc 6455 South 108 Street Franklin, Wisconsin 53132 Tele: (414) 425-1000 Fax: n/a Contact: Jay Hiller

ARCHITECT:

Perspective Design, Inc. 11525 W. North Avenue Wauwatosa, WI 53226 Tele: $(414) 302 - 1780 \times 201$ Fax: (414) 3Ø2-1781 Contact: William H. Conine E-Mail: bconine@pdi-arch.com

GENERAL CONTRACTOR/ CONSTRUCTION MANAGER:

Mark Carstensen Developments, LLC. 9130 W. Loomis Road - Suite 950 Franklin, WI 53132 Tele: (414) 235-3571 Fax: (4|4) 235-3572 Contact: Mark Carstensen E-Mail: mark@meccd.com

CIVIL ENGINEER:	ELECTRICAL ENG./DESIGN BUILD:
JSD Professional Services, Inc. N22 W22931 Nancy Court - Suite #3 Waukesha, WI 53186 Tele: (262) 513-0666 Fax: (262) 513-1232 Contact: Justin L. Johnson E-Mail: justin.johnson@jsdinc.com	T.B.D.
STRUCTURAL ENGINEER:	PLUMBING ENG./DESIGN BUILD:

Pierce Engineers	T.B.D.
241 N. Broadway, #500	
Milwaukee, Wl 53202	
Tele: (414) 278-6020	
Fax: (414) 278-6061	
Contact: Randy Elliott	
E-mail: rseapierceengineers.com	
MECHANICAL ENG./DESIGN BUILD:	FIRE PROTECTION DESIGN BUILD
T.B.D.	T.B.D.

DRAWING INDEX	CODE REFERENCE
ARCHITECTURAL:	BUILDING CODE: WI COMMERCIAL BUILDING CODE ADOPTION OF THE INTERNATIONAL CODES SUBJECT TO THE MODIFICATION SPECIFIED BY WI DEPTMARTMENT OF SAFETY \$

INTERNATIONAL ENERGY CONSERVATION CODE - 2009 INTERNATIONAL MECHANICAL CODE - 2009 DIMENSIONED FLOOR PLAN ICC/ANSI A117.1 - 2003

ROOF PLAN BUILDING ELEVATIONS BUILDING ELEVATIONS WITH COLOR

TI TITLE SHEET

REFER TO WI COMMERCIAL BUILDING CODE ELECTRICAL CODE: INTERNATIONAL BUILDING CODE - 2009, CHAPTER 27 WI SAFETY & PROFESSIONAL SERVICES, CHAPTER 316 REF. NATIONAL ELECTRIC CODE, NATIONAL ELECTRIC CODE (NEC) - 2008 SUBJECT TO THE CHANGES, ADDITIONS OR OMISSIONS SPECIFIED • WI SAFETY & PROFESSIONAL SERVICES, CHAPTER 381-381 FIRE PREVENTION:

• WI SAFETY & PROFESSIONAL SERVICES, CHAPTER 314 REFERENCE NFPA NFPA I, FIRE CODE - 2009 AND/OR LOCAL FIRE ORDINANCE IF APPLICABLE SUBJECT TO THE MODIFICATIONS <u>CIVIL ENGINEER:</u>
CIVIL ENGINEER IS RESPONSIBLE FOR ALL FEDERAL, STATE AND LOCAL CODES RELATED TO STORM WATER MANAGEMENT, EROSION CONTROL, SOIL DISTURBANCE, AND NATURAL RESOURCE PROTECTION.

PROFESSIONAL SERVICES, CHAPTER 361-366

INTERNATIONAL BUILDING CODE - 2009

COMCHECK: 3.9.03

• D.O.J. - 2010 ADA STANDARDS FOR ACCESSIBLE DESIGN

THESE DOCUMENTS DENOTE AN EGRESS PLAN SHOWING THE PATH WHERE EXIT LIGHTS & EMERGENCY EGRESS LIGHTING MAY BE REQUIRED. FOR NEW BUILDINGS, ADDITIONS OR ALTERATIONS THAT CREATE NEW EGRESS PATHS, THE ELECTRICAL DESIGNER SHALL PROVIDE, AT THE PROJECT SITE DURING CONSTRUCTION, EMERGENCY LIGHTING CUT-SHEETS, CALCULATIONS, PHOTOMETERICS OR OTHER MEANS TO SHOW COMPLIANCE WITH APPLICABLE CODES.

ELECTRICAL DESIGNER SHALL PREPARE A LIGHTING PLAN AND PROVIDE, AT THE PROJECT SITE DURING CONSTRUCTION, LIGHTING PLANS AS WELL AS FIXTURE CUT-SHEETS AND ENERGY CALCULATIONS TO SHOW COMPLIANCE WITH THE ENERGY

BUILDING DATA PROJECT DESCRIPTIONS TYPE OF WORK BUILDING CODE CLASS: NEW CONSTRUCTION

2,418 SQ. FT.

AREA OF WORK <u>USE & OCCUPANCY:</u>

ACCESSORY OCCUPANCY:

GENERAL BUILDING DATA:

DRINKING FOUNTAINS:

OTHER - SERVICE/PREP SINKS: 1

STRUCTURAL:

MECHANICAL & ELECTRICAL

PLUMBING & FIRE PROTECTION


APPROX HEIGHT: GROSS AREA: 17,500 - (UNMODIFIED) NUMBER OF STORIES: NUMBER OF FLOORS: 2 - (UNMODIFIED) 2-B (METAL FRAME - UNPROTECTED) TYPE OF CONSTRUCTION: FIRE RESISTANCE RATED CONST.: FIRE PROTECTION SYSTEMS: AUTOMATIC SPRINKLER: MONITOR TYPE SMOKE ALARM & DETECTION MONITOR TYPE: MEANS OF EGRESS IN AREA OF WORK: OCCUPANT LOAD: -EGRESS WIDTH: EXIT TRAVEL DISTANCE: 250'-0" MAX PER 1016.1 (6-1) PLUMBING SYSTEMS: WATERCLOSETS: LAVATORIES

BOTTLED WATER SHALL BE SUPPLIED FREE OF CHARGE FOR ALL OCCUPANTS.

15-001

Drawn:

Drawing Title: Date: 03/09/15 Scale:

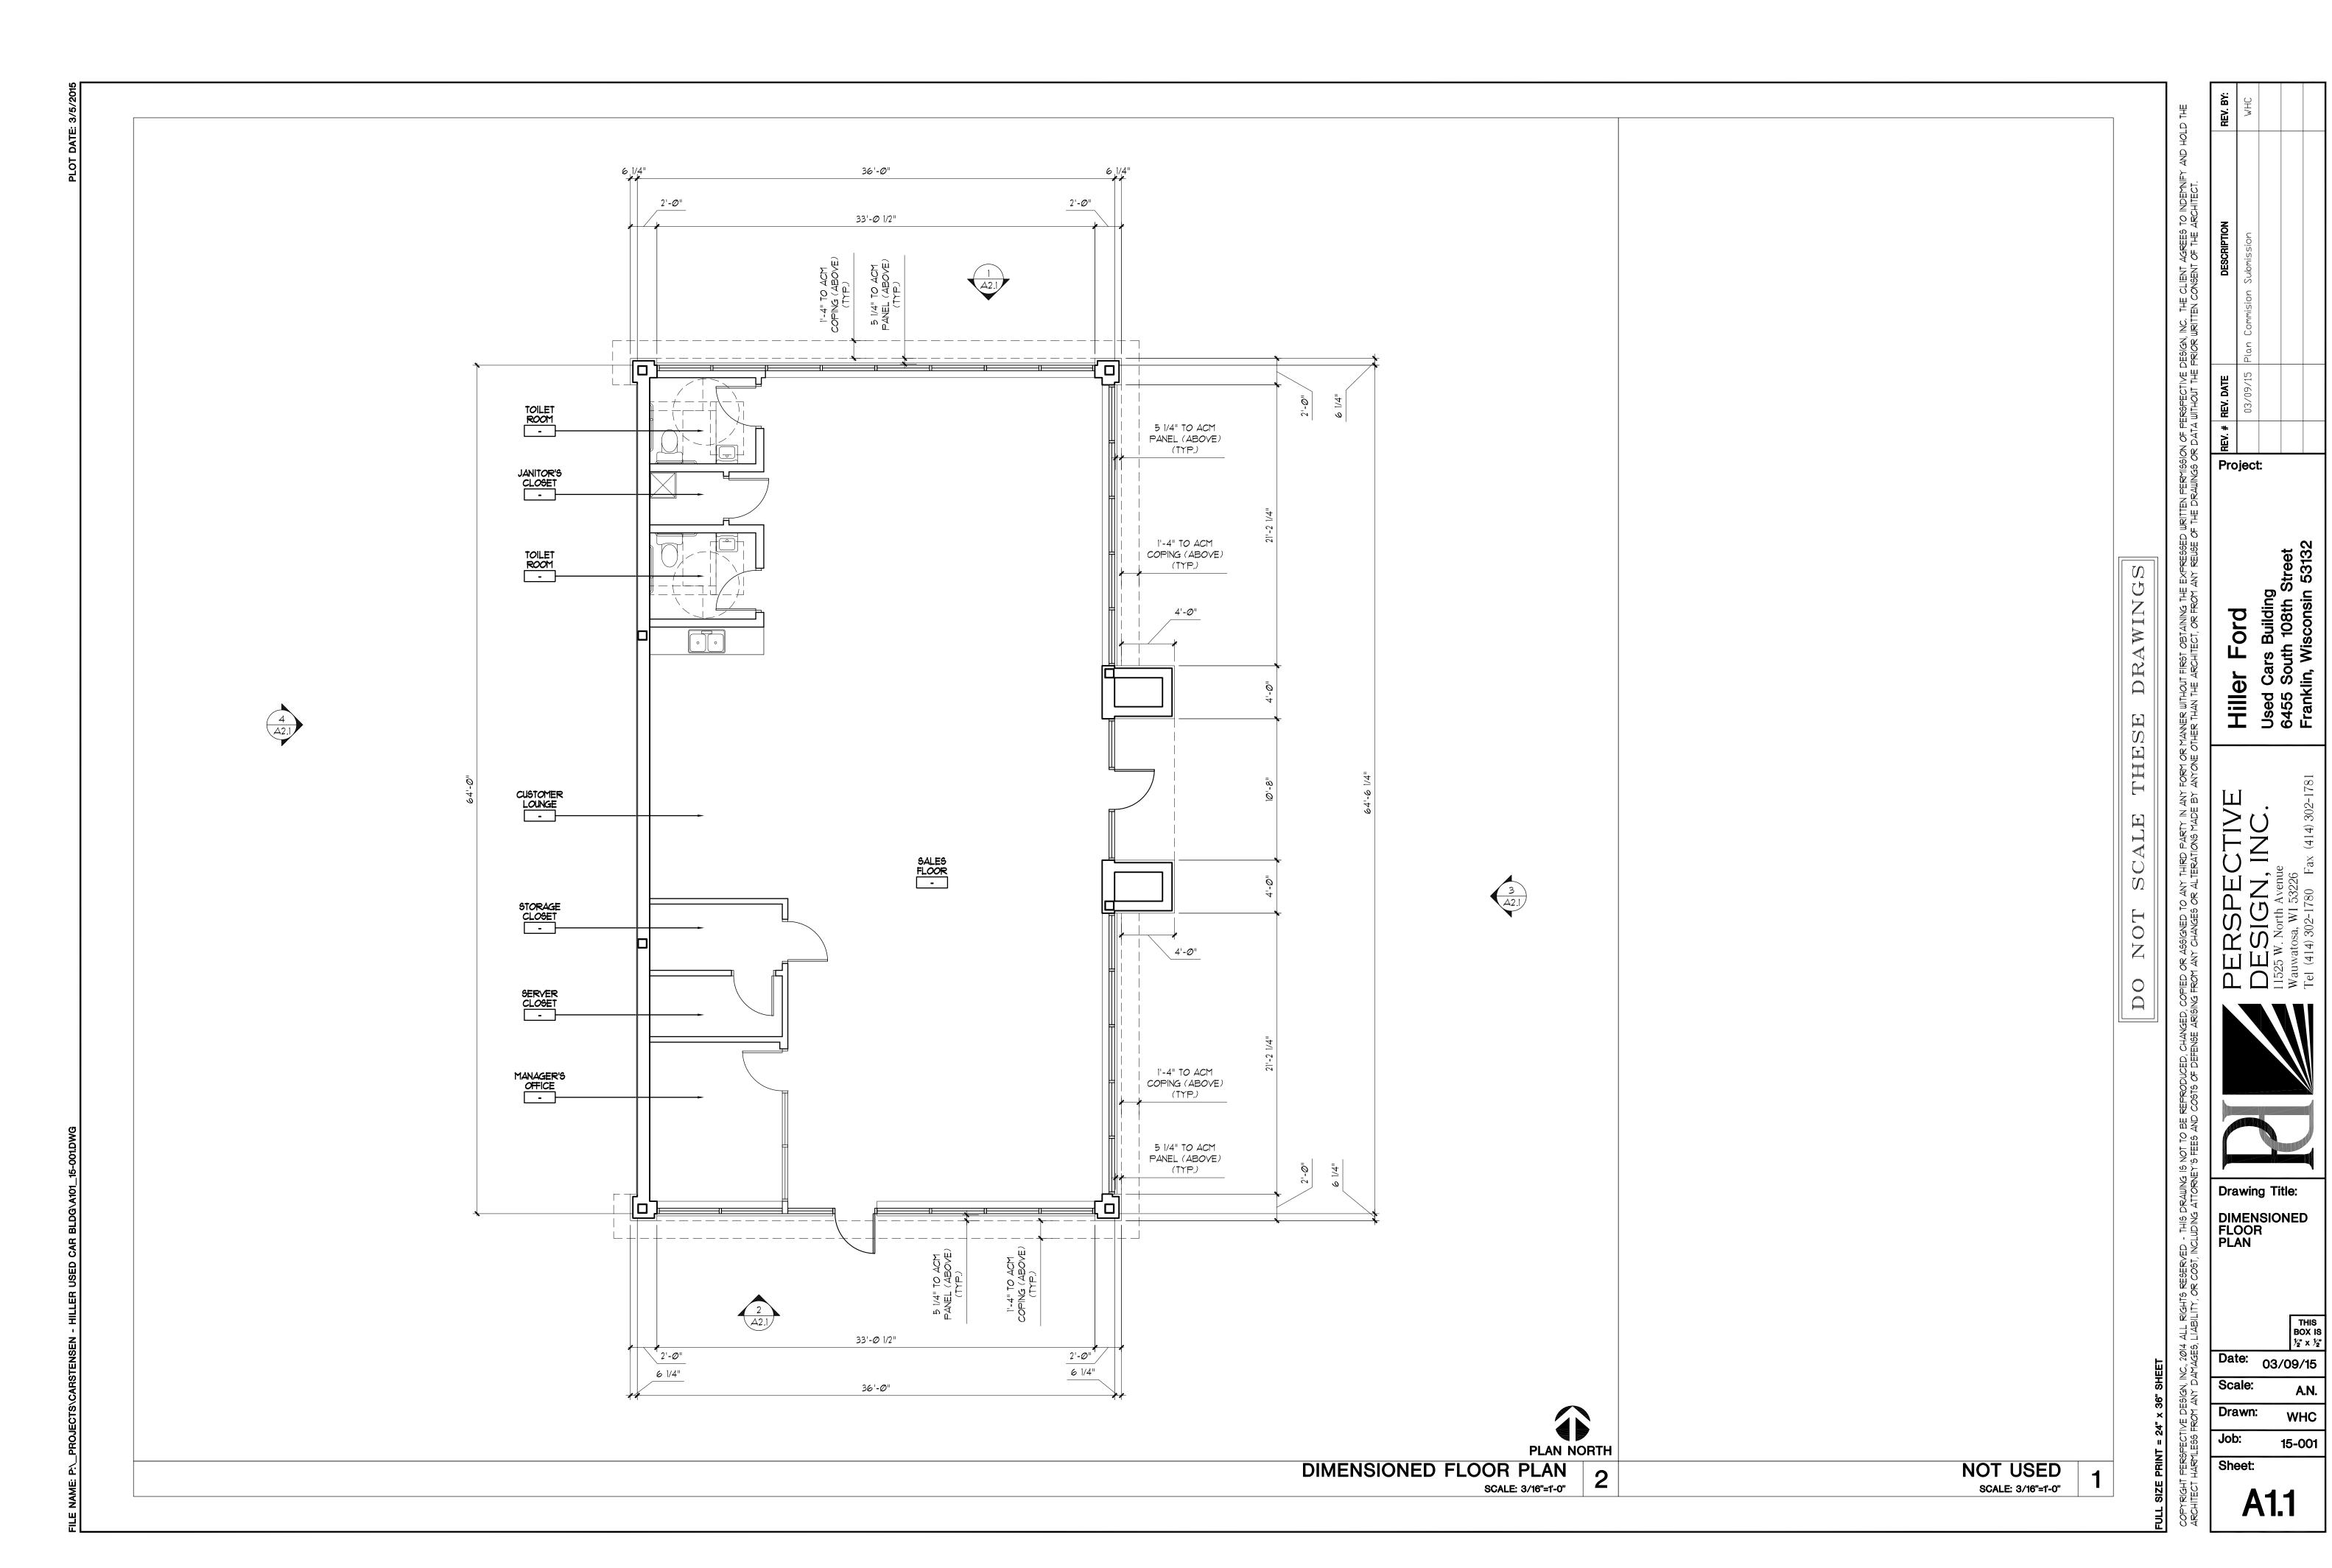

- PRELIMINARY -ESTIMATING AND REVIEW THIS BOX IS ½" x ½"

A.N.

15-001

CONSTRUCTION FOR

Drawing Title: THIS BOX IS 1/2" x 1/2" Date: 03/09/15 Scale: A.N.


Job:

15-001

A1.5

Project:

NOT FOR CONSTRUCTION

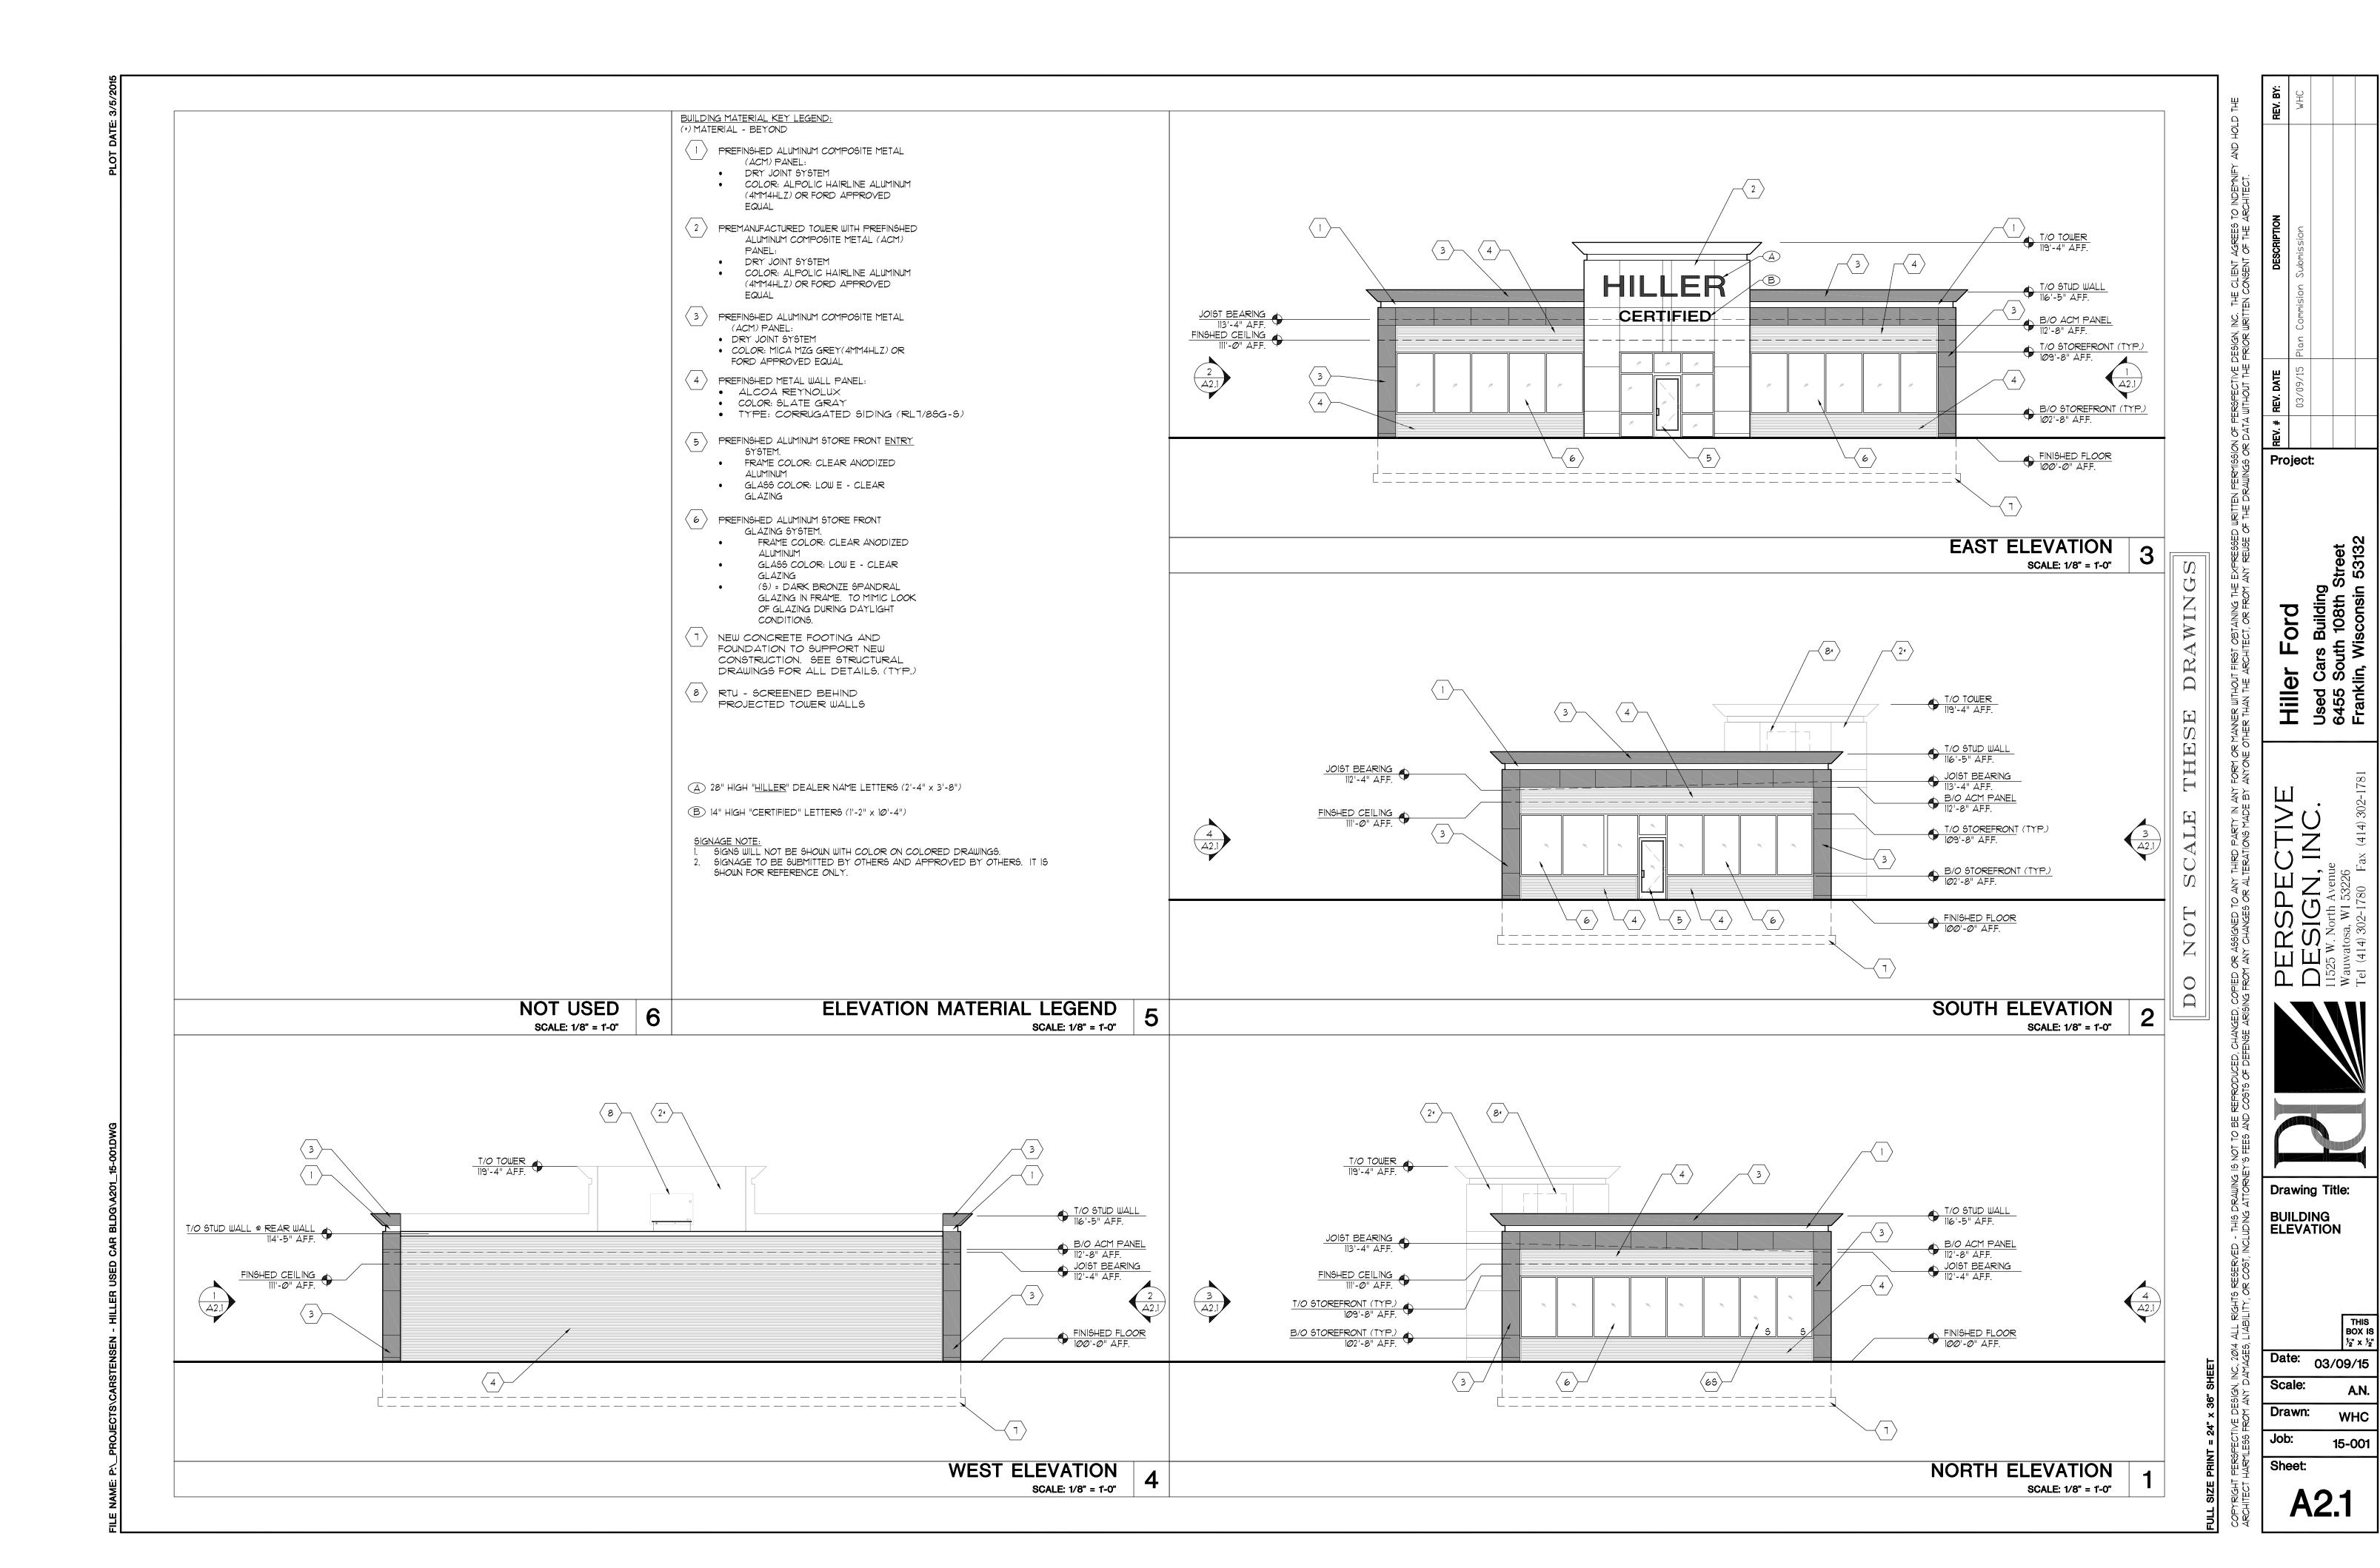

- PRELIMINARY -ESTIMATING AND REVIEW

A.N.

Drawing Title: BUILDING ELEVATION COLOR THIS BOX IS 1/2" x 1/2" Date: 03/09/15

A.N.

WHC

15-001

Drawn:

Sheet:

A2.2

- PRELIMINARY -ESTIMATING AND REVIEW

Project:

Hiller



REPORT TO THE PLAN COMMISSION

Meeting of March 19, 2015

Temporary Use

RECOMMENDATION: City Development Staff recommends approval of the Temporary Use to allow The Home Depot to have outdoor seasonal sales of plant goods and commodity bagged goods from April 17, 2015 through July 15, 2015, upon property located at 6489 South 27th Street, subject to the conditions of approval in the attached resolution.

Project Name: The Home Depot Temporary Use

Project Address: 6489 South 27th Street

Applicant: Home Depot U.S.A., Inc.

Zoning: Planned Development District No. 14

Use of Surrounding Properties: Multi-Family Residential (north and west) Restaurants and Retail

(east) Retail (south)

2025 Comprehensive Plan: Commercial

Applicant Action Requested: Approval of the Temporary Use for outdoor seasonal sales of

plant goods and commodity bagged goods from April 1, 2015, through July 15, 2015, upon property located at 6489 South 27th

Street.

BACKGROUND AND ANALYSIS:

Please note:

• Staff recommendations are underlined, in italics and are included in the draft ordinance.

On April 3, 2014, the Plan Commission granted The Home Depot Temporary Use approval for outdoor seasonal plant sales, upon property located at 6489 South 27th Street. The Plan Commission also granted similar temporary use approvals in 2008, 2009, 2010, 2011, 2012 and 2013.

The applicant has once again submitted an application for a temporary use in Planned Development District (PDD) No. 14 to allow for outdoor seasonal sales of plant goods, and landscape commodity bagged goods. All of the plant goods and commodity bagged goods will be placed within a fenced in corral measuring 120 feet long by 96 feet wide for a total area of 11,520 square feet. The fence will be metal and chain-link in style. The height of the fence will be eight feet which is in conformance with Section 15-3.0803 (C) (2) of the Unified Development Ordinance. The 11,520 square foot corral area is shown on the site plan attached to the letter of intent, City file-stamped March 6, 2015.

PDD No. 14 (Ordinance No. 99-1553) allows for a seasonal display area for outdoor live plant material within a 40,000 square foot area shown on "Exhibit A," with location to be approved on an annual basis by the Plan Commission. Staff finds the location of the proposed outdoor seasonal sales area, as

shown on the site plan, is consistent with the 40,000 square foot area shown on "Exhibit A" of Ordinance No. 99-1553.

Ordinance No. 2005-1858 provides for the administrative issuance of Temporary Use Permits by the Zoning Administrator and designees of the City Planning Department and to further specify the types of and conditions upon temporary uses, which may be permitted. Section 15-3.0804 (A)(4) states that, "Each individual outdoor sales event (up to 4 per year, per property) shall be no longer than 14 consecutive days; provided, however, that the total days of such temporary uses during a calendar year shall not exceed 30 calendar days. Owners must obtain a Temporary Use Permit for each such temporary outdoor sale before the use is permitted." The Home Depot has requested a temporary use lasting longer than 14 consecutive days (106 days total). Therefore, the Department of City Development has referred The Home Depot Temporary Use Application to the Plan Commission.

According to Section 15-3.0804(L) of the City of Franklin Unified Development Ordinance, "Each Temporary Use Permit shall specify the date upon which such use may commence and the date upon which such use shall expire; in no event, except as otherwise specifically and expressly set forth in this Section, shall any temporary use exceed 90 days in duration during any calendar year." <u>Therefore, Staff recommends the outdoor seasonal tree and shrub sales event start no earlier than April 17, 2015, so the temporary use does not exceed 90 days in duration.</u>

STAFF RECOMMENDATION:

City Development Staff recommends approval of the Temporary Use to allow The Home Depot to have outdoor seasonal sales of plant goods and commodity bagged goods from April 17, 2015 through July 15, 2015, upon property located at 6489 South 27th Street, subject to the conditions of approval in the attached resolution.